
PLANS FOR CONSTRUCTION

GOLDEN STATE BOULEVARD - KINGSBURG REGION FROM MISSION ST TO MOUNTAIN VIEW AVE PROJECT LENGTH 3.45 MI.

INDEX OF SHEETS

<u>SHEET</u>	<u>DRAWING</u>	<u>DESCRIPTION</u>
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2	G-1	GENERAL NOTES
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7 TO 8	K-1 TO K-2	KEY MAP
9 TO 11 12 TO 31	PC-1 TO PC-3 L-1 TO L-20	PROJECT CONTROL PLAN AND PROFILE
32 TO 52	CD−1 TO CD−21	CONSTRUCTION DETAILS
53 TO 59	D−1 TO D−7	DRAINAGE PLAN
60	DD−1	DRAINAGE DETAIL
61 TO 62	DP−1 TO DP−2	DRAINAGE PROFILE
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72	CS−1	CONSTRUCTION AREA SIGNS
73 TO 79	SC-1 TO SC-7	STAGE CONSTRUCTION PLANS
80 TO 91	SS-1 TO SS-12	SIGNAGE AND STRIPING PLANS
92 TO 105	E-1 TO E-14	ELECTRICAL PLANS

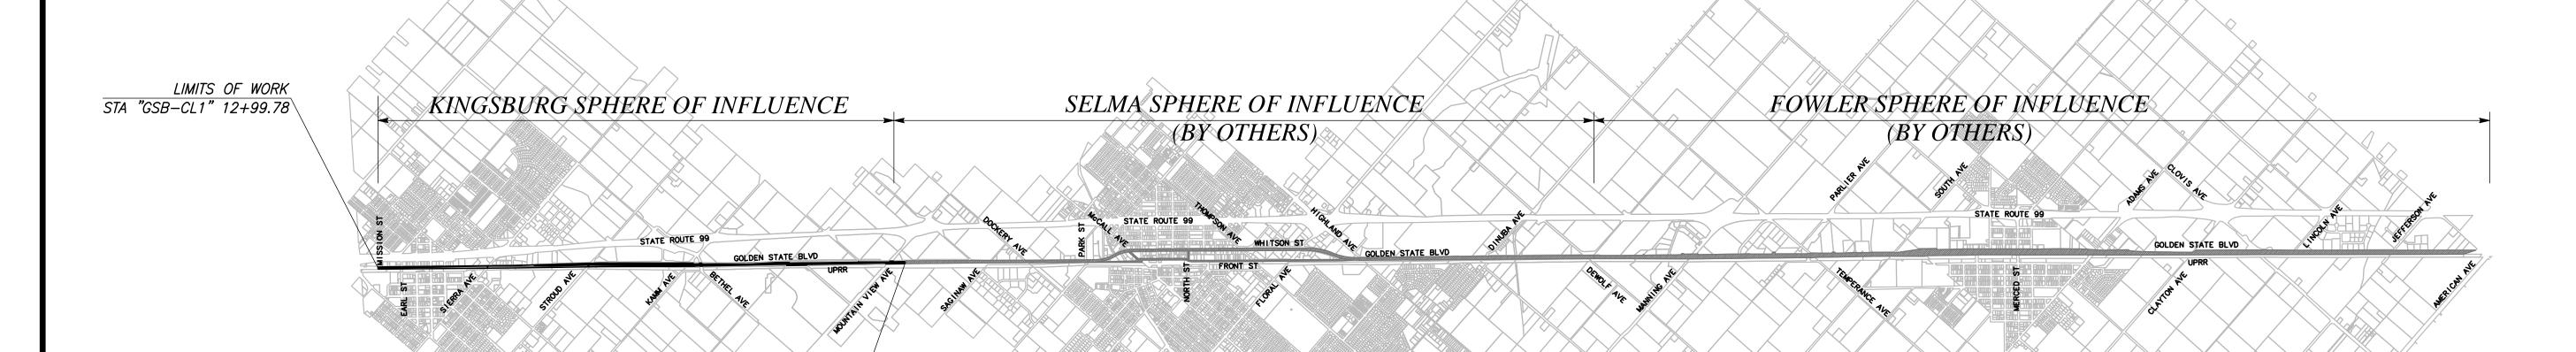

LIMITS OF WORK / STA "GSB-SB2" 196+91.01

Adopted by the County of Fresno Board of Supervisors

			, 20
Brian Pacheco Sal Quintero Andreas Borgeas Buddy Mendes Nathan Magsig	Chairman Vice Chairman	1st 3rd 2nd 4th 5th	District District District District District

APPROVED ___


Steven E. White, Director Department of Public Works, County of Fresno

APPROVED

Department of Public Works, City of Kingsburg

	CONTR	ACTOR'S LICE	NSING REQUIR	EMENIT	
	CL	ASS A, GENER	AL ENGINEERI	NG	
	C	-12, EARTHWC	RK AND PAVIN	IG	
Drawing No.	Road No.	Bridge No.	Fiscal Yr.	Sheet No.	Total
####	XXXXXX	XXXXX	XXXX	1	####
		Contract	No. ####		
		RECORD	DRAWING		
NAME					
ADDRESS					
CITY			STATE	ZIP	
PHONE					
DATE AWARDED					
DATE STARTED					
DATE COMPLETED					
		RESIDENT	ENGINEER		
NAME		SIG	NATURE		

100% SUBMITTAL

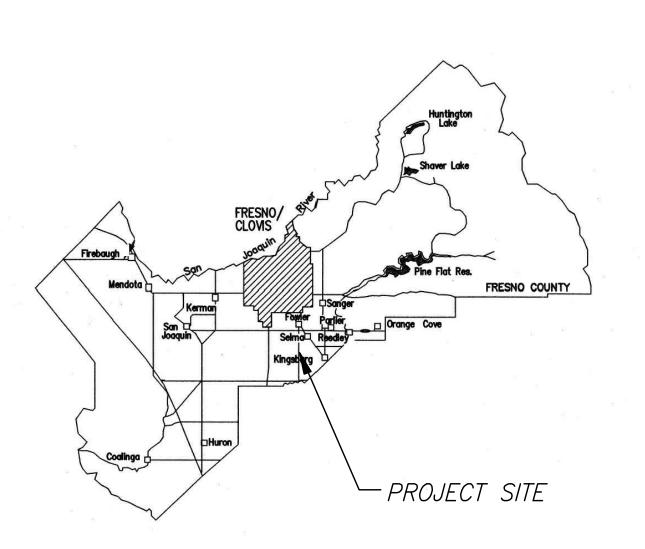

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GSBUR THE STATE OF THE STATE OF

DEPARTMENT OF PUBLIC WORKS AND PLANNING

STANDARD PLANS LIST

 \Box A20A

APPLICABLE 2015 STATE OF CALIFORNIA CALTRANS STANDARD PLANS:

□ A20B TRAFFIC LINES-TYPICAL DETAILS
 □ A20C TRAFFIC LINES-TYPICAL DETAILS
 □ A24A PAVEMENT MARKINGS-ARROWS
 □ A24B PAVEMENT MARKINGS-ARROWS AND SYMBOLS
 □ A24C PAVEMENT MARKINGS-SYMBOLS AND NUMERALS
 □ A24D PAVEMENT MARKINGS-WORDS

TRAFFIC LINES-TYPICAL DETAILS

☐ A24D PAVEMENT MARKINGS—WORDS
☐ A24E PAVEMENT MARKINGS—WORDS, LIMIT
AND YIELD LINES

□ A87A CURBS AND DRIVEWAYS
□ A87B HOT MIX ASPHALT DIKES
□ D74B DRAINAGE INLETS—TYPE GO INLET
□ D77A GRATE DETAILS NO.1

□ D77B GRATE DETAILS NO.2
□ D94B CONCRETE FLARED END SECTIONS
□ RS1 SIGNS—TYPICAL INSTALLATION DETAILS NO.1
□ RS2 SIGNS—WOOD POST—TYPICAL INSTALLATION

DETAILS NO.2

SIGNS—LAMINATED WOOD BOX POST—TYPICAL INSTALLATION DETAILS NO.3

□ RS4 SIGNS—TYPICAL INSTALLATION DETAILS NO.4

APPLICABLE 2014 COUNTY OF FRESNO STANDARD PLANS:

☐ ST40 TYPE A CURB & GUTTER
☐ ST42 CROSSWALK
☐ ST55 PARALLEL PARKING

APPLICABLE 2009 CITY OF KINGSBURG STANDARD PLANS:

□ D−1 CURB INLET
□ D−4 MANHOLE TYPE

 \square D-4 MANHOLE TYPE A \square D-5 MANHOLE FRAME AND COVER

E-1 STREETLIGHT-MAJOR ST WITH BASE, PULL BOX
& PVC CONDUIT

STREETLICHT-LOCAL ST NO BASE NO BULL BOY

□ E-2 STREETLIGHT-LOCAL ST NO BASE, NO PULL BOX & PVC CONDUIT

□ E-3 STREETLIGHTS CONCRETE PULL BOXES
□ E-4 STREETLIGHT CONNECTION DIAGRAM

□ E-4 STREETLIGHT CONNECTION DIAGRAM
 □ E-5 STREETLIGHT LAYOUT
 □ E-6 STREETLIGHTS-PLACEMENT DIVIDED ARTERIAL ST

□ E−7 STREETLIGHTS−PLACEMENT DIVIDED ARTERIAL ST □ E−7 STREETLIGHTS−PLACEMENT COLLECTOR ST □ E−8 STREETLIGHTS−PLACEMENT LOCAL ST □ E−9 STREETLIGHTS−PLACEMENT CUL−DE−SAC ST

□ E−9 STREETLIGHTS−PLACEMENT CUL−DE−SAC ST □ E−10 STREETLIGHTS−PLACEMENT ARTERIAL INTERSECTION □ E−11 STREETLIGHTS FOUNDATION WIRE−WAY

□ E−12 STREETLIGHT POLE NUMBERING □ E−13 STREETLIGHT WIRING □ E−14 SIGNAL & STREETLIGHT COMBINATION WIRING

□ E−15 DECORATIVE LIGHTING
□ ST−9 8" MEDIAN CURB
□ ST−18 STREET NAME SIGN

☐ ST-24 6" CURB & GUTTER, SIDEWALK
☐ ST-26 COMMERCIAL DRIVEWAY

☐ ST-20 COMMERCIAL DRIVEWAT
☐ ST-30 CURB RAMP DETAILS AND GROOVES
☐ ST-46 VALLEY GUTTER

□ M−7 6' CHAIN LINK FENCE
□ M−8 6' CHAIN LINK FENCE
□ M−9 6' CHAIN LINK FENCE
□ W−9 BLUE PAVEMENT MARKERS

GENERAL NOTES

1. THE WORK EMBRACED HEREIN SHALL BE DONE IN ACCORDANCE WITH THE APPROPRIATE PROVISIONS OF THE SPECIFICATIONS ENTITLED CITY OF KINGSBURG, IMPROVEMENT STANDARDS, LATEST EDITION, INSOFAR AS THE SAME MAY APPLY, WHICH SPECIFICATIONS HEREINAFTER ARE REFERRED TO AS THE STANDARD SPECIFICATION.

P. TWO WORKING DAYS PRIOR TO COMMENCING EXCAVATION, THE CONTRACTOR SHALL NOTIFY UNDERGROUND SERVICES ALERT, TOLL FREE, AT 1-800-227-2600 OR 811.

S. CONTRACTOR SHALL PROVIDE THE ENGINEER WITH A COPY OF AN OWNER'S WRITTEN AUTHORIZATION AND/OR SIGNED USE AGREEMENT PRIOR TO THE START OF WORK FOR ANY TEMPORARY WORK AREA, STANDING AREA, OR EQUIPMENT STORAGE FACILITIES TO BE USED FOR THIS PROJECT. AT THE COMPLETION OF WORK, THE CONTRACTOR SHALL PROVIDE THE ENGINEER WITH A COPY OF A WRITTEN RELEASE LETTER STATING THAT ALL TEMPORARY USES FACILITIES HAVE BEEN RESTORED BACK TO THE OWNER'S SATISFACTION.

4. CONTRACTOR SHALL DETERMINE THE EXACT LOCATION OF ALL UNDERGROUND FACILITIES AND PROVIDE PROTECTION PRIOR TO AND DURING CONSTRUCTION.

5. IN THE EVENT OVERHEAD ELECTRICAL LINES EXIST WITHIN THE LIMITS OF CONSTRUCTION, MAINTAIN PROPER CLEARANCE. CONTACT PG&E TO VERIFY WIRE LOCATION.

6. THE SANITARY SEWER SYSTEM AND HOUSE CONNECTIONS, TOGETHER WITH WATER MAIN, GAS MAINS, AND THEIR RESPECTIVE SERVICE CONNECTIONS SHALL BE COMPLETE IN THE STREET BEFORE INSTALLATION OF THE STREET SURFACING.

7. INSTALL SIDEWALKS, CURBS, AND GUTTERS AS PER CITY OF KINGSBURG 2009 STANDARD DRAWINGS ST—24 AND IN ACCORDANCE WITH DETAILS ON THESE DRAWINGS. CURBS AND GUTTERS SHALL BE CONSTRUCTED BEFORE PLACING THE STREET SURFACING AND BASE COURSE.

8. PERMITS MUST BE OBTAINED AND FEES PAID IN ACCORDANCE WITH ORDINANCES OF THE CITY OF KINGSBURG.

THE TYPICAL CROSS SECTION SHOWN SHALL BE USED ONLY FOR THE PAVEMENT STRUCTURAL SECTION, OVERLAY THICKNESS AND SIDE SLOPES. SEE PLAN AND PROFILE SHEETS FOR HORIZONTAL LIMITS AND LOCATIONS OF CURB AND GUTTER, MEDIAN ISLANDS, SAWCUTTING, GRINDING, OVERLAYS, SIDEWALKS, FENCES, R/W LINES, EXISTING FEATURES, AND ANY OTHER PROPOSED IMPROVEMENTS. THE TYPICAL CROSS SECTION SHOULD NOT BE USED FOR STALKING OF PROPOSED IMPROVEMENTS.

10. ALL STREETS SHALL BE SURFACED IN ACCORDANCE WITH THIS PLAN AND THE FOLLOWING SPECIFICATIONS:

A. 6-INCH SUBGRADE AND ALL FILLS IN EXCESS OF 6 INCHES WILL BE COMPACTED IN ACCORDANCE WITH THE STATE OF CALIFORNIA, DEPARTMENT OF TRANSPORTATION, SECTION 19 OF THE STANDARD SPECIFICATIONS, 2015.

B. AGGREGATE BASE SHALL CONFORM TO AND BE PLACED IN ACCORDANCE WITH SECTION 11 OF THE CITY OF

KINGSBURG STANDARDS SPECIFICATIONS, USING CLASS 2 AGGREGATE BASE (MINIMUM 50 R—VALUE). C. PAINT BINDER WILL BE AS SPECIFIED BY THE CITY ENGINEER AND SHALL CONFORM TO AND BE APPLIED IN

ACCORDANCE WITH SECTION 11 OF THE CITY OF KINGSBURG STANDARD SPECIFICATIONS.

D. ASPHALT CONCRETE SURFACING SHALL BE TYPE A USING PG 64-10 PENETRATION ASPHALT, CONFORMING TO AND PLACED IN ACCORDANCE WITH SECTION 11 OF THE CITY OF KINGSBURG STANDARD SPECIFICATIONS.

12. ALL BOUNDARY STREETS SHALL BE CONSTRUCTED IN ACCORDANCE WITH THIS PLAN.
A. THE TRANSITION BETWEEN THE EDGE AND END OF THE REQUIRED STREET SURFACING AND THE EXISTING
SURFACING OR GROUND SHALL NOT HAVE A SLOPE STEEPER THAN 5 PERCENT, OR OTHERWISE APPROVE BY THE

13. INSTALL STREET LIGHTING SYSTEM IN ACCORDANCE WITH RESOLUTION No. 78-522 AND 88-229. LOCATION OF LIGHTS TO BE DETERMINED AND APPROVED BY THE TRAFFIC ENGINEER, SERVICE LOCATION TO BE DETERMINED BY PG&E. THE STREETLIGHTS SHALL BE INSTALLED IN ACCORDANCE WITH CITY OF KINGSBURG WORKS IMPROVEMENT STANDARDS E-1 THROUGH E-15. OR AS MODIFIED BY THESE PLANS.

14. TRAFFIC REQUIREMENTS:

CITY ENGINEER.

A. ALL SIGNING, DETOURING, AND BARRICADING SHALL CONFORM TO THE CALIFORNIA SUPPLEMENT TO THE MANUAL OF UNIFORM TRAFFIC CONTROL DEVICES DATED 2014, ISSUED BY THE STATE OF CALIFORNIA, DEPARTMENT OF TRANSPORTATION.

B. ALL SIGNS SHALL BE RETROFLECTIVE PER CHAPTER 2A.08 OF THE 2014 MUTCD.

C. HIGH LEVEL WARNING DEVICES SHALL BE USED ON ALL APPROACHES TO THE CONSTRUCTION AREA.

D. ONE (1) 11—FOOT DRIVING LANE MUST BE MAINTAINED IN EACH DIRECTION AT ALL TIMES. E. NO PUBLIC STREET SHALL BE CLOSED WITHOUT PRIOR APPROVAL FROM THE CITY TRAFFIC ENGINEER. 16. EXISTING PAVEMENT SHALL NOT BE REMOVED UNTIL SUCH A TIME AS ALL UTILITIES ARE COMPLETED AND PAVING CONTRACTOR IS READY TO REPAIR WITHIN 5 DAYS.

17. ALL STORM DRAINAGE FACILITIES ARE TO BE COMPLETED PRIOR TO START OF STREET WORK AND IN ACCORDANCE WITH CITY OF KINGSBURG, 2009, IMPROVEMENT STANDARD.

18. CONSTRUCT WHEELCHAIR RAMPS AND FINISH RAMP SURFACES AS DIRECTED BY ENGINEER.

19. ALL SEWER MANHOLES AFFECTED BY THIS PROJECT SHALL BE ADJUSTED TO GRADE AS NECESSARY AND INCLUDED IN THIS WORK.

20. ALL EXISTING WATER MAIN VALVES (CAP AND LID) SHALL BE ADJUSTED TO GRADE AS NECESSARY AND INCLUDED IN THIS WORK.

21. INITIAL COMPACTION TESTS SHALL BE PAID FOR BY THE ENGINEER, ANY REQUIRED RETESTS SHALL BE PAID FOR BY THE CONTRACTOR.

UTILITY CONTACT TABLE

UTILITY	COMPANY	REPRESENTATIVE	PHONE NUMBER/EMAIL
CITY	CITY OF KINGSBURG		
ELECTRIC	PG&E	GARLAND TEANEY	559-263-5690
ELECTRIC	SOUTHERN CALIFORNIA EDISON		
GAS	PG&E	ED WONG	530-401-3437
GAS	SOUTHERN CALIFORNIA GAS	AMY PENA	559-739-2308
GAS	PHILLIPS 66	LEO MARTINEZ	1-805-226-2656
GAS	KINDER MORGAN	KARLY PAYNE	714-560-4604
COMMUNICATION	COMCAST	MICHAEL CORRAL	
COMMUNICATION	SPRINT	RICHARD WOLF	925-380-2534
COMMUNICATION	VAST	DAVID DOUGLAS	559-554-9105
COMMUNICATION	LEVEL 3	CALEB KING	
COMMUNICATION	CENTURYLINK-QWEST (LUMEN)	BRETT HANKINS	916-788-1041
COMMUNICATION	VERIZON	JOHN BACHELDER	
COMMUNICATION	AT&T	TIM ANDREAS	559-269-2578
COMMUNICATION	AT&T CALIFORNIA	DAWN SIBLEY	559-454-3367
COMMUNICATION	SEBASTIAN	BOB PATRICK	bpatrick@sebastiancorp.com
WATER	CALWATER	STEPHEN JOHNSON	559-896-3417
WATER	CID		
WATER	KRCD	RICK HOELZEL	559-237-5567
SEWER	SKF	FRANK HERNANDEZ	


AGENCY CONTACT TABLE

AGENCY	CONTACT PERSON	ADDRESS	PHONE NUMBER
CITY OF KINGSBURG	DAVE PETERS	1401 DRAPER STREET KINGSBURG, CA 93631	559-299-1544
COUNTY OF FRESNO	MOHAMMAD ALIMI	2220 TULARE STREET, 7th FLOOR FRESNO, CA 93721	559-600-4505
FRESNO COG	PEGGY ARNEST	2035 TULARE STREET, SUITE 201 FRESNO, CA 93721	559-724-9218

	DATE	RECORD DRAWING		
DESIGNED:		RESIDENT ENGINEER	DATE	
DRAWN:				1
CHECKED:				'
FOR RIGHT OF WAY DATA AND ACCURATE ACCESS D	ETERMINATION, SE	E DOCUMENTS IN THE DEPARTMENT OF PUBLIC WORKS AND PLANN	NING.	C





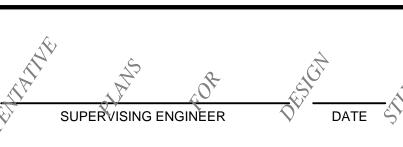





PROJECT

KINGSBURG REGION

GSBUP - WEDSH VILLAGED IN THE DELLAGED IN THE

DEPARTMENT OF PUBLIC WORKS AND PLANNING

GENERAL NOTES

DRAWING NO. G-1 SHEET NO. 2 TOTAL 105

NOTES:

- 1. FOR ACCURATE RIGHT OF WAY DATA, CONTACT RIGHT OF WAY ENGINEERING AT THE DISTRICT OFFICE.
- 2. DIMENSIONS OF THE STRUCTURAL SECTIONS ARE SUBJECT TO TOLERANCES SPECIFIED IN THE STANDARD SPECIFICATIONS.
- 3. FOR CURB/DIKE LIMITS, SEE PLAN AND PROFILE SHEETS.
- 4. SUPERELEVATION AS SHOWN OR AS DIRECTED BY THE ENGINEER.
- 5. COMPACT SUBGRADE TO 95% RELATIVE COMPACTION TO 2.5 FEET BELOW PAVEMENT SURFACE OR 0.5 FEET BELOW SUBGRADE SURFACE, WHICHEVER IS GREATER.
- 6. FOR DITCH FLOW LINE INFORMATION, SEE DRAINAGE SHEETS.
- 7. FOR PAVEMENT AREAS NOT SHOWN, SEE CONSTRUCTION DETAIL SHEETS FOR PAVEMENT SECTIONS.

EXISTING SECTIONS

- 5"-9.5" HMA 4"-8" PCC
- 2 1"-2" HMA 9" PCC
- 7" HMA (3) 3"-6" CTB 7"-8" PCC
- (4) 8"-8.5" PCC

0.18' HMA

0.30' CIPR

SAMI-R

0.20' GRIND

PROPOSED SECTIONS

0.20' HMA OVERLAY

5 XX" HMA

BACK OF WALK CURB AND GUTTER COLD IN PLACE RECYCLING CITY OF KINGSBURG CEMENT TREATED BASE **EXISTING** EDGE OF PAVEMENT HOT MIX ASPHALT HINGE POINT LIP OF GUTTER

0.45° HMA 0.95' AGGREGATE BASE (CLASS II)

1.05' AGGREGATE BASE (CLASS II)

0.65' AGGREGATE BASE (CLASS II)

0.95' AGGREGATE BASE (CLASS II)

0.25' GRIND 0.25' HMA SAMI-R

0.18' HMA OVERLAY SAMI-R

0.33' PCC

0.20' GRIND CRACK AND SEAT EXISTING CONCRETE SAMI-R

0.65' AGGREGATE BASE (CLASS II)

ABBREVIATIONS

NOT TO SCALE ORIGINAL GRADE

PORTLAND CEMENT CONCRETE RIGHT OF WAY

STRESS ABSORBING MEMBRANE INTERLAYER REINFORCEMENT

SIDEWALK TOP FACE OF CURB UNION PACIFIC RAILROAD


OG -______ Exist SW TO REMAIN-Exist C&G TO REMAIN

34'-77'±


Exist Exist
BOW 9'± TFC

SIMPSON STREET

"GSB-CL1" LINE STA 52+62.20 TO 53+34.12 NTS

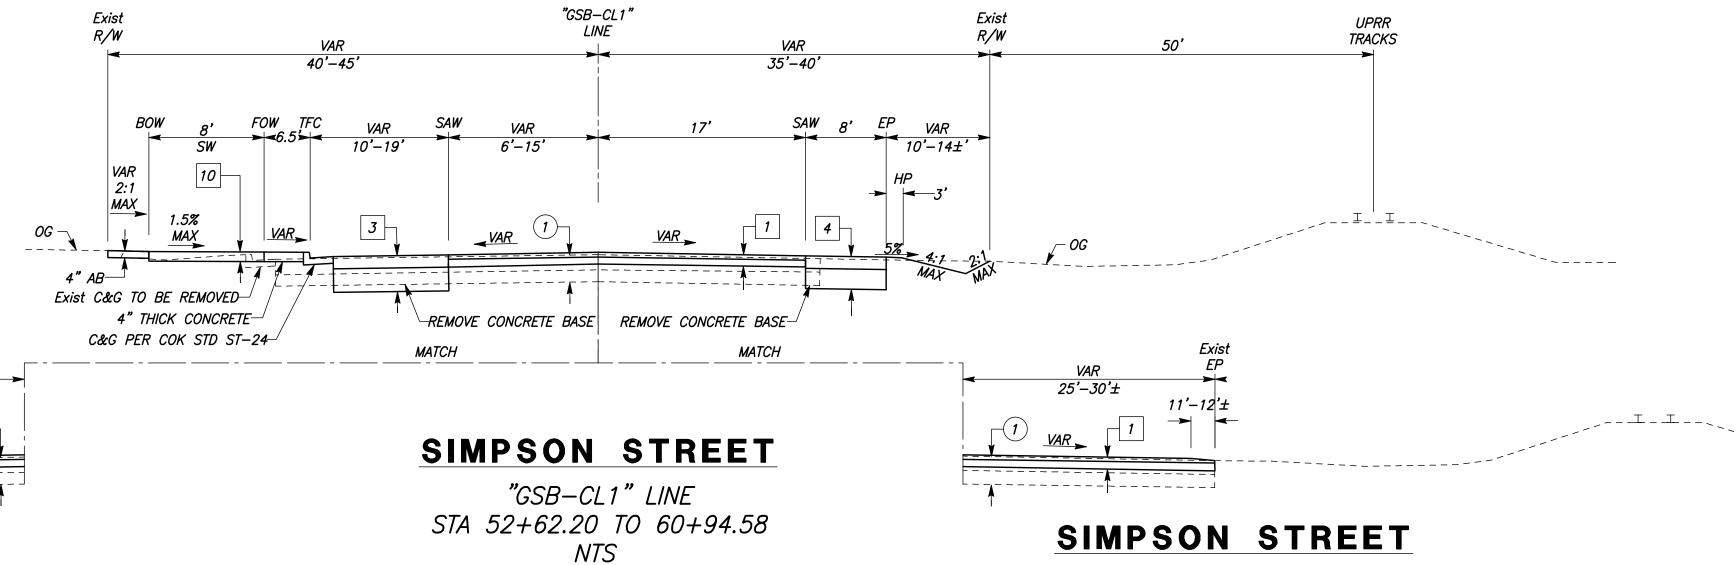

"GSB-CL1" LINE STA 52+62.20 TO 54+30.64 NTS

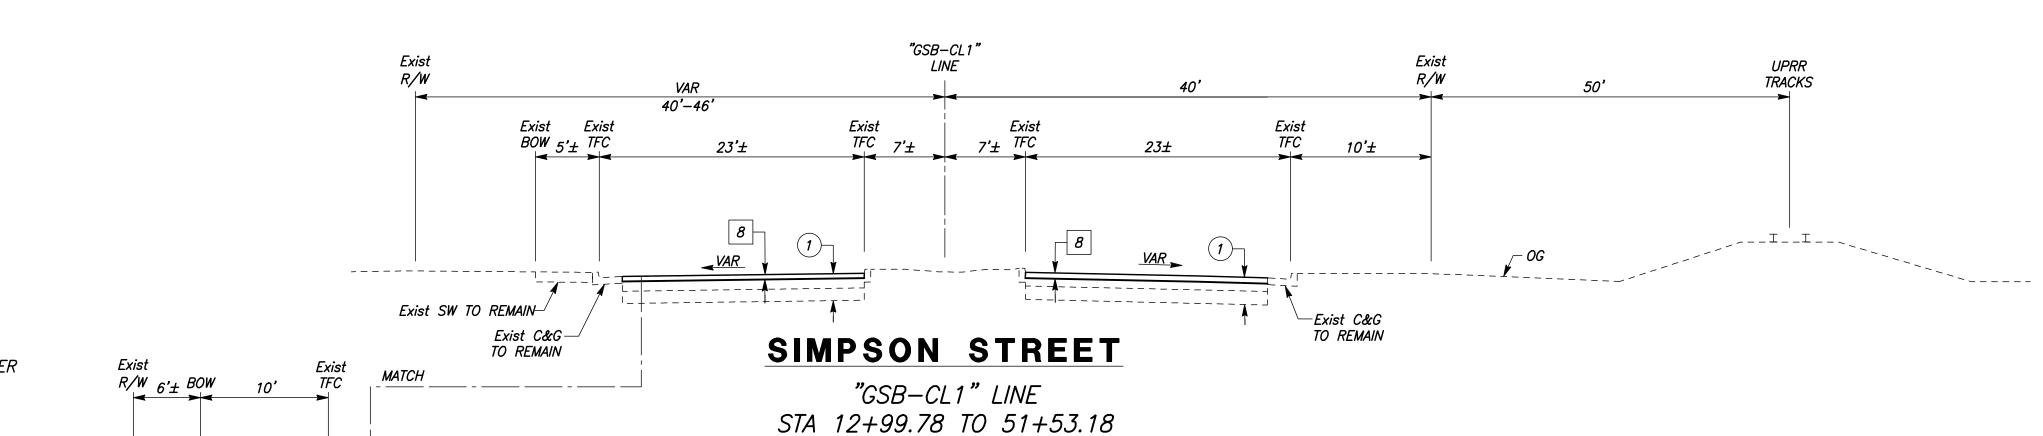

NTS

SIMPSON STREET


SW PER COK STD ST-24-

"GSB-CL1" LINE STA 46+74.71 TO 48+81.52 NTS

	DATE	RECORD DRAWING	
DESIGNED: CYNTHIA HORNER		RESIDENT ENGINEER	DATE
DRAWN: DEREK MAXWELL			
CHECKED: JAMES POLFER			
FOR RIGHT OF WAY DATA AND ACCURATE ACCESS	DETERMINATION, SE	E DOCUMENTS IN THE DEPARTMENT OF PUBLIC WORKS AND PLAN	NING.





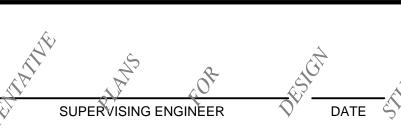



GOLDEN STATE CORRIDOR - ECONOMIC DEVELOPMENT AND INFRASTRUCTURE IMPROVEMENTS KINGSBURG REGION


PROJECT





DEPARTMENT OF PUBLIC WORKS AND PLANNING


TYPICAL SECTIONS


DRAWING NO. X-1 TOTAL 105 SHEET NO. 3

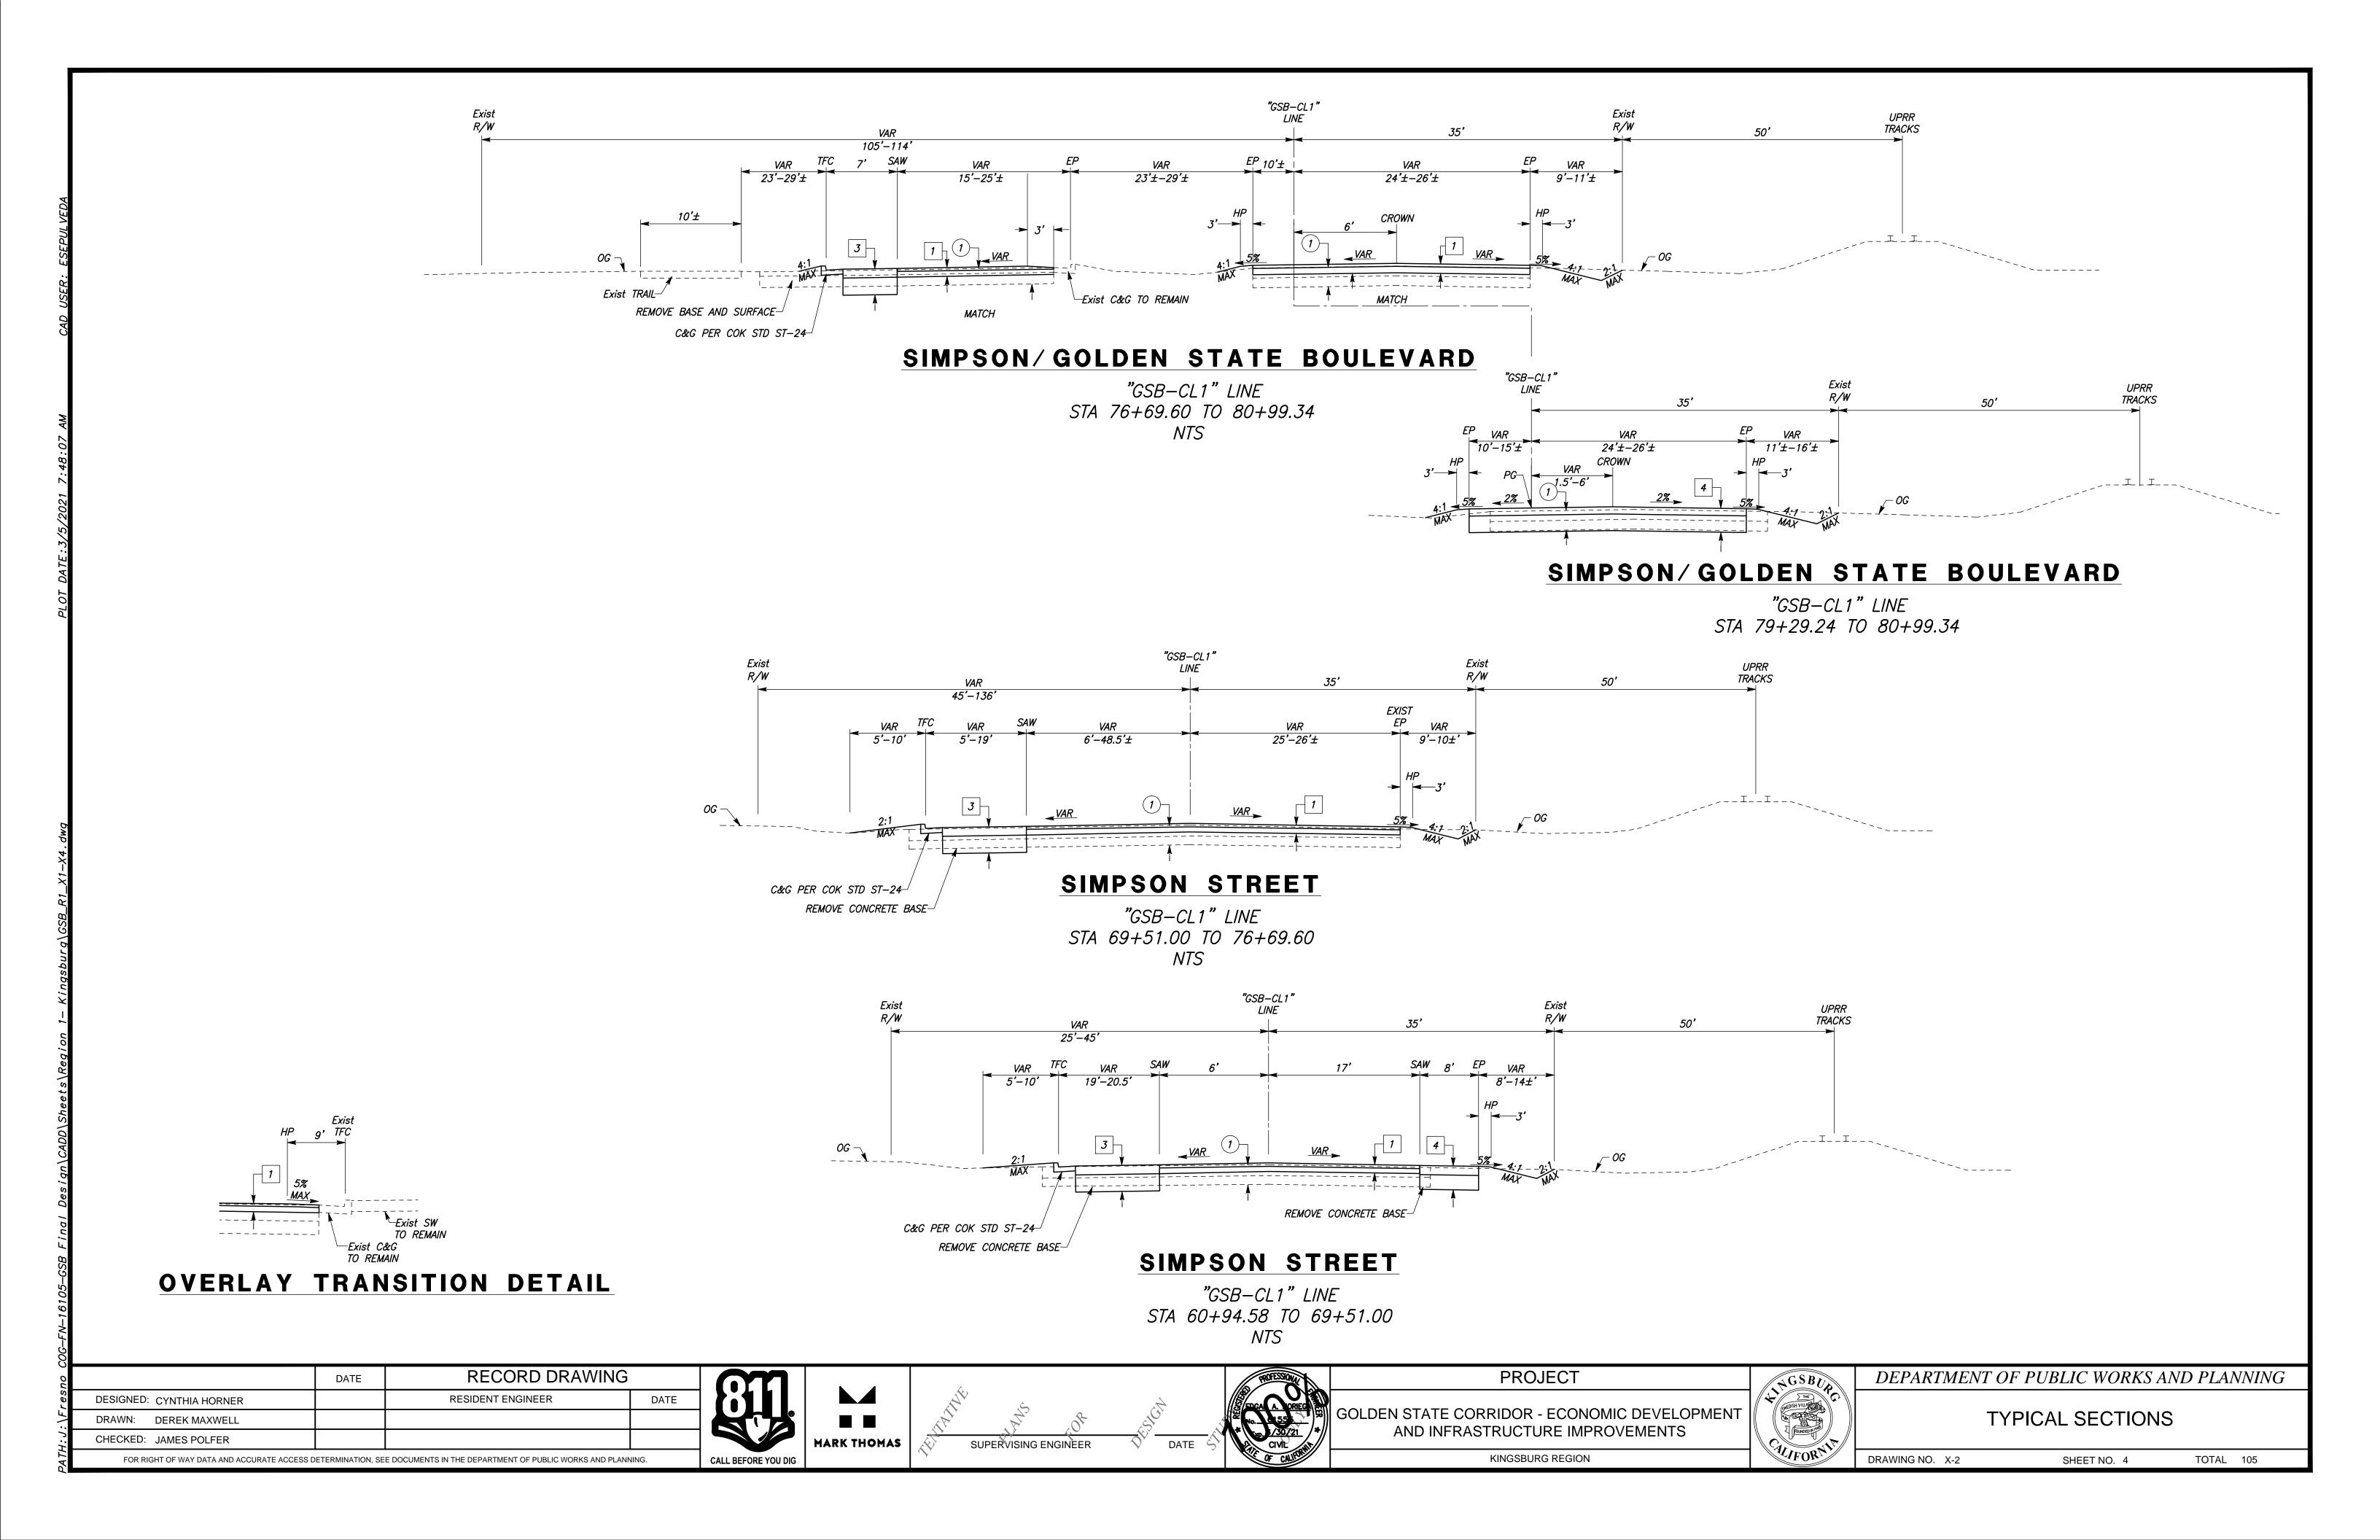


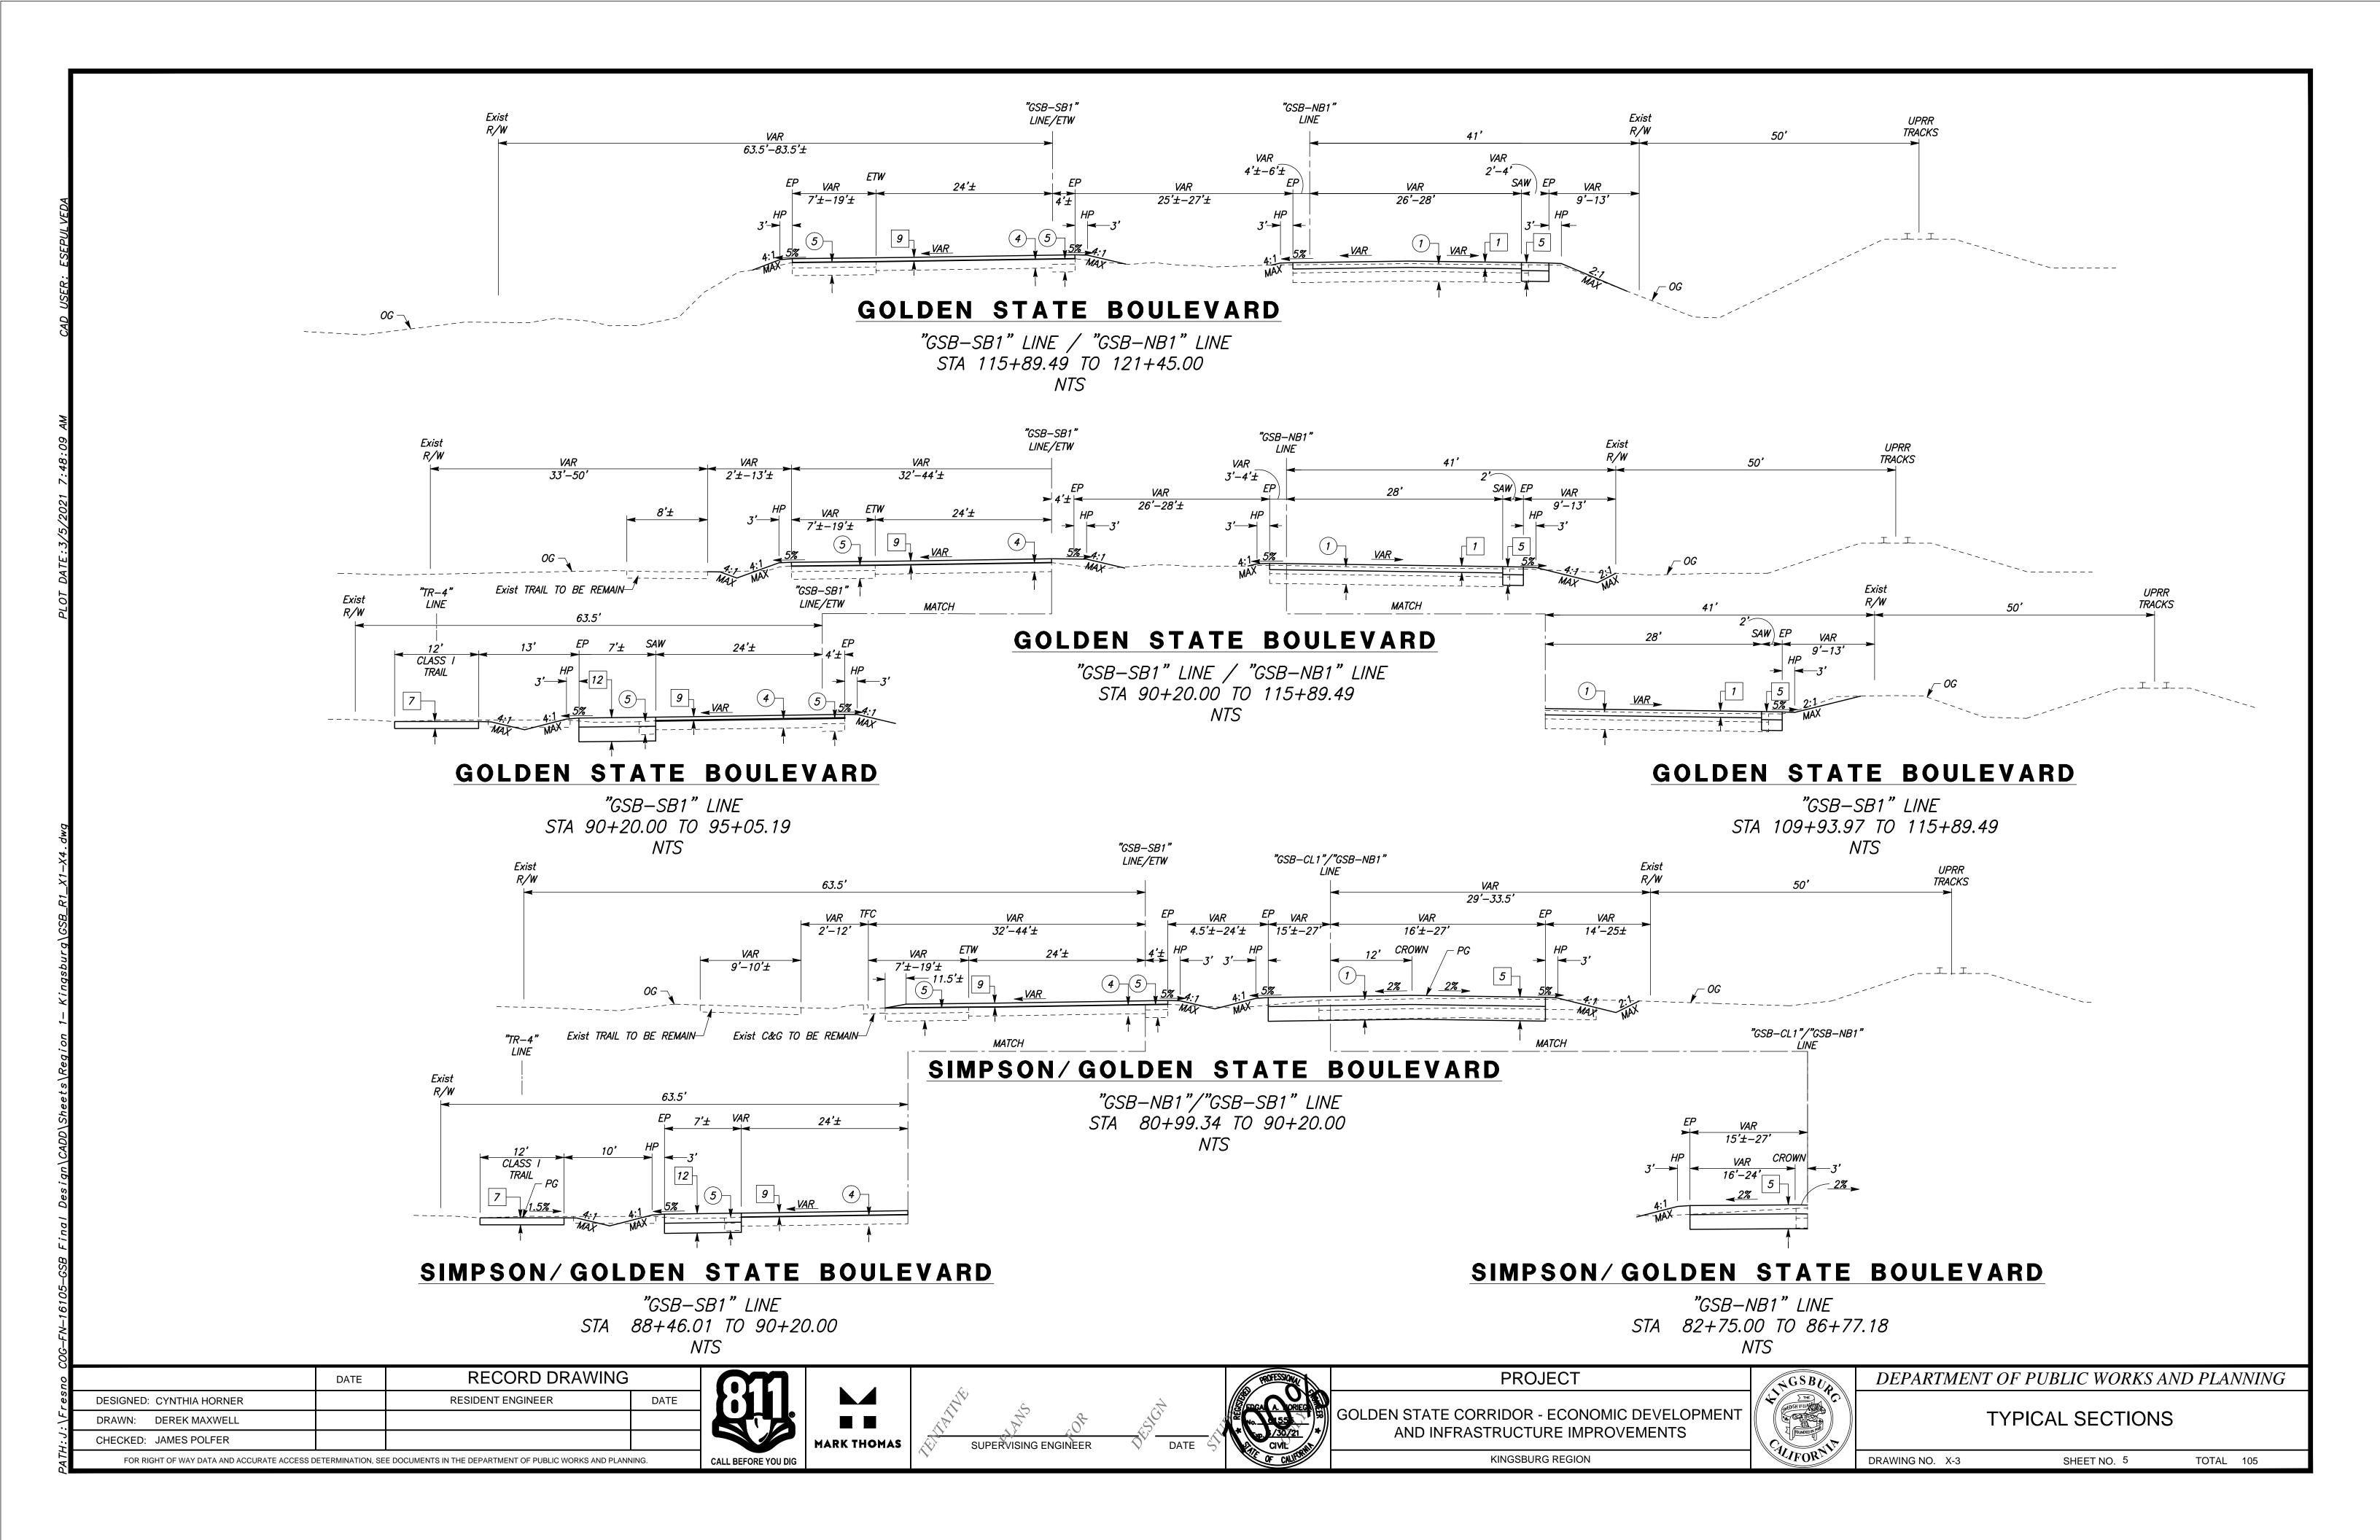


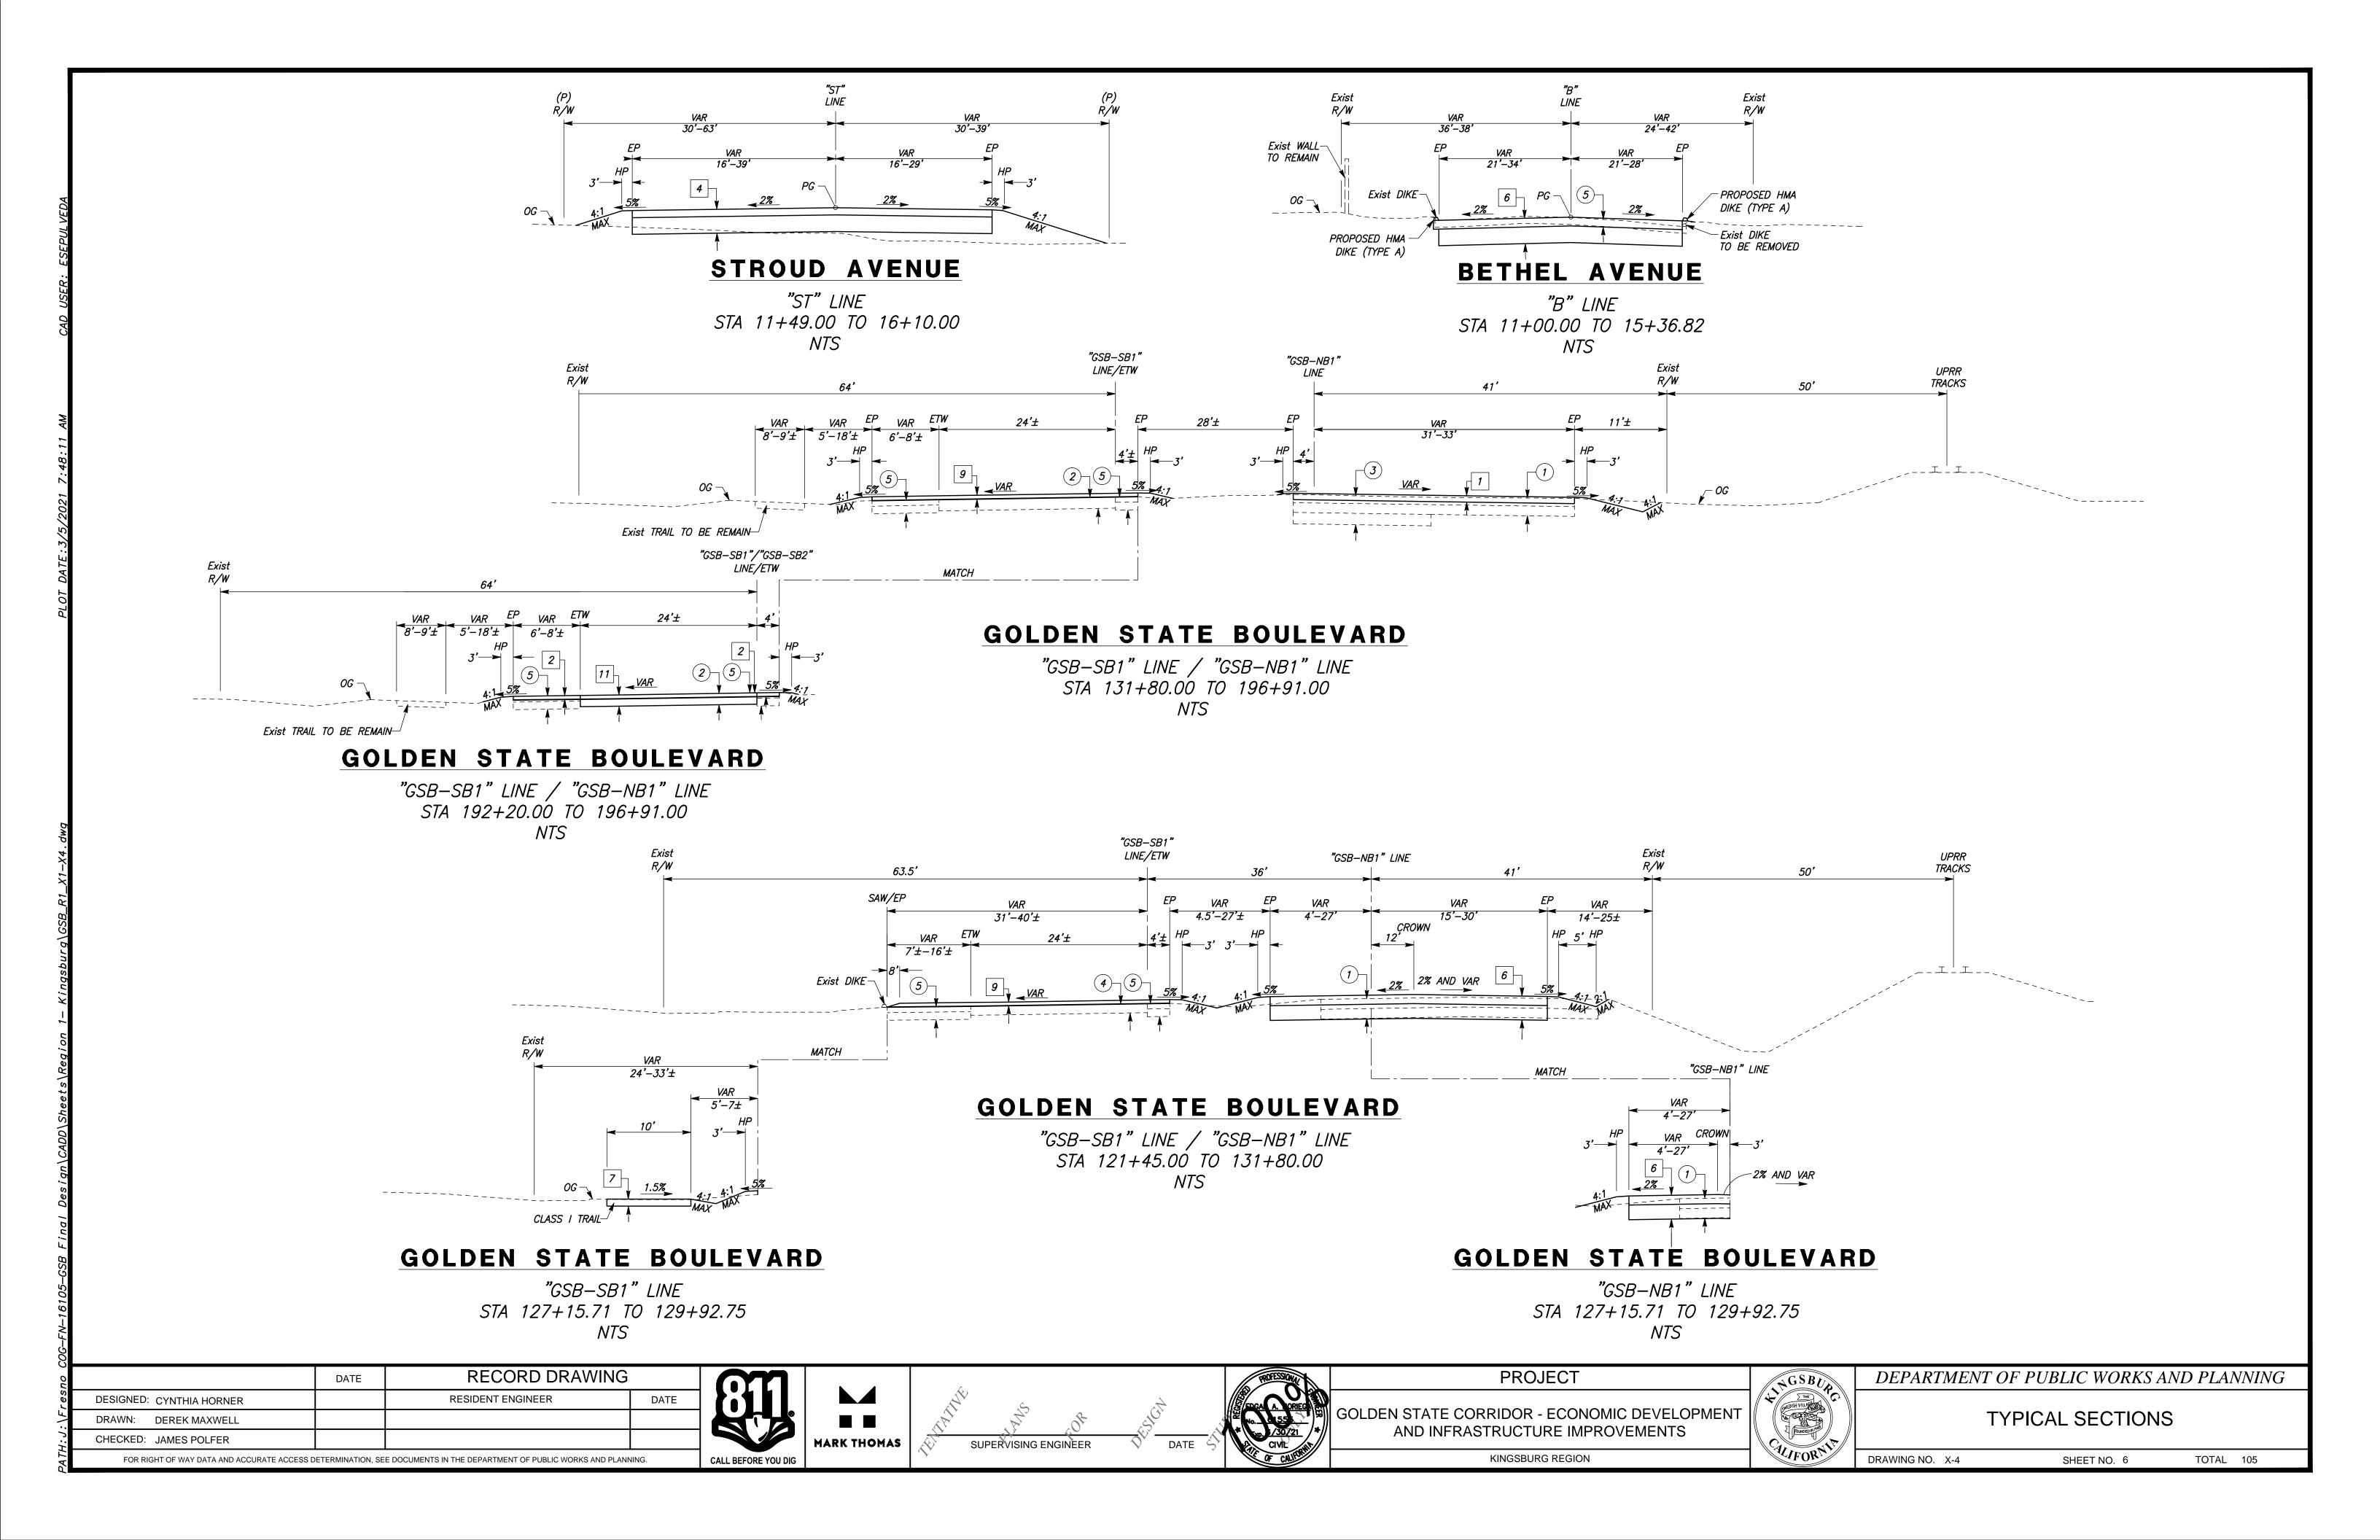

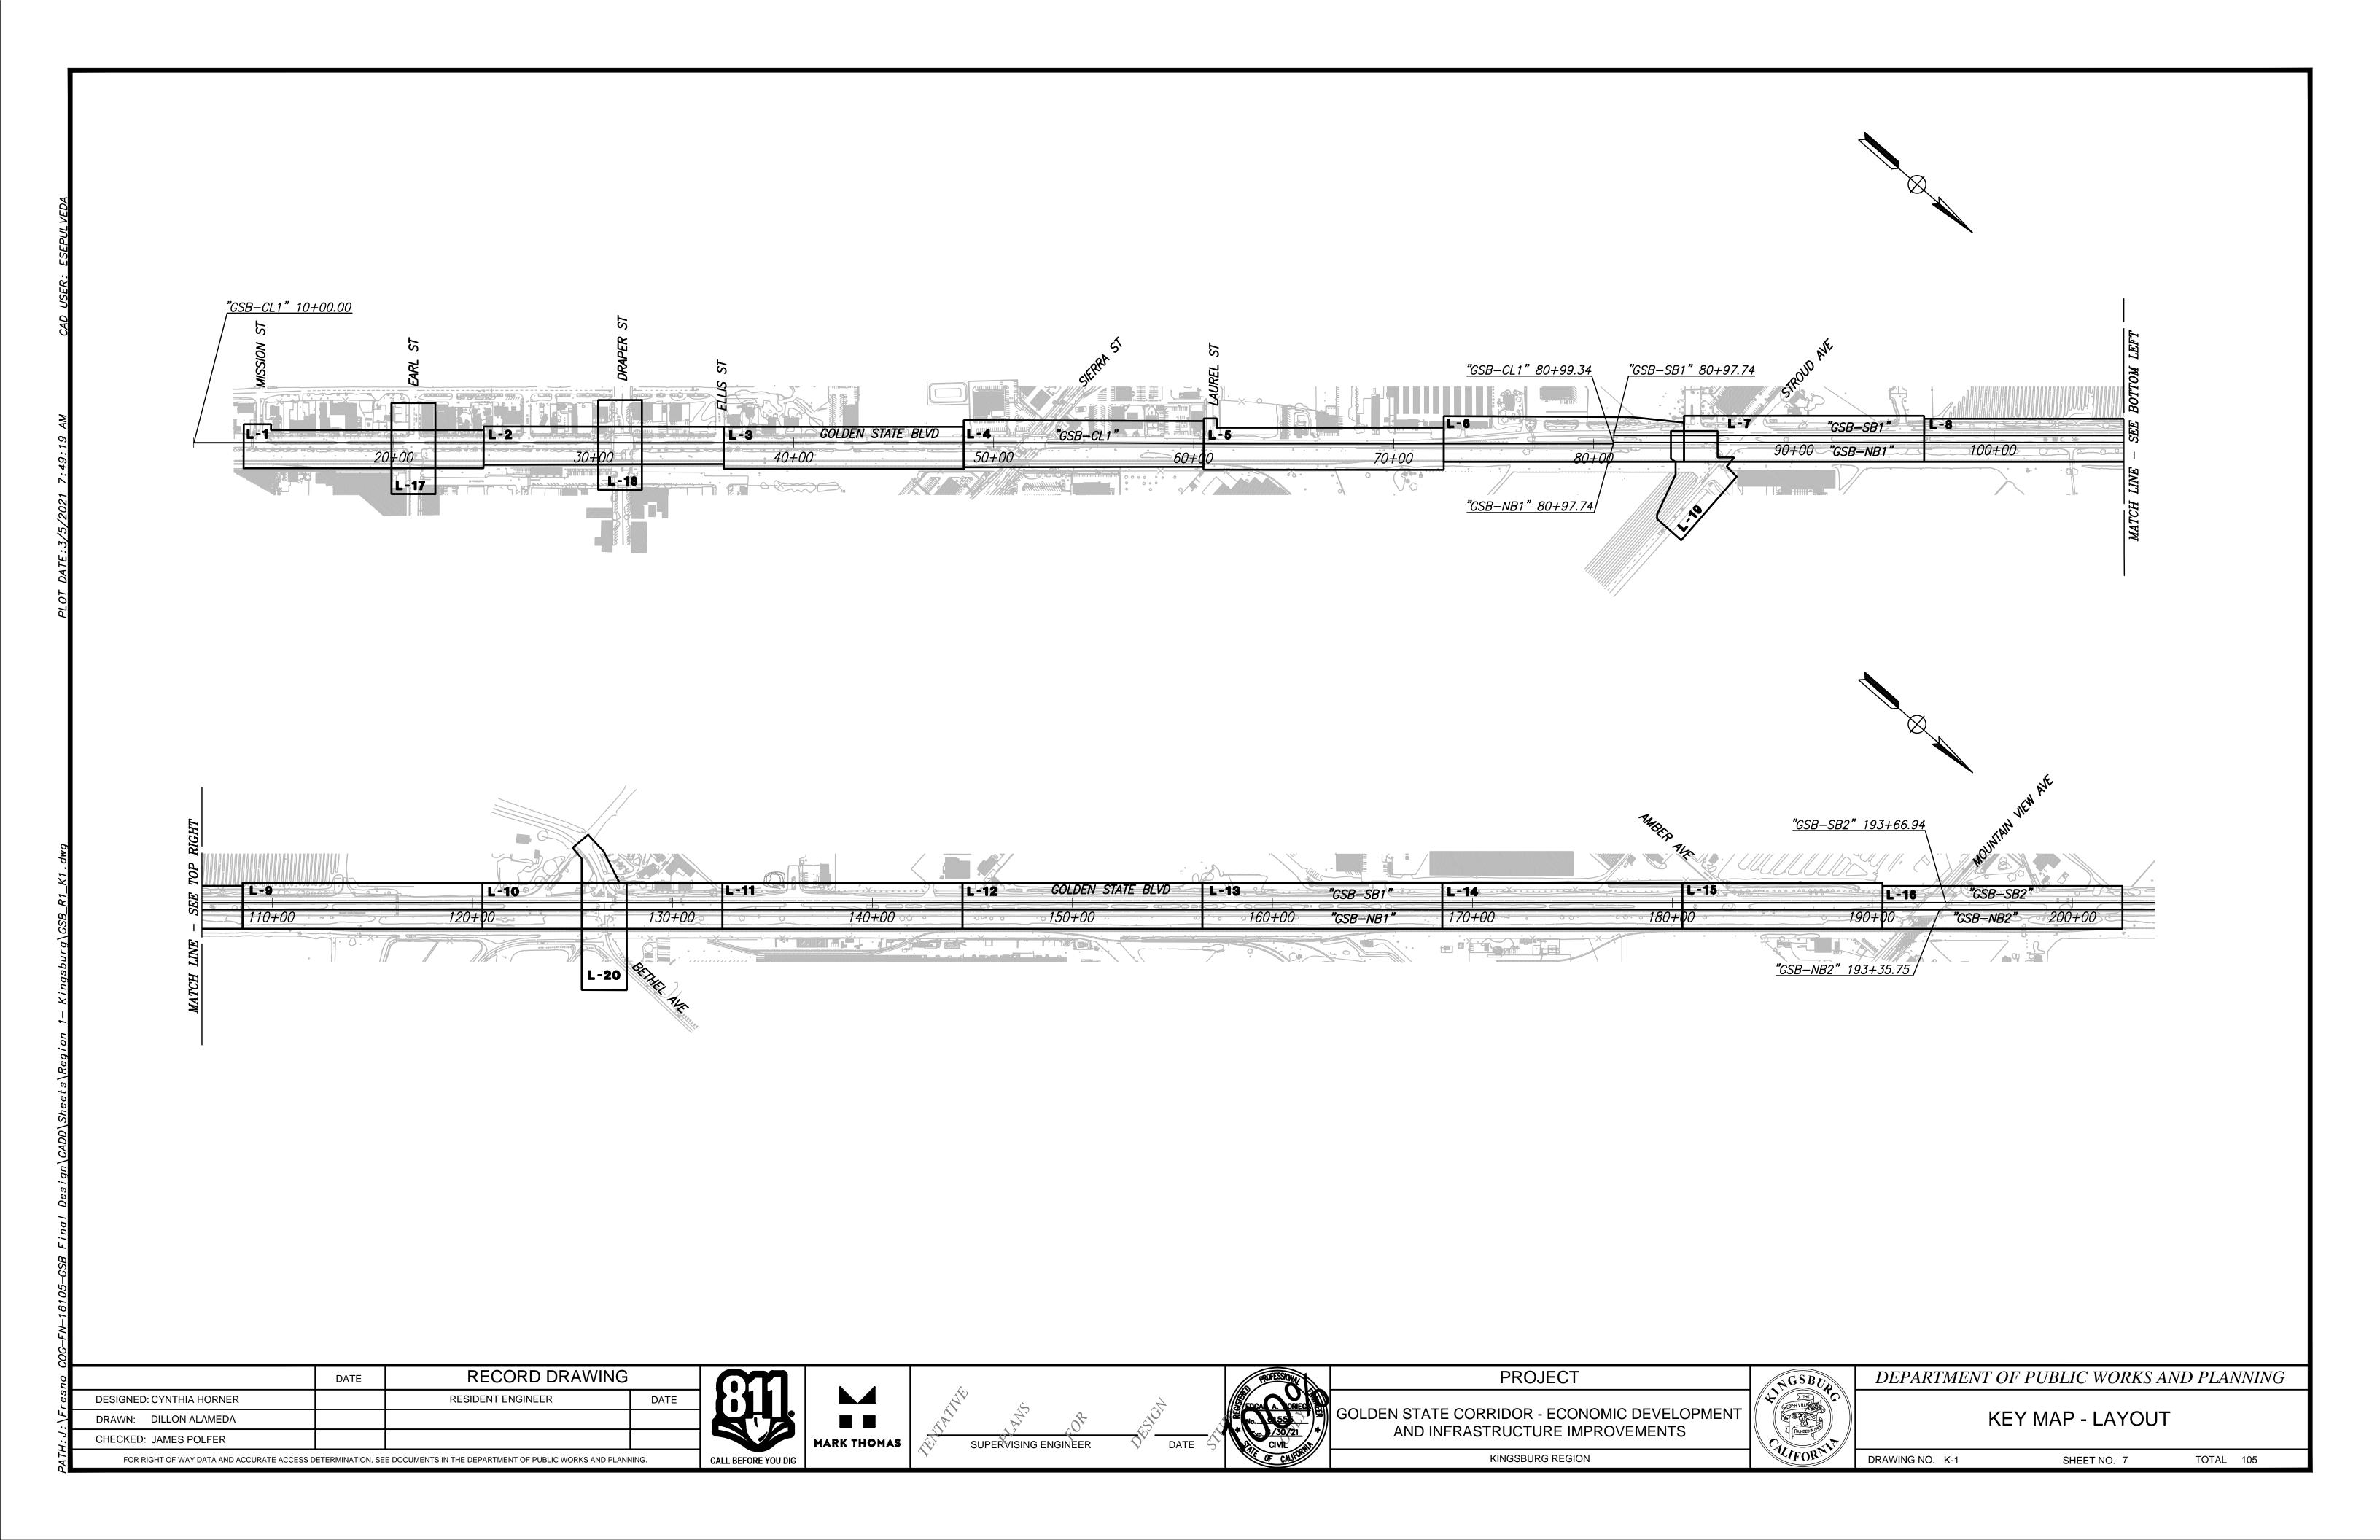

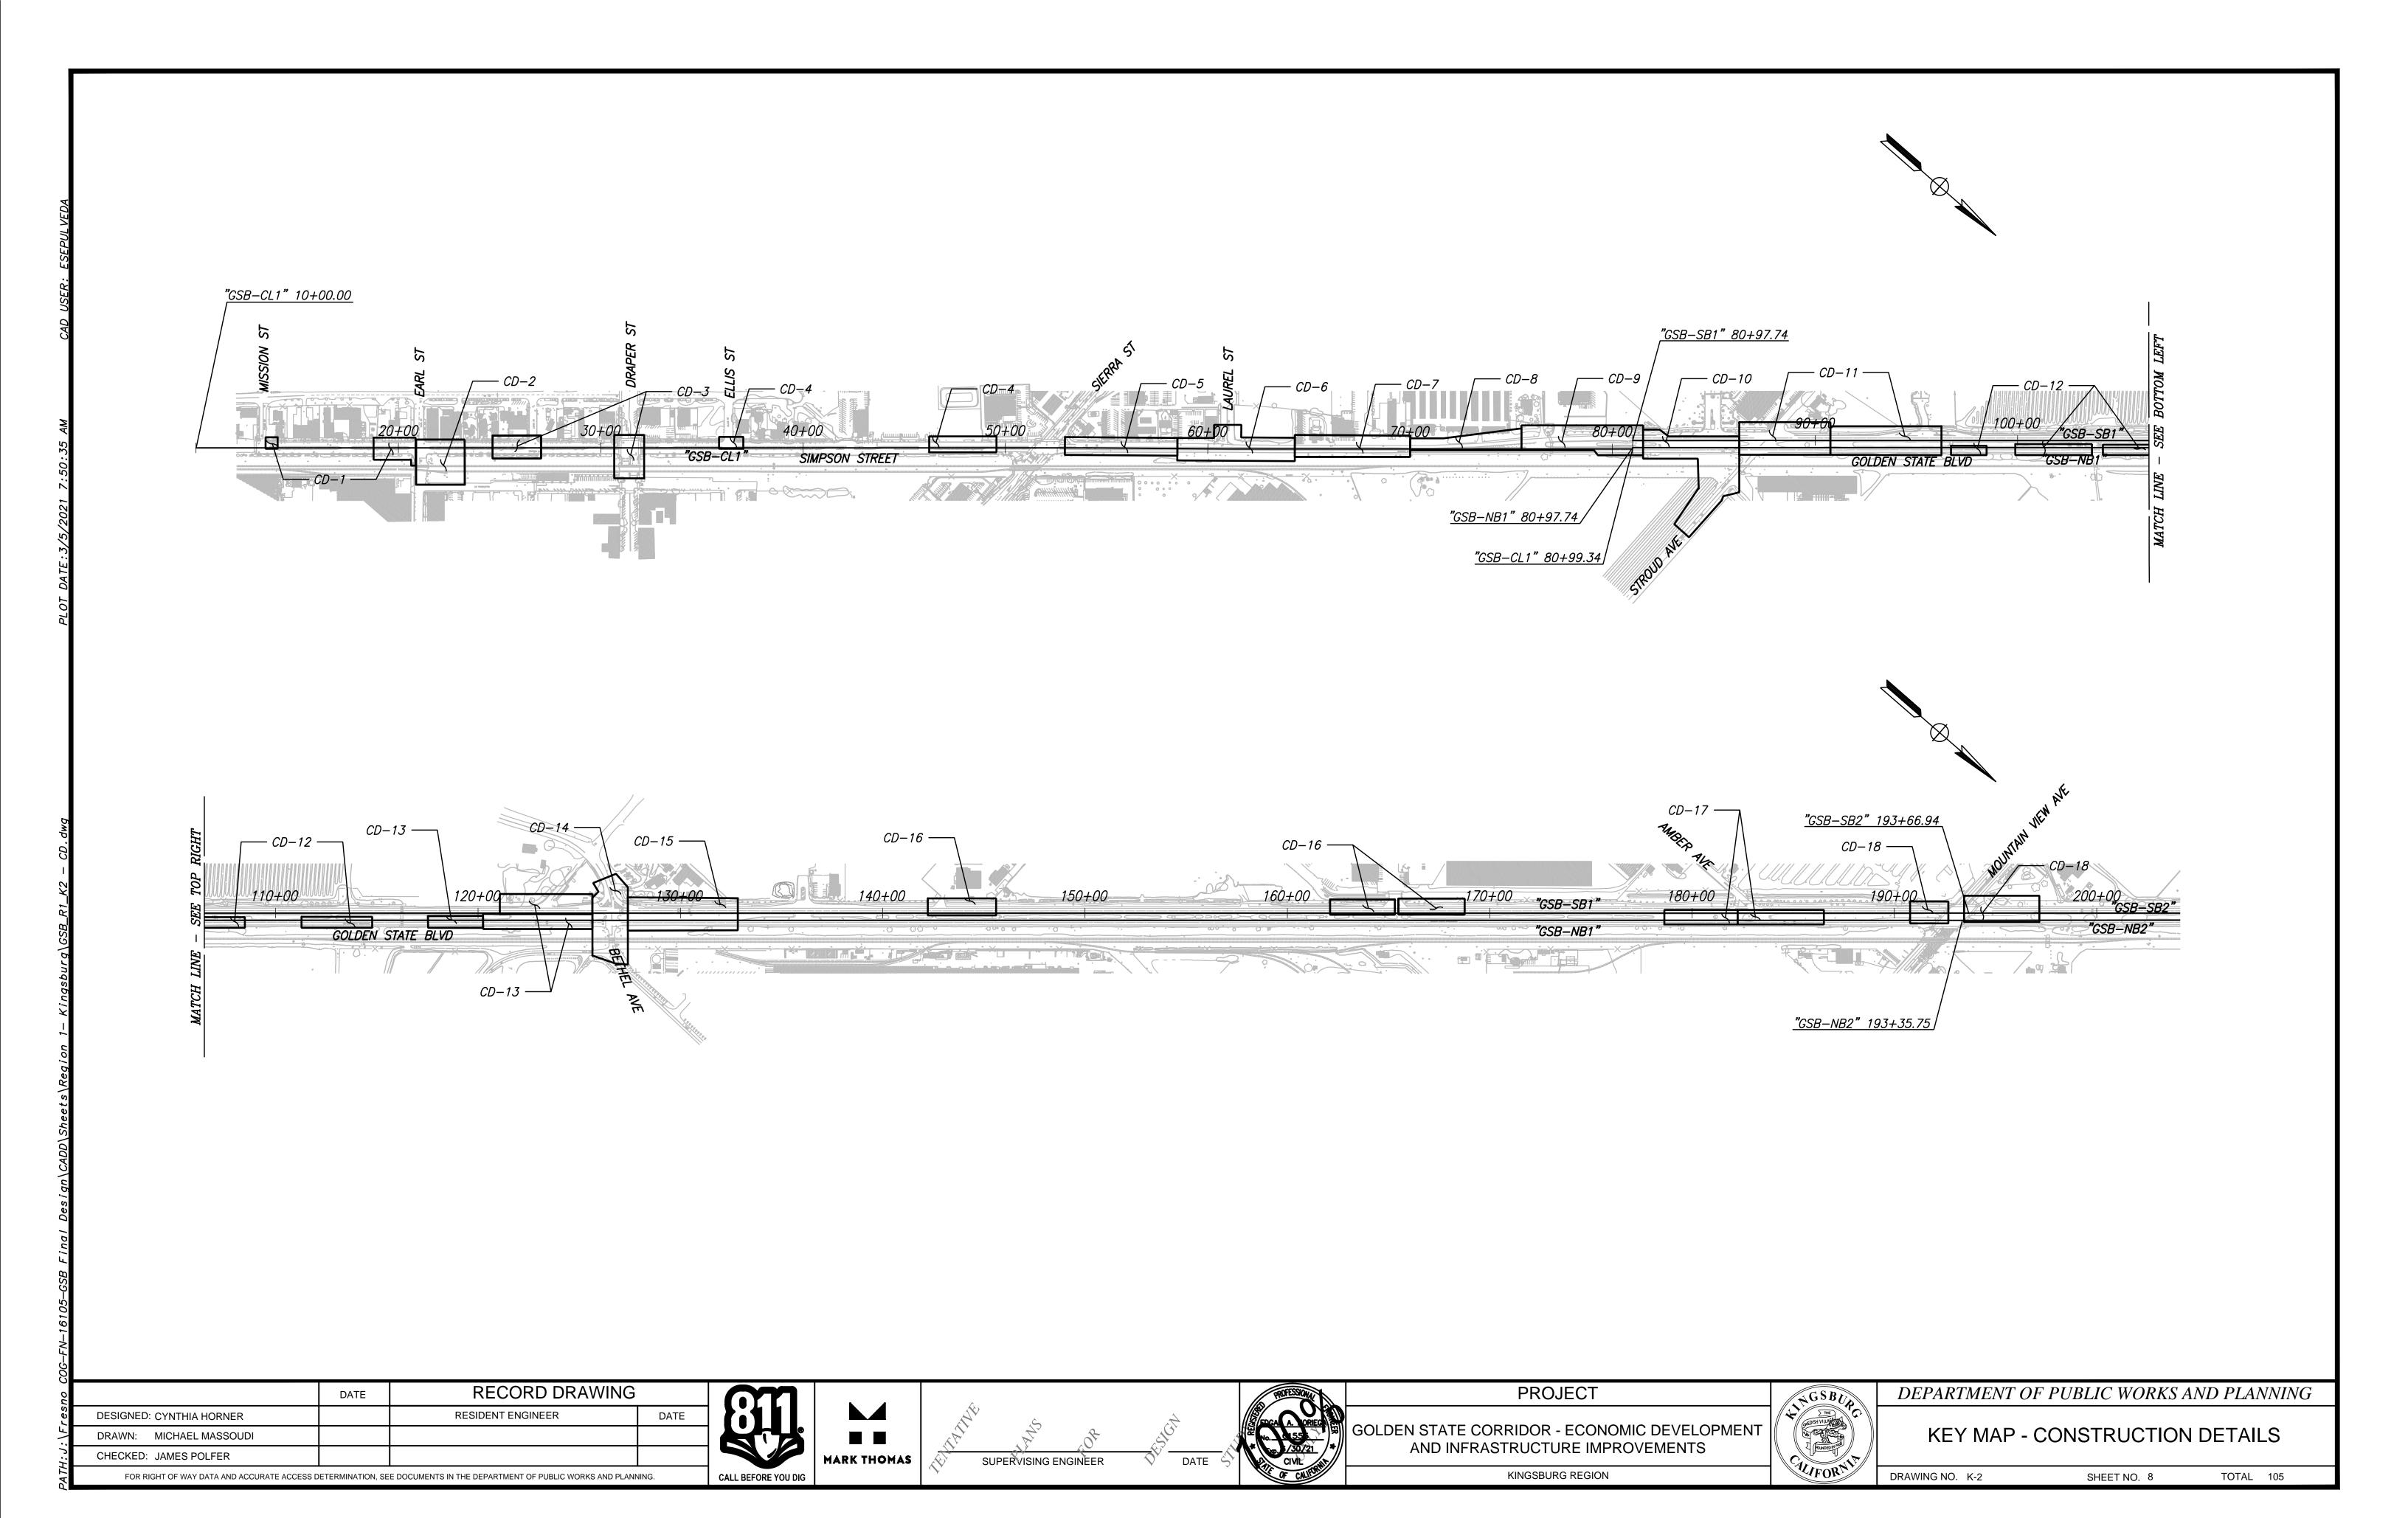

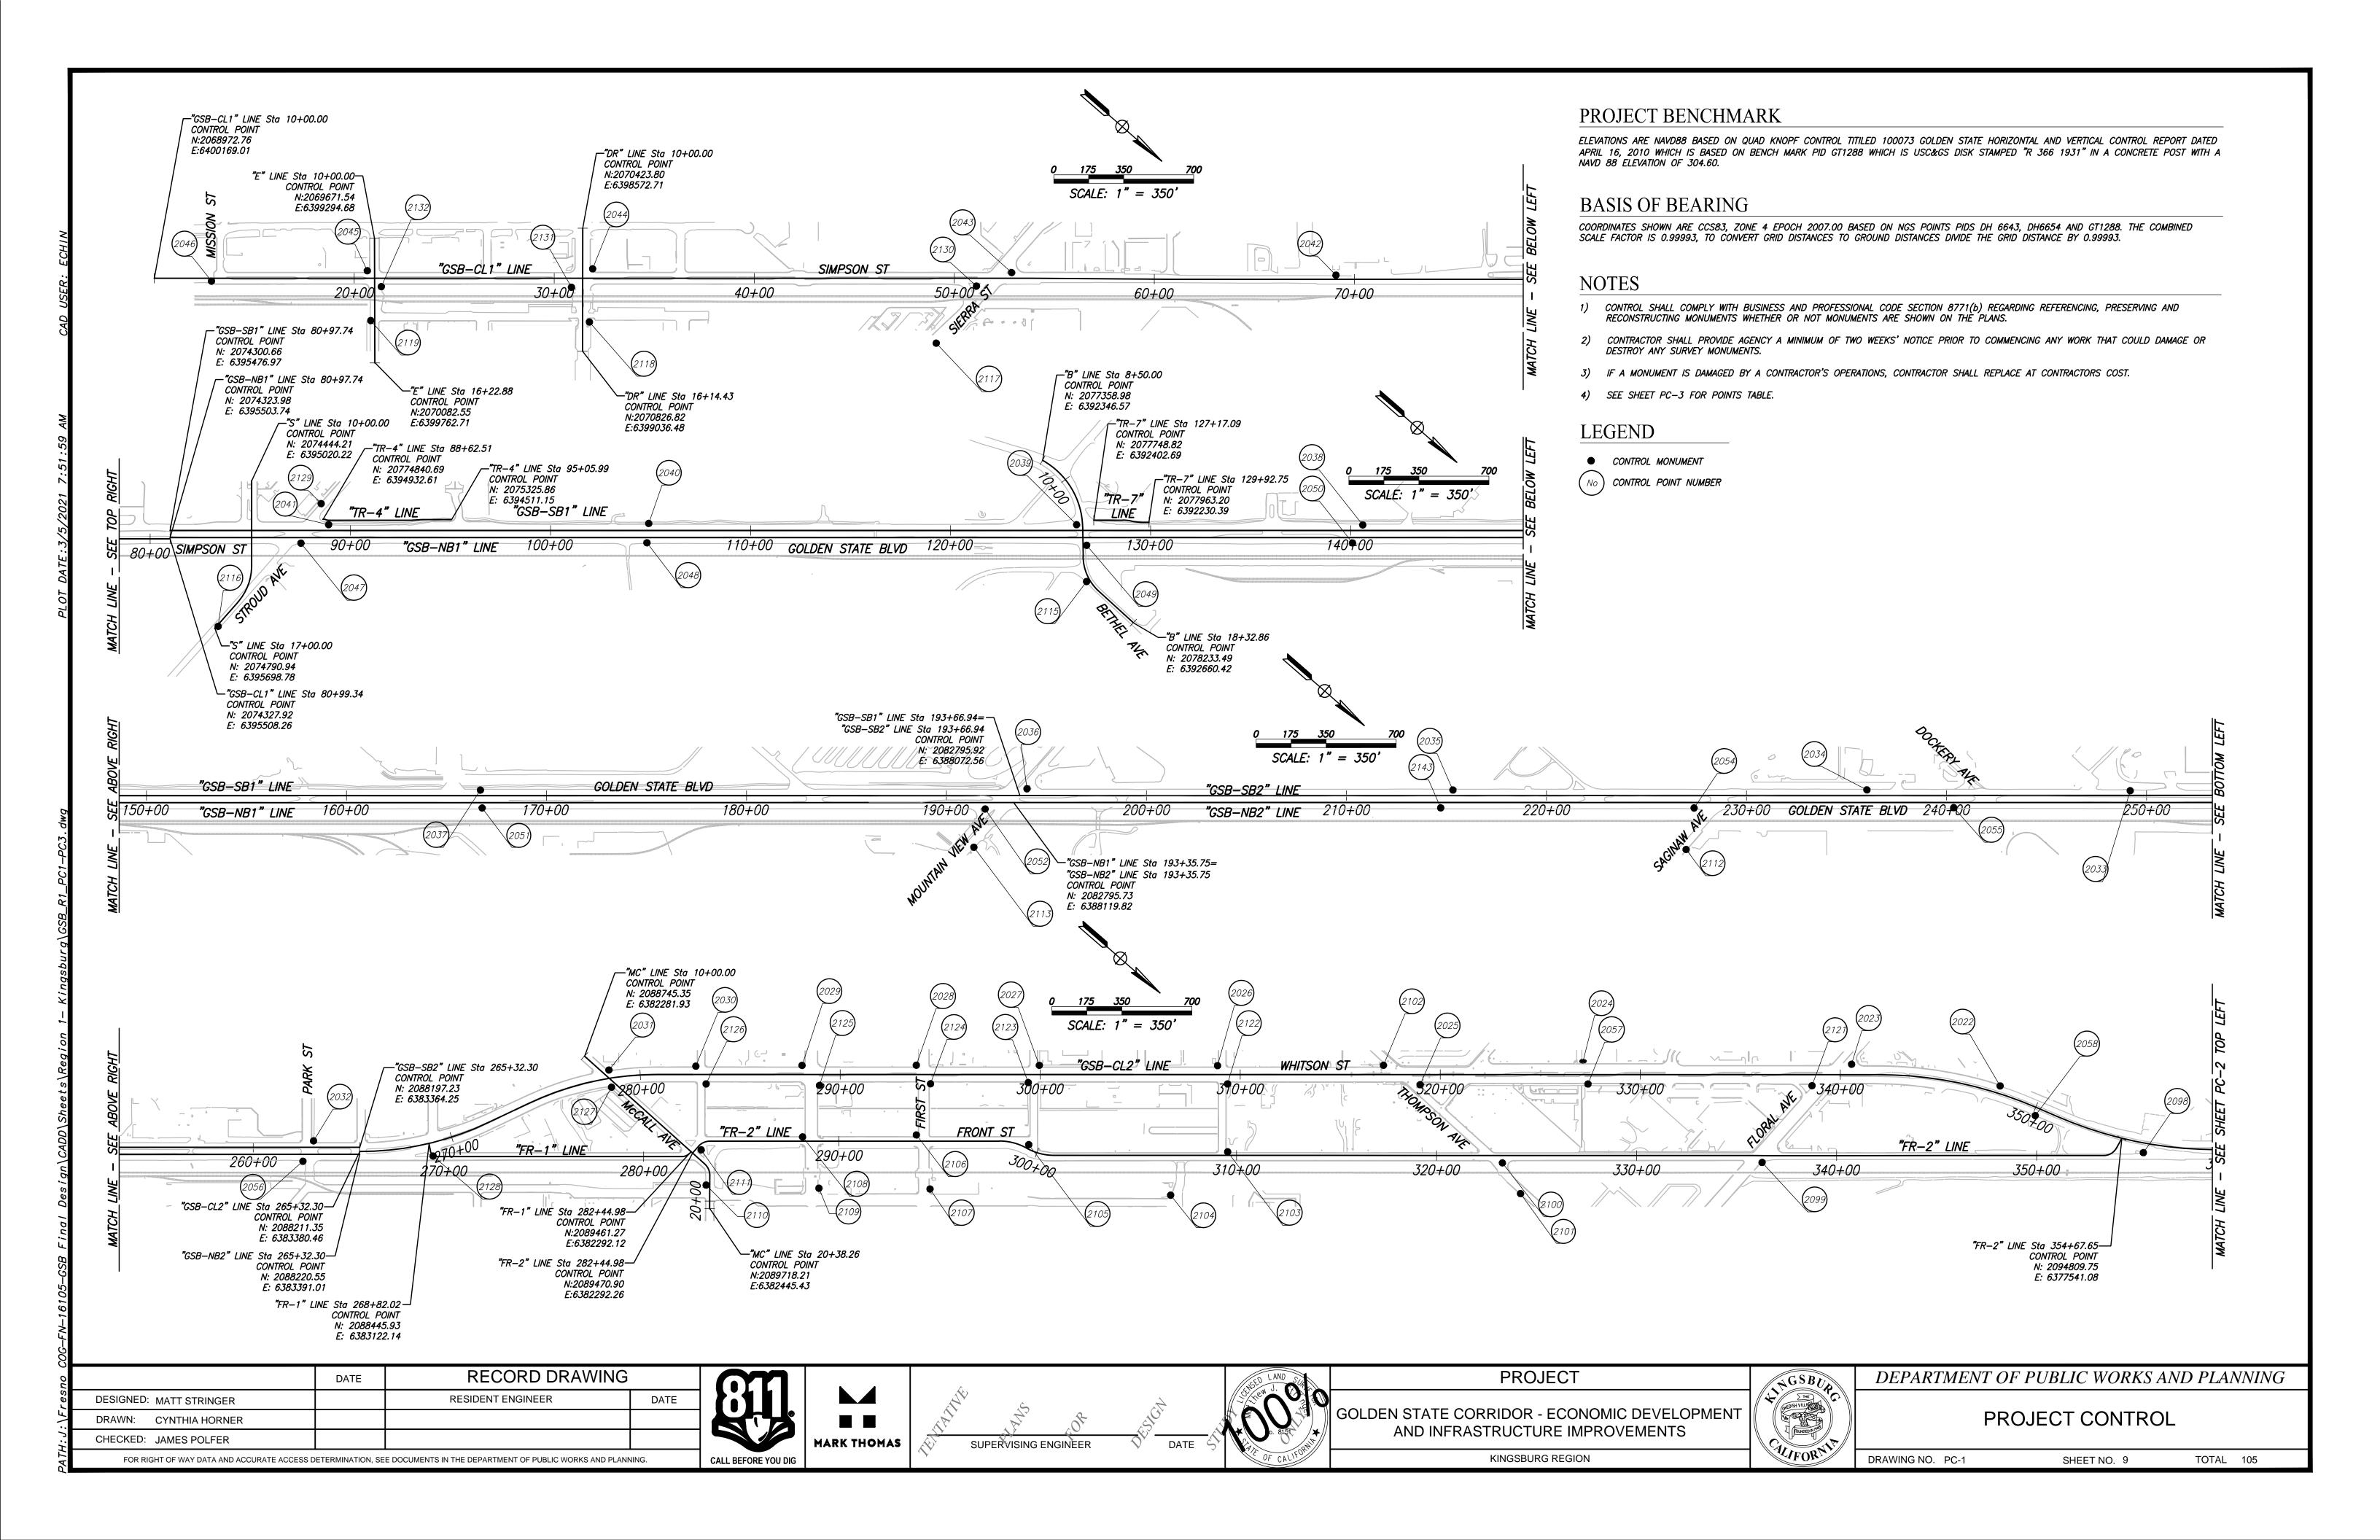

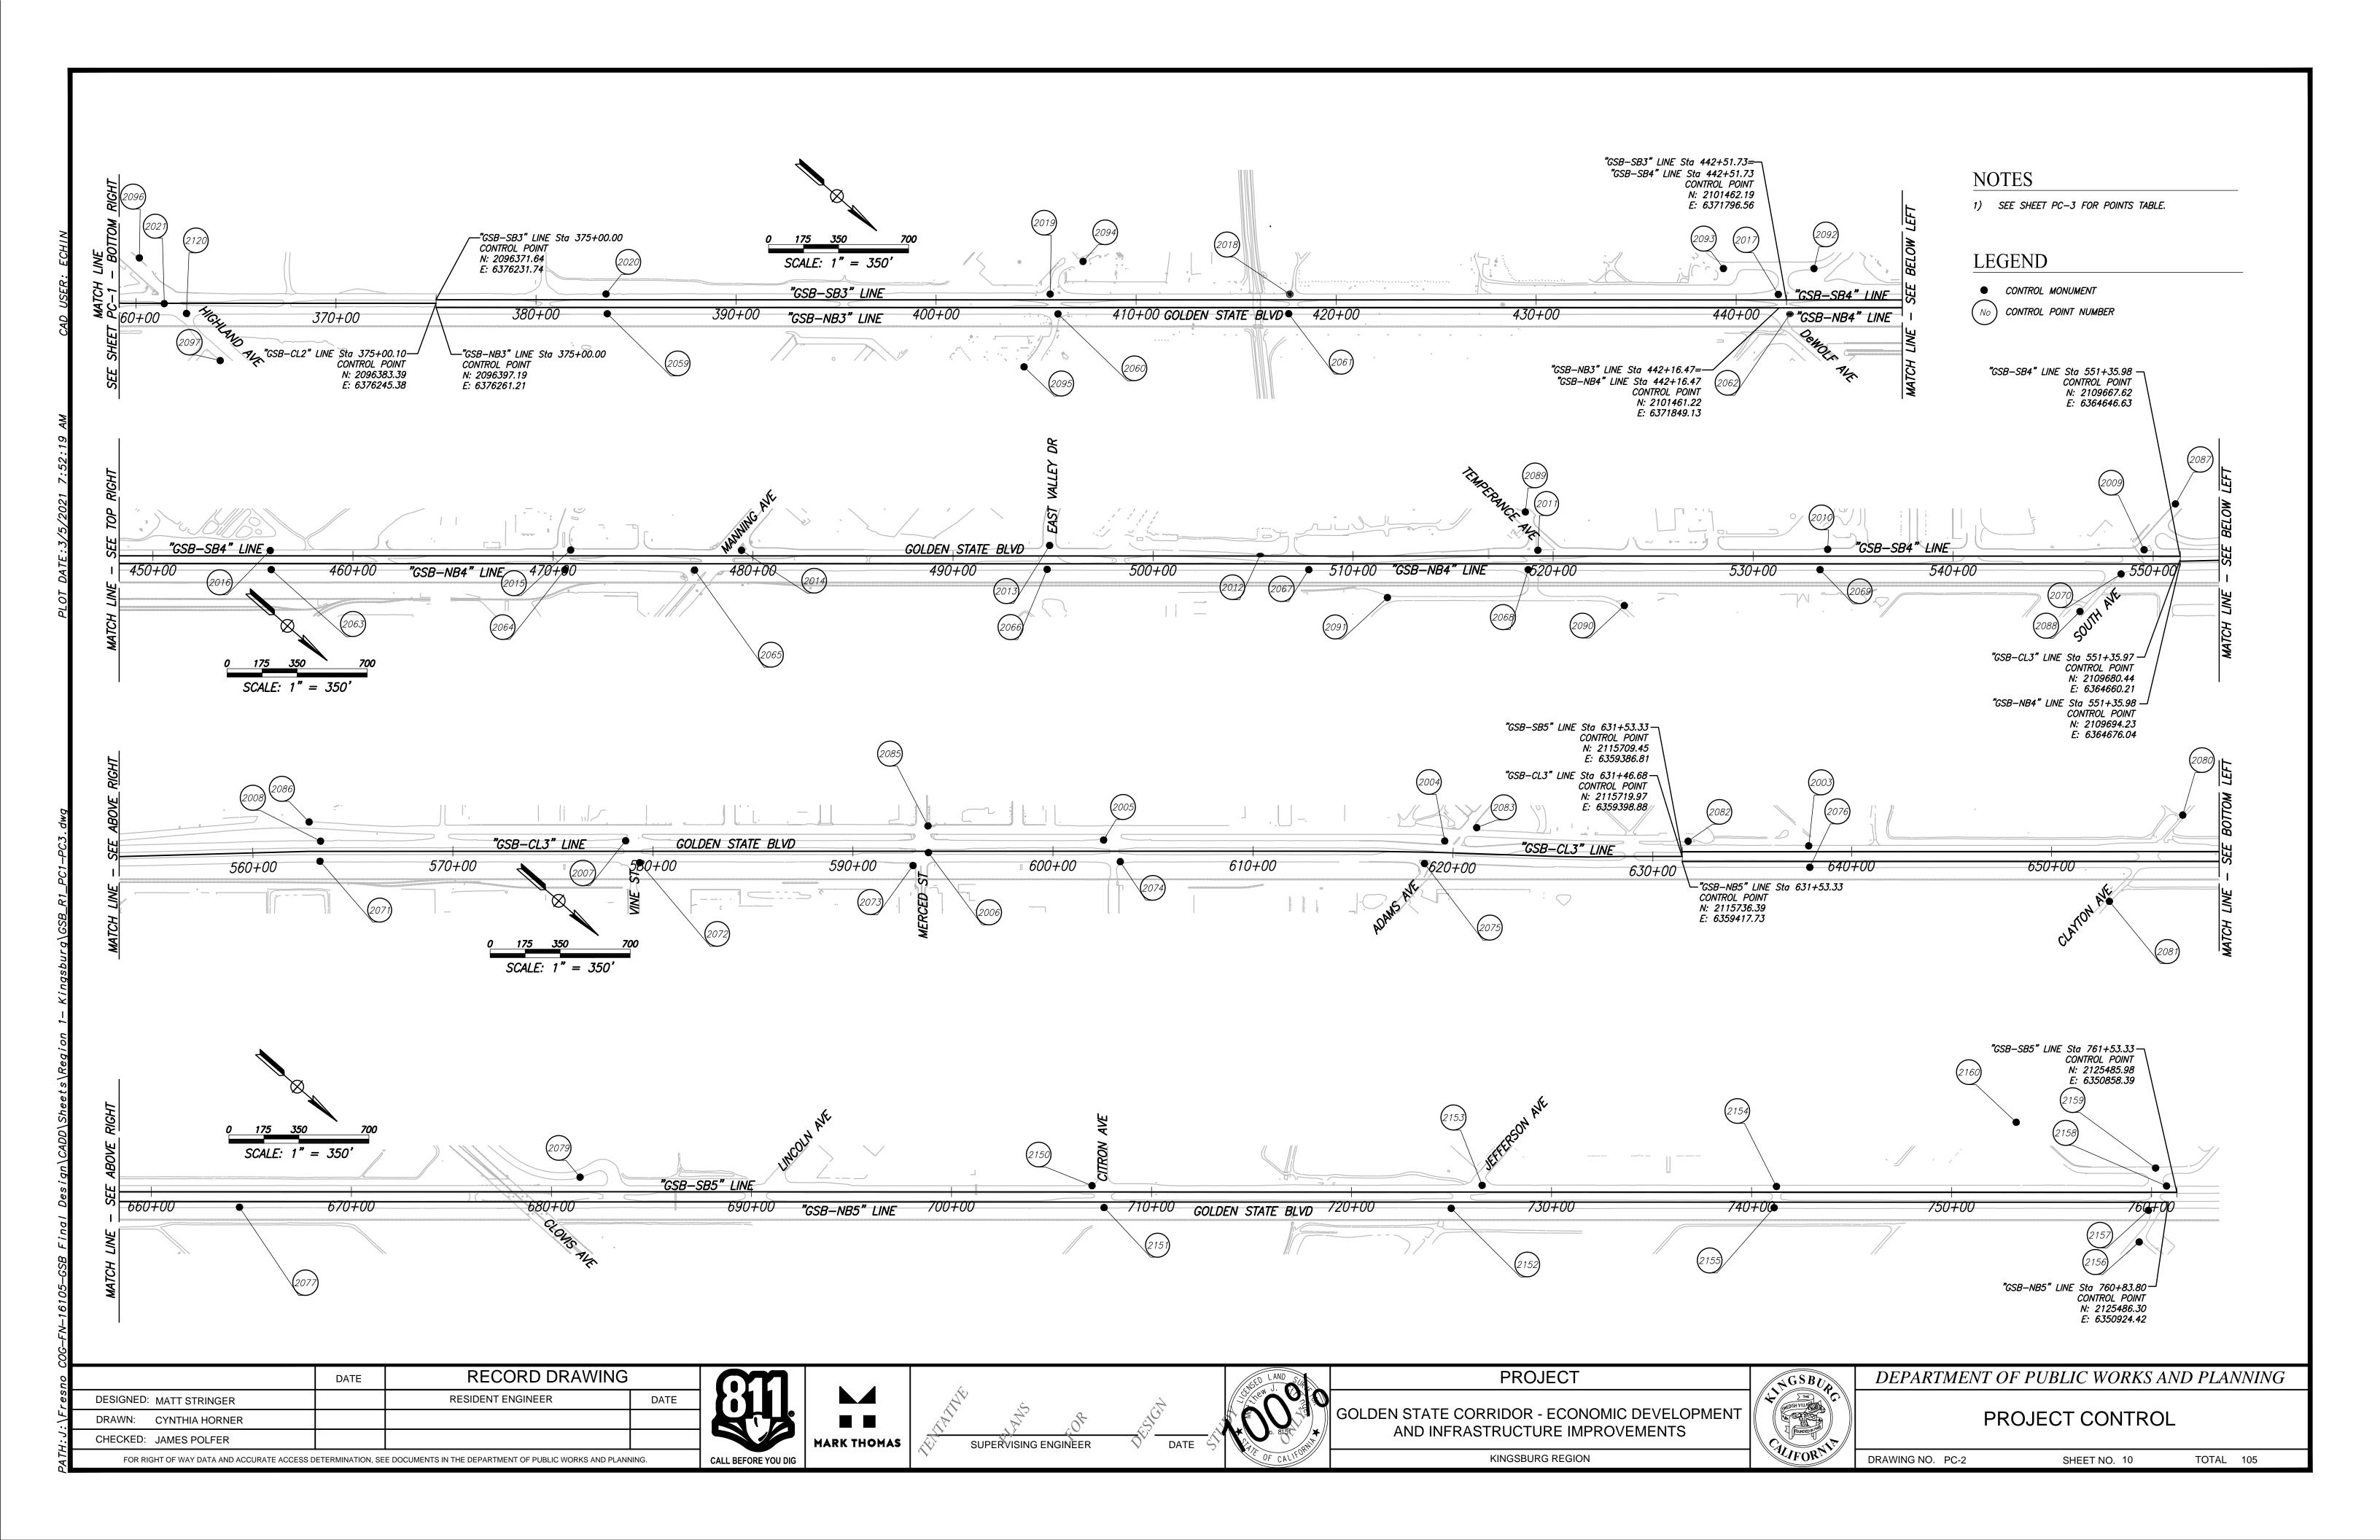

Point Table

SVNS-SET

SVCX-SET

SVNS-SET

SVNS-SET

SVNS-SET

SVNS-SET

SVNS-SET

SVFX MAG NAIL

SVFX MAG NAIL

SVCX-SET

SVNS-SET

SVNS-SET

Point Table				
Point #	Northing	Easting	Elevation	Raw Description
2039	2077698.33	6392477.29	302.01	SVNS-SET
2040	2076081.71	6393878.16	305.93	SVNS-SET
2041	2074879.34	6394934.09	304.84	SVNS-SET
2042	2073416.33	6396275.30	300.60	SVNS-SET
2043	2072185.68	6397330.94	299.80	SVCX-SET
2044	2070594.48	6398693.21	297.70	SVCX-SET
2045	2069751.36	6399440.44	296.82	SVCX-SET
2046	2069198.36	6399991.57	296.26	SVNS-SET
2047	2074835.86	6395094.61	304.71	SVNS-SET
2048	2076138.24	6393956.67	306.13	SVNS-SET
2049	2077803.81	6392521.81	301.17	SVNS-SET
2050	2078797.89	6391639.88	304.98	SVFX SET MAG NAI
2051	2080810.07	6389885.97	307.34	SVNS-SET
2052	2082709.32	6388237.48	310.51	SVCX-SET
2054	2085378.08	6385904.57	305.11	SVNS-SET
2055	2086355.67	6385050.65	304.29	SVFX MAG NAIL
2056	2088029.27	6383603.22	305.47	SVFX MAG NAIL
2057	2092619.57	6379090.46	311.38	SVFX SET X @ WAL
2058	2094409.15	6377740.46	312.53	SVFX SET MAG NAI
2059	2097063.08	6375722.29	307.72	SVFX MAG NAIL
2060	2098762.34	6374242.46	313.36	SVFX MAG NAIL
2061	2099631.06	6373483.82	313.93	SVFX MAG NAIL
2062	2101521.21	6371838.91	310.87	SVFX MAG NAIL
2063	2102517.33	6370968.38	313.12	SVFX MAG NAIL
2064	2103624.84	6370004.54	305.71	SVFX MAG NAIL
2065	2104114.29	6369579.36	306.39	SVFX MAG NAIL
2066	2105441.02	6368418.91	303.29	SVFX MAG NAIL
2067	2106428.09	6367560.23	306.69	SVFX MAG NAIL
2068	2107254.84	6366839.71	307.31	SVNS-SET
2069	2108355.11	6365880.89	305.61	SVFX MAG NAIL
2070	2109503.82	6364908.28	311.09	SVNS-SET
2071	2110601.42	6363891.83	309.53	SVNS-SET
2072	2111810.55	6362847.57	307.07	SVNS-SET
2073	2112850.72	6361959.79	306.39	SVCX-SET
2074	2113618.78	6361264.70	305.91	SVNS-SET
2075	2114771.57	6360272.17	306.75	SVCX-SET

		Point To	able	
Point #	Northing	Easting	Elevation	Raw Description
2076	2116236.20	6359020.57	302.53	SVNS-SET
2077	2118232.42	6357279.42	303.60	SVNS-SET
2079	2119417.63	6356047.49	301.79	SVNS-SET
2080	2117470.35	6357598.65	302.98	SVNS-SET
2081	2117477.21	6358164.63	301.02	SVNS-SET
2082	2115692.00	6359322.24	306.37	SVNS-SET
2083	2114850.75	6359965.61	304.28	SVCX-SET
2085	2112776.83	6361761.51	304.48	SVNS-SET
2086	2110431.36	6363779.54	310.01	SVNS-SET
2087	2109478.42	6364465.95	303.04	SVNS-SET
2088	2109472.19	6365184.41	312.82	SVFX MAG NAIL
2089	2107054.72	6366631.47	302.91	SVFX MAG NAIL
2090	2107735.10	6366659.05	308.10	SVFX MAG NAIL
2091	2106816.12	6367407.01	310.86	SVNS-SET
2092	2101462.64	6371588.26	310.57	SVFX MAG NAIL
2093	2101121.25	6371885.50	310.88	SVFX MAG NAIL
2094	2098684.13	6373962.31	314.41	SVFX MAG NAIL
2095	2098808.06	6374553.41	314.34	SVFX MAG NAIL
2096	2095115.96	6377048.74	311.83	SVFX SET X @ WA
2097	2095757.87	6377170.16	313.36	SVFX MAG NAIL
2098	2094938.25	6377524.75	312.14	SVFX MAG NAIL
2099	2093533.15	6378813.90	311.26	SVFX SET X @ WA
2100	2092555.79	6379668.74	310.04	SVFX MAG NAIL
2101	2092725.19	6379724.91	310.03	SVFX MAG NAIL
2102	2091787.06	6379691.75	309.26	SVFX SET X @ WA
2103	2091484.15	6380529.63	309.70	SVFX SET X @ WA
2104	2091411.39	6380880.49	310.40	SVFX SET X @ WA
2105	2090710.69	6381156.13	308.80	SVFX MAG NAIL
2106	2090255.37	6381488.68	307.51	SVFX SET X @ WA
2107	2090484.12	6381647.80	308.97	SVFX SET X @ WA
2108	2089832.79	6381869.93	306.45	SVFX SET X @ WA
2109	2090062.76	6382009.47	308.64	SVFX SET X @ WA
2110	2089627.23	6382368.15	308.12	SVFX MAG NAIL
2111	2089493.39	6382252.01	307.01	SVFX SET X @ PO
2112	2085484.07	6386087.06	305.54	SVFX SET MAG NA
2113	2082792.24	6388418.50	310.37	SVNS-SET

Point #	Northing	Easting	Elevation	Raw Description
2115	2077922.64	6392658.57	305.63	SVNS-SET
2116	2074796.68	6395679.74	303.68	SVNS SET
2117	2072133.30	6397844.57	299.92	SVCX-SET
2117	2072755.50	6398904.18	299.35	SVNS-SET
2119	2069928.05	6399617.05	297.27	SVNS-SET
2119	2009928.03	6377103.27	313.14	SVFX MAG NAIL
2121	2093469.54	6378361.00	312.32	SVFX SET X @ WAL
2122	2091260.97	6380274.09	308.88	SVFX SET X @ WAL
2123	2090505.21	6380923.85	309.73	SVFX SET X @ WAL
2124	2090140.57	6381249.51	309.29	SVFX SET X @ WAL
2125	2089727.51	6381620.50	307.68	SVFX SET X @ WAL
2126	2089294.91	6381987.34	306.81	SVFX SET X @ WAL
2127	2088949.47	6382310.38	306.09	SVFX SET X @ WAL
2128	2088502.82	6383155.62	308.41	SVFX MAG NAIL
2129	2074782.16	6394879.36	303.92	SVNS-SET
2130	2072097.37	6397497.47	301.09	SVCX-SET
2131	2070574.90	6398832.16	298.95	SVCX-SET
2132	2069856.48	6399454.46	297.29	SVNS-SET
2143	2084422.76	6386736.42	305.24	SVNS-SET
2150	2121374.97	6354397.67	305.05	SET MAG NAIL-SCAN CONTROL MARKI
2151	2121492.22	6354440.63	304.09	SET MAG NAIL-SCAN CONTROL MARKI
2152	2122803.11	6353303.14	306.25	SET MAG NAIL-SCAN CONTROL MARKE
2153	2122844.29	6353115.12	306.27	SET MAG NAIL-SCAN CONTROL MARKE
2154	2123957.67	6352152.51	304.29	SET MAG NAIL-SCAN CONTROL MARKI
2155	2124018.23	6352239.92	303.44	SET MAG NAIL-SCAN CONTROL MARKI
2156	2125507.00	6351169.94	301.83	SET MAG NAIL-SCAN CONTROL MARKI
2157	2125437.29	6351020.12	301.56	SET MAG NAIL-SCAN CONTROL MARKI
2158	2125426.00	6350869.16	303.17	SET MAG NAIL-SCAN CONTROL MARKI
2159	2125325.80	6350837.24	299.45	SET MAG NAIL-SCAN CONTROL MARKI
2160	2124650.18	6351123.06	302.82	SET MAG NAIL-SCAN CONTROL MARKI
2161	2125474.61	6350391.74	302.65	SET MAG NAIL-SCAN CONTROL MARKI
2162	2125987.98	6350383.60	302.12	SET MAG NAIL—SCAN CONTROL MARKI
2163	2126058.58	6350463.21	301.19	SET MAG NAIL—SCAN CONTROL MARKI

	DATE	RECORD DRAWING	
DESIGNED: MATT STRINGER		RESIDENT ENGINEER	DATE
DRAWN: CYNTHIA HORNER			
CHECKED: JAMES POLFER			

FOR RIGHT OF WAY DATA AND ACCURATE ACCESS DETERMINATION, SEE DOCUMENTS IN THE DEPARTMENT OF PUBLIC WORKS AND PLANNING.

| 2088883.40 | 6382254.29 | 307.76 | SVFX SET X @ WAL

2032 | 2088002.46 | 6383491.48 | 305.93 | SVFX SET X @ WAL

2035 | 2084410.11 | 6386629.11 | 306.00 | SVFX SET MAG NAI

2086965.15 | 6384406.95 | 305.37

2034 | 2085969.88 | 6385268.67 | 304.97


2036 | 2082800.54 | 6388023.81 | 309.16


2037 | 2080744.79 | 6389824.36 | 308.03

2038 | 2078777.36 | 6391538.12 | 305.81






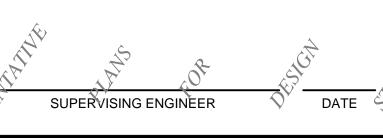

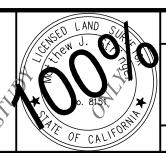





PROJECT

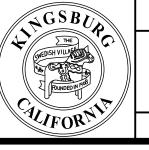



PRO IFCT	CONTROL
	CONTINUL


DRAWING NO. PC-3 TOTAL 105 SHEET NO. 11

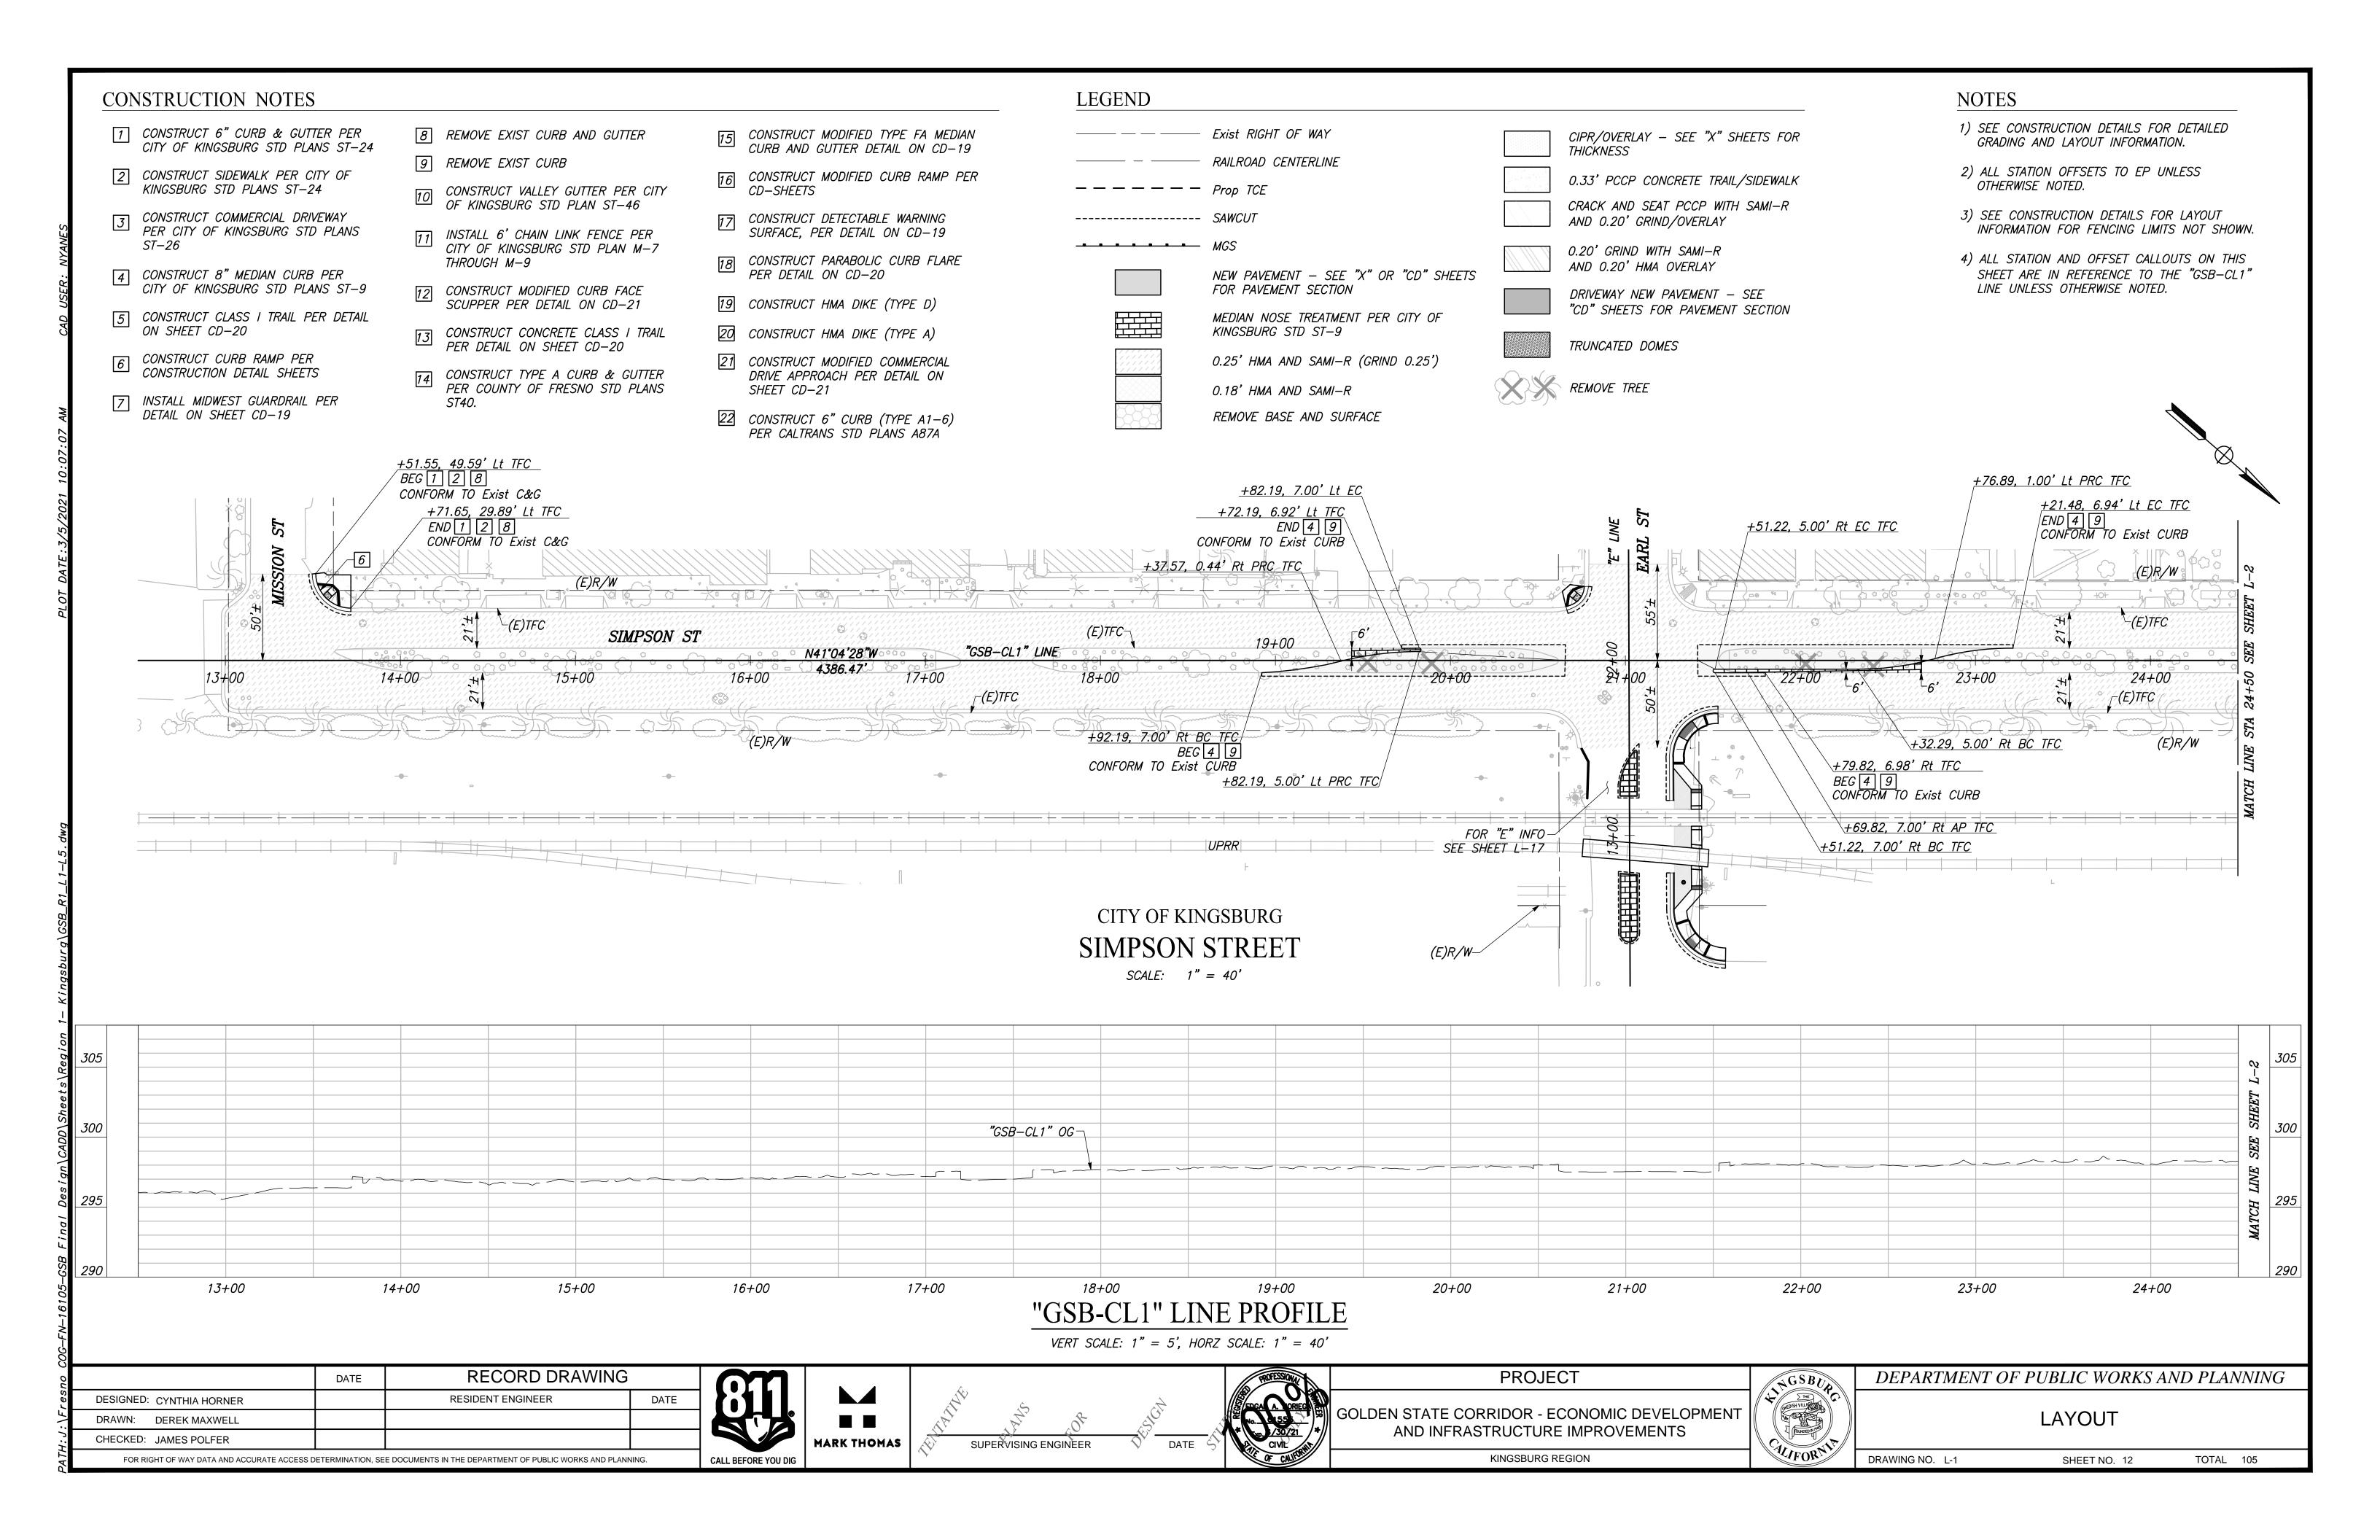


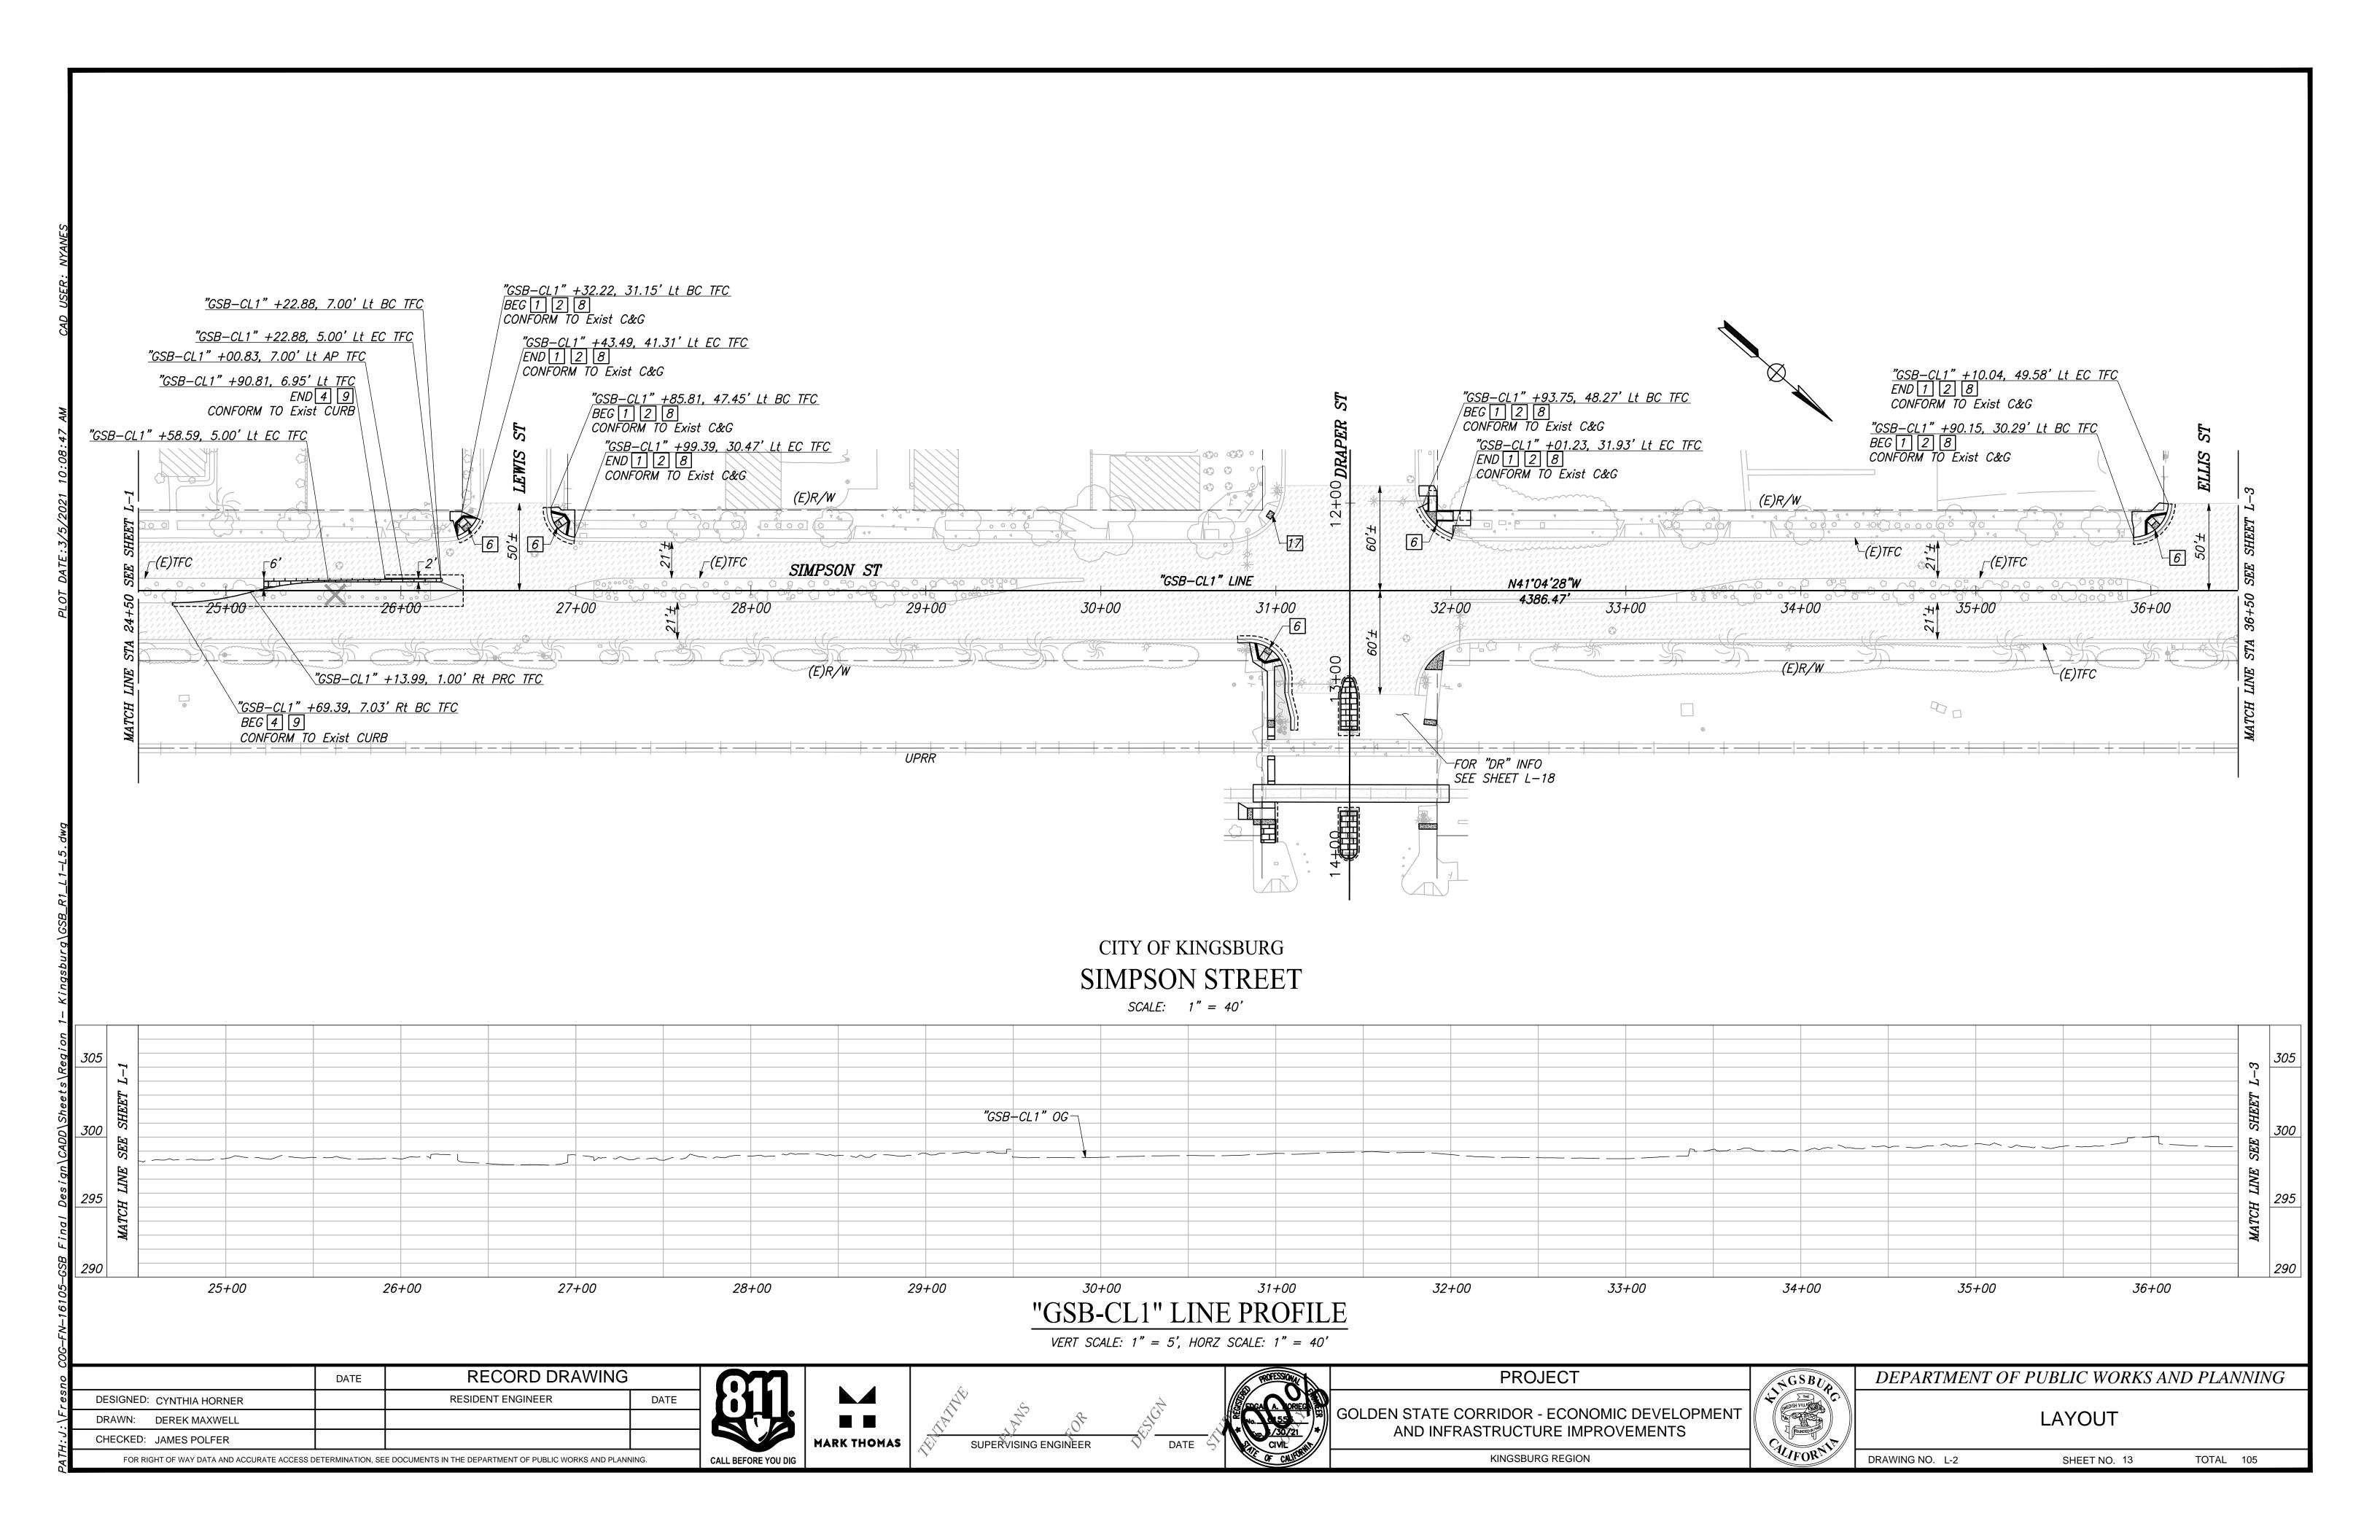


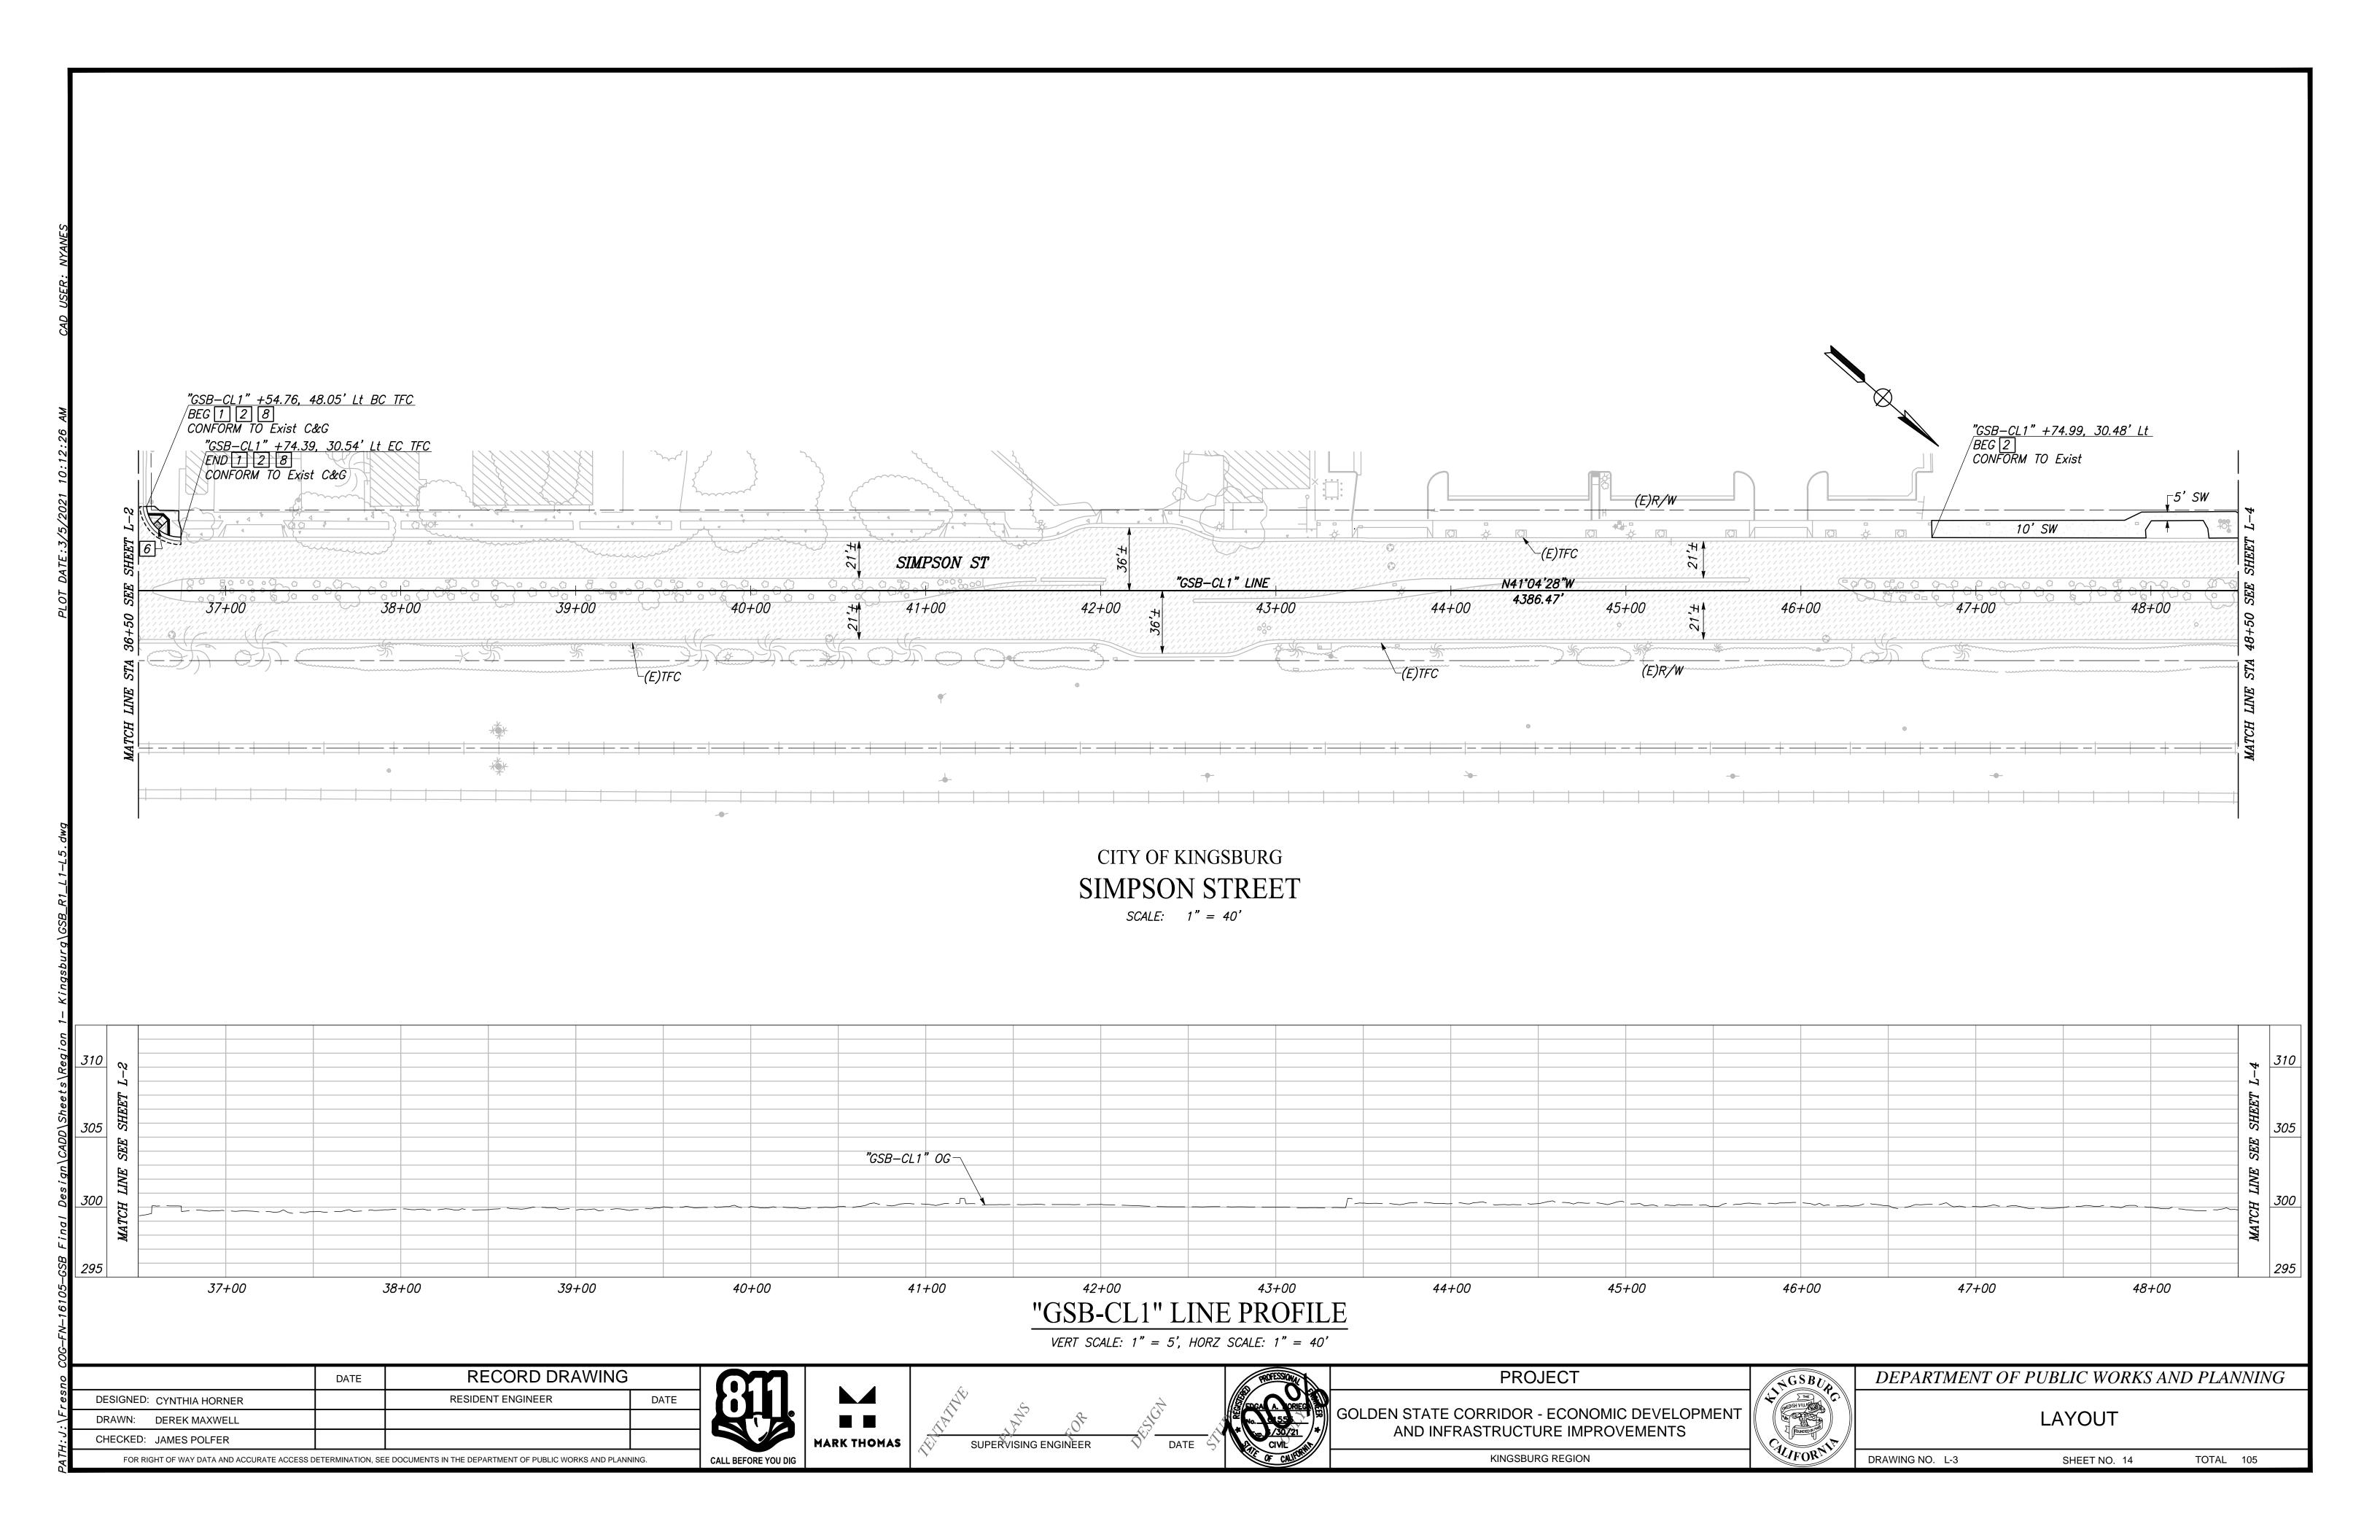


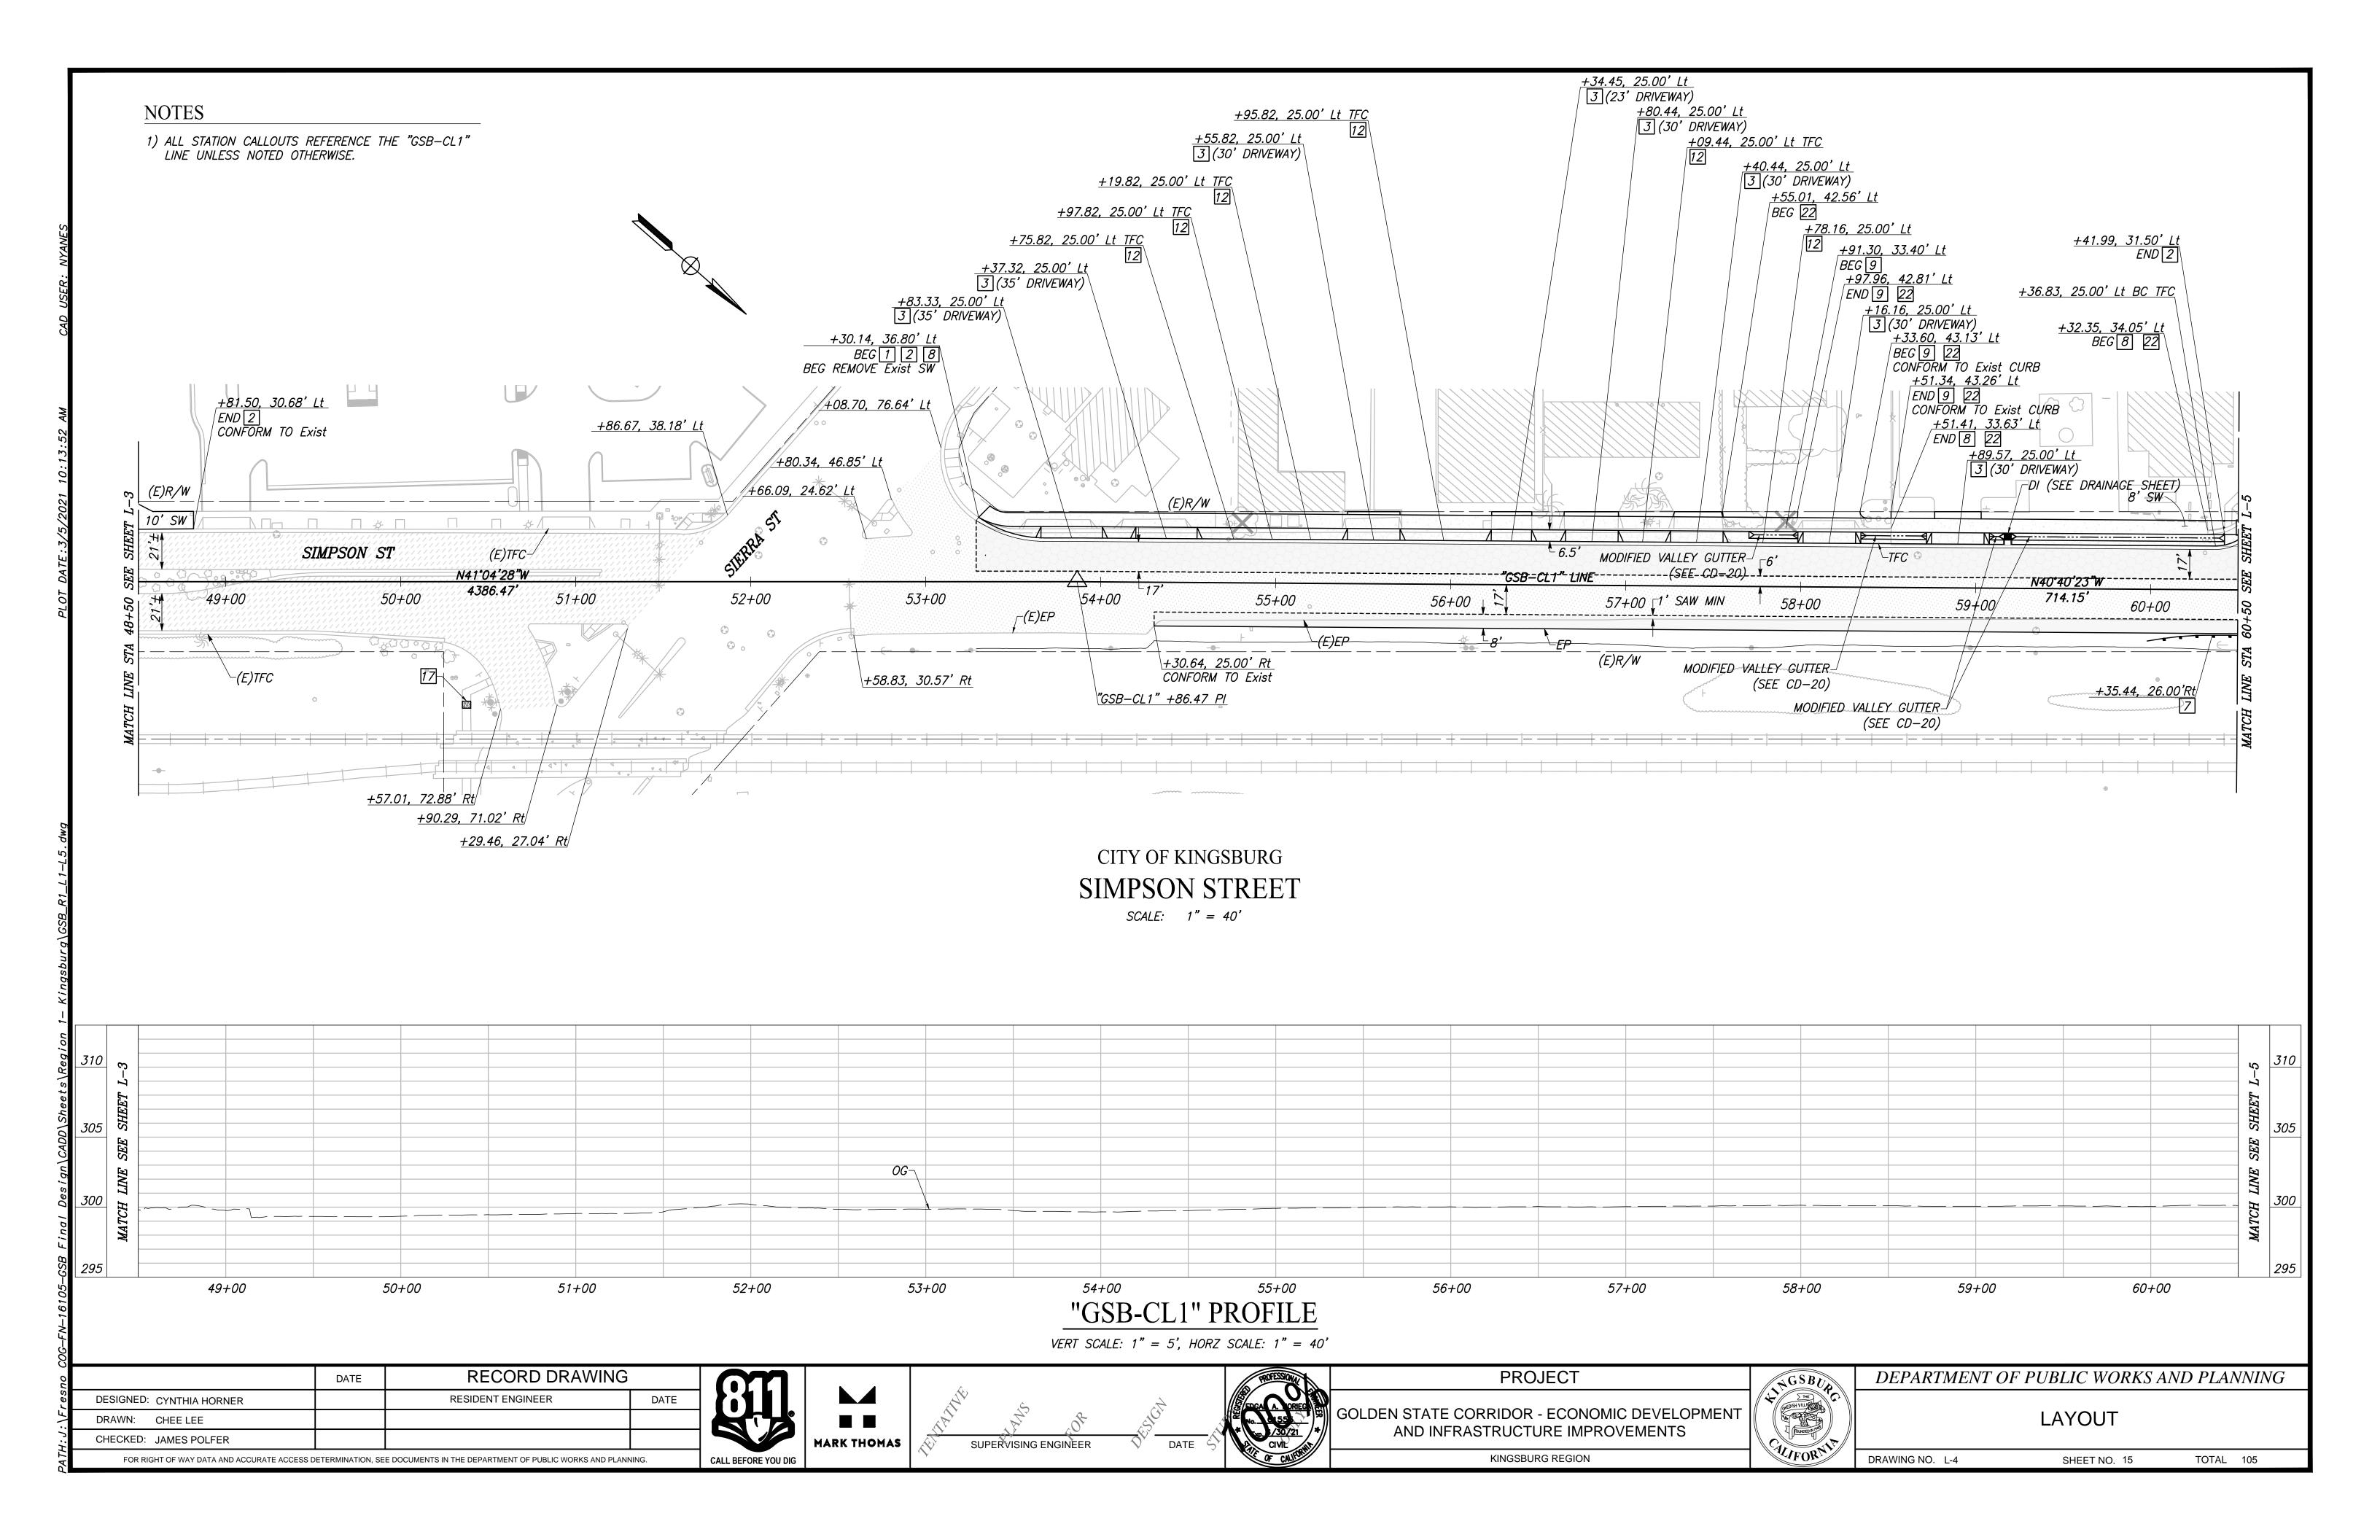


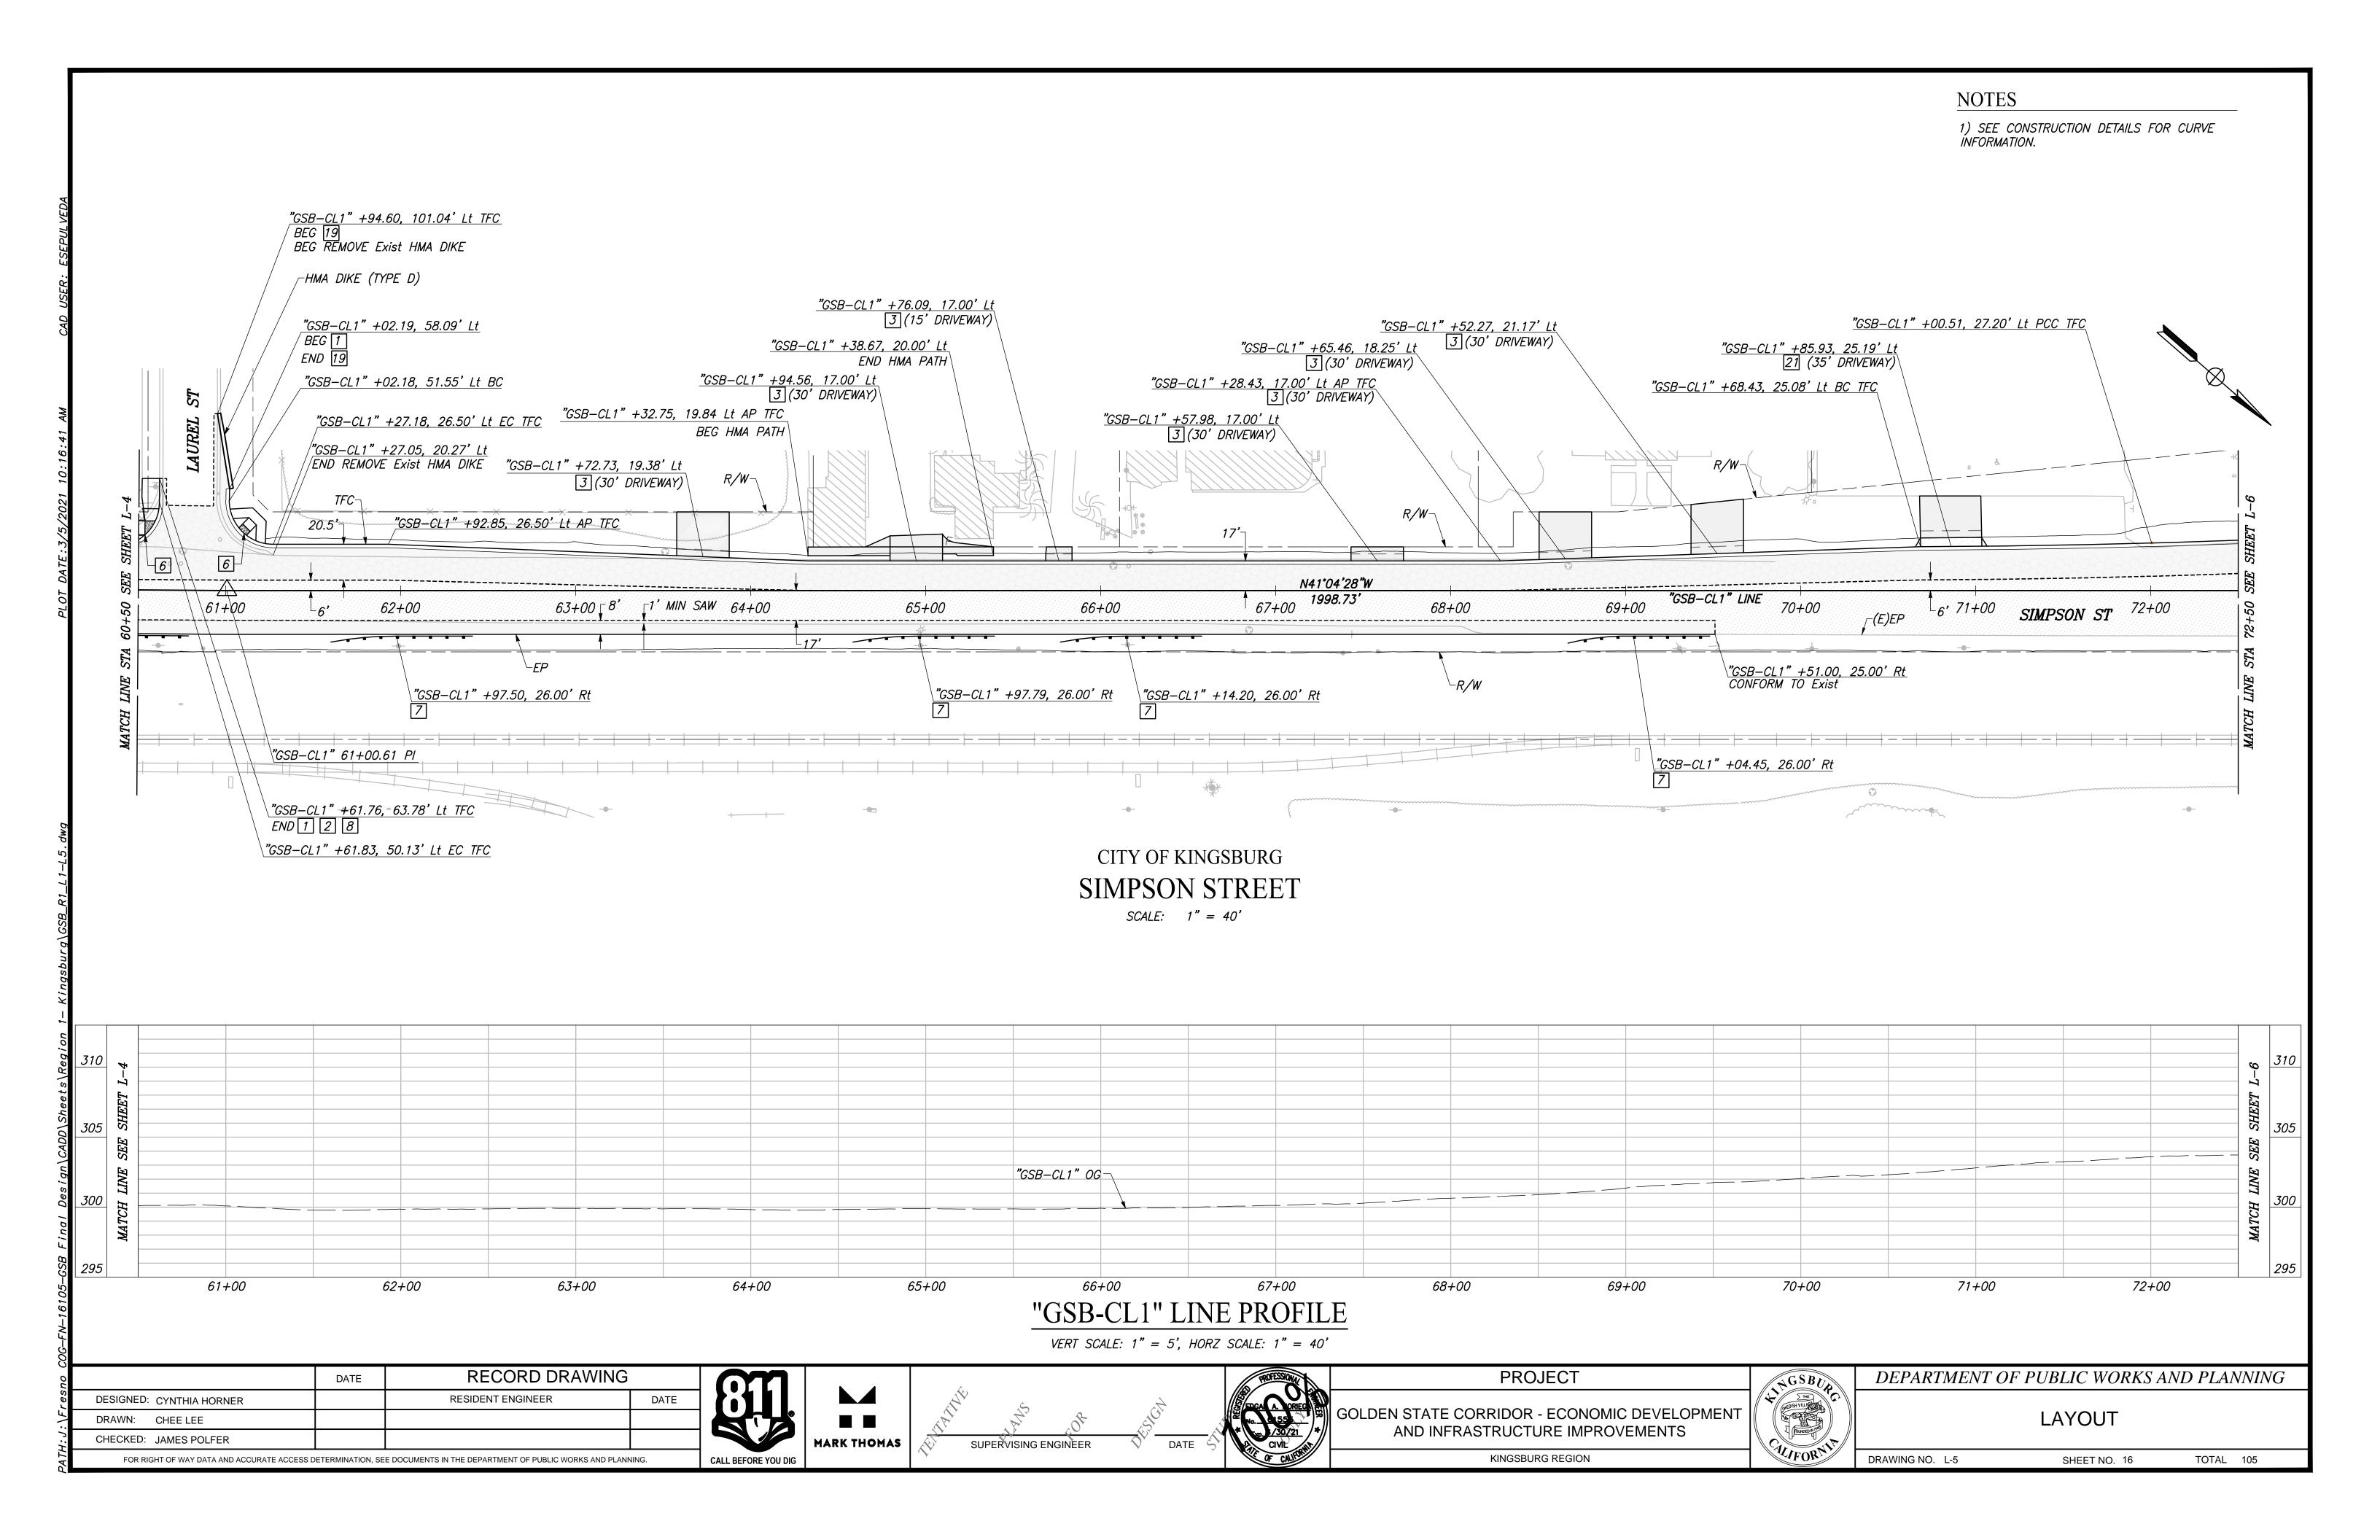


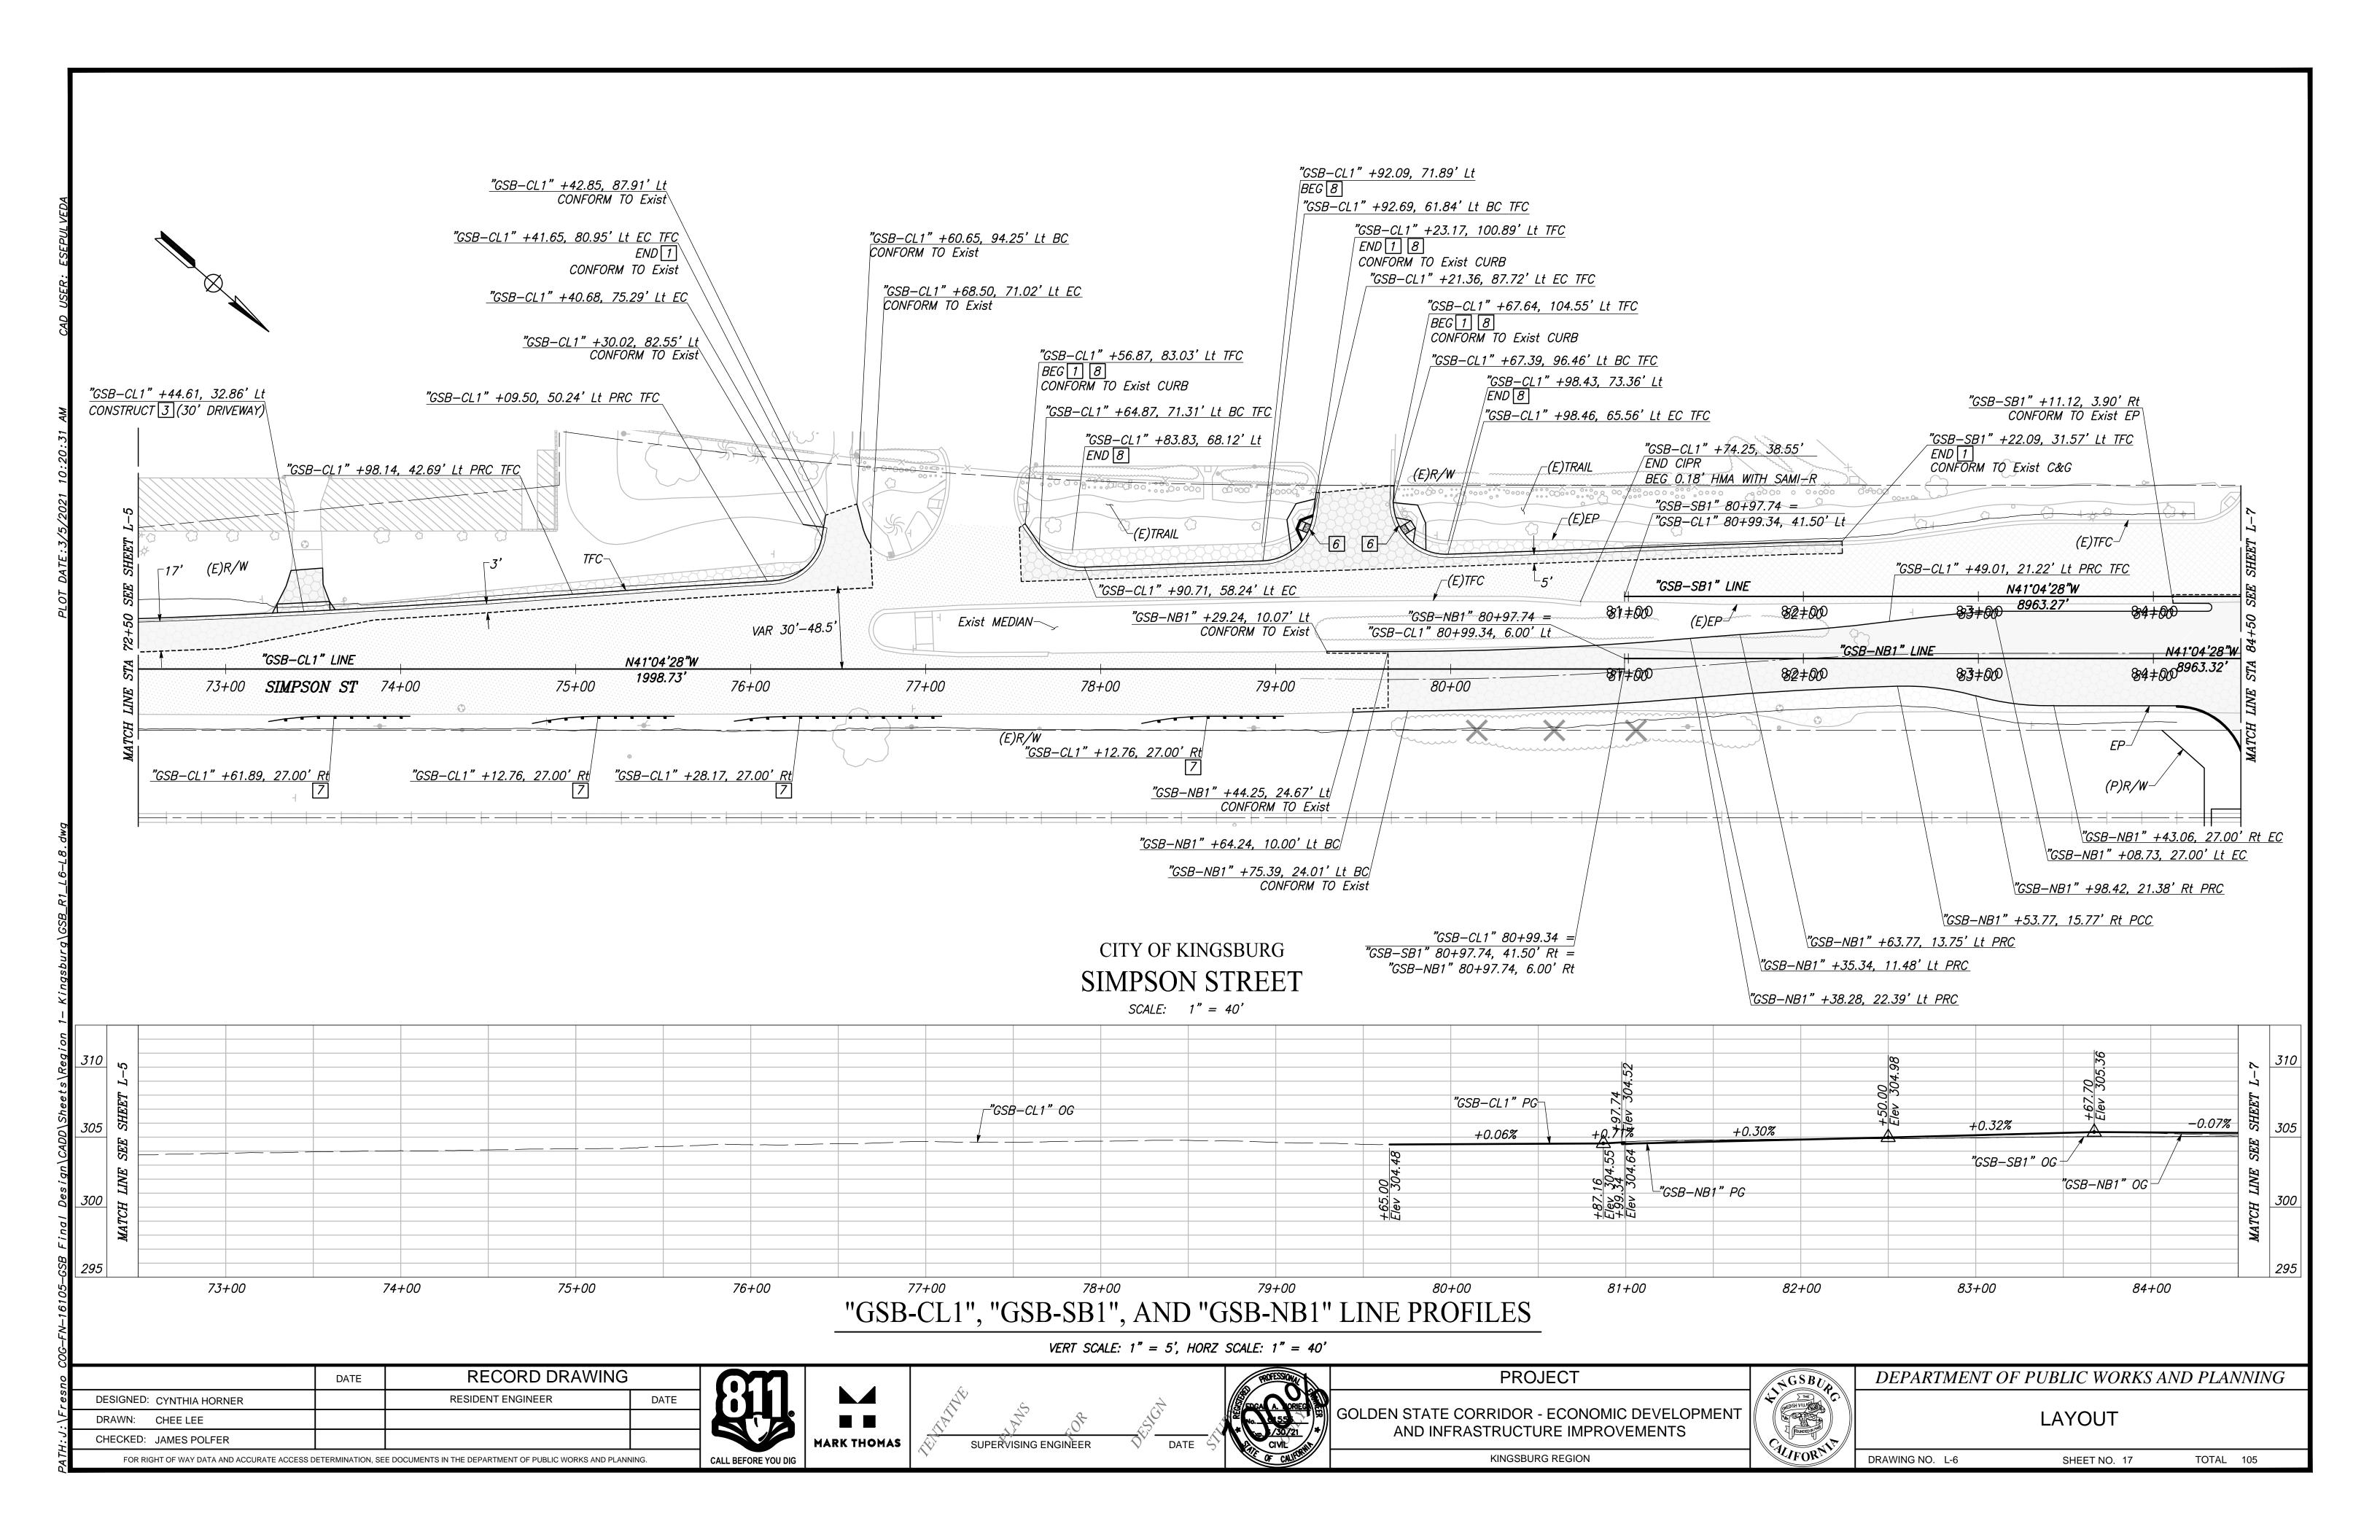


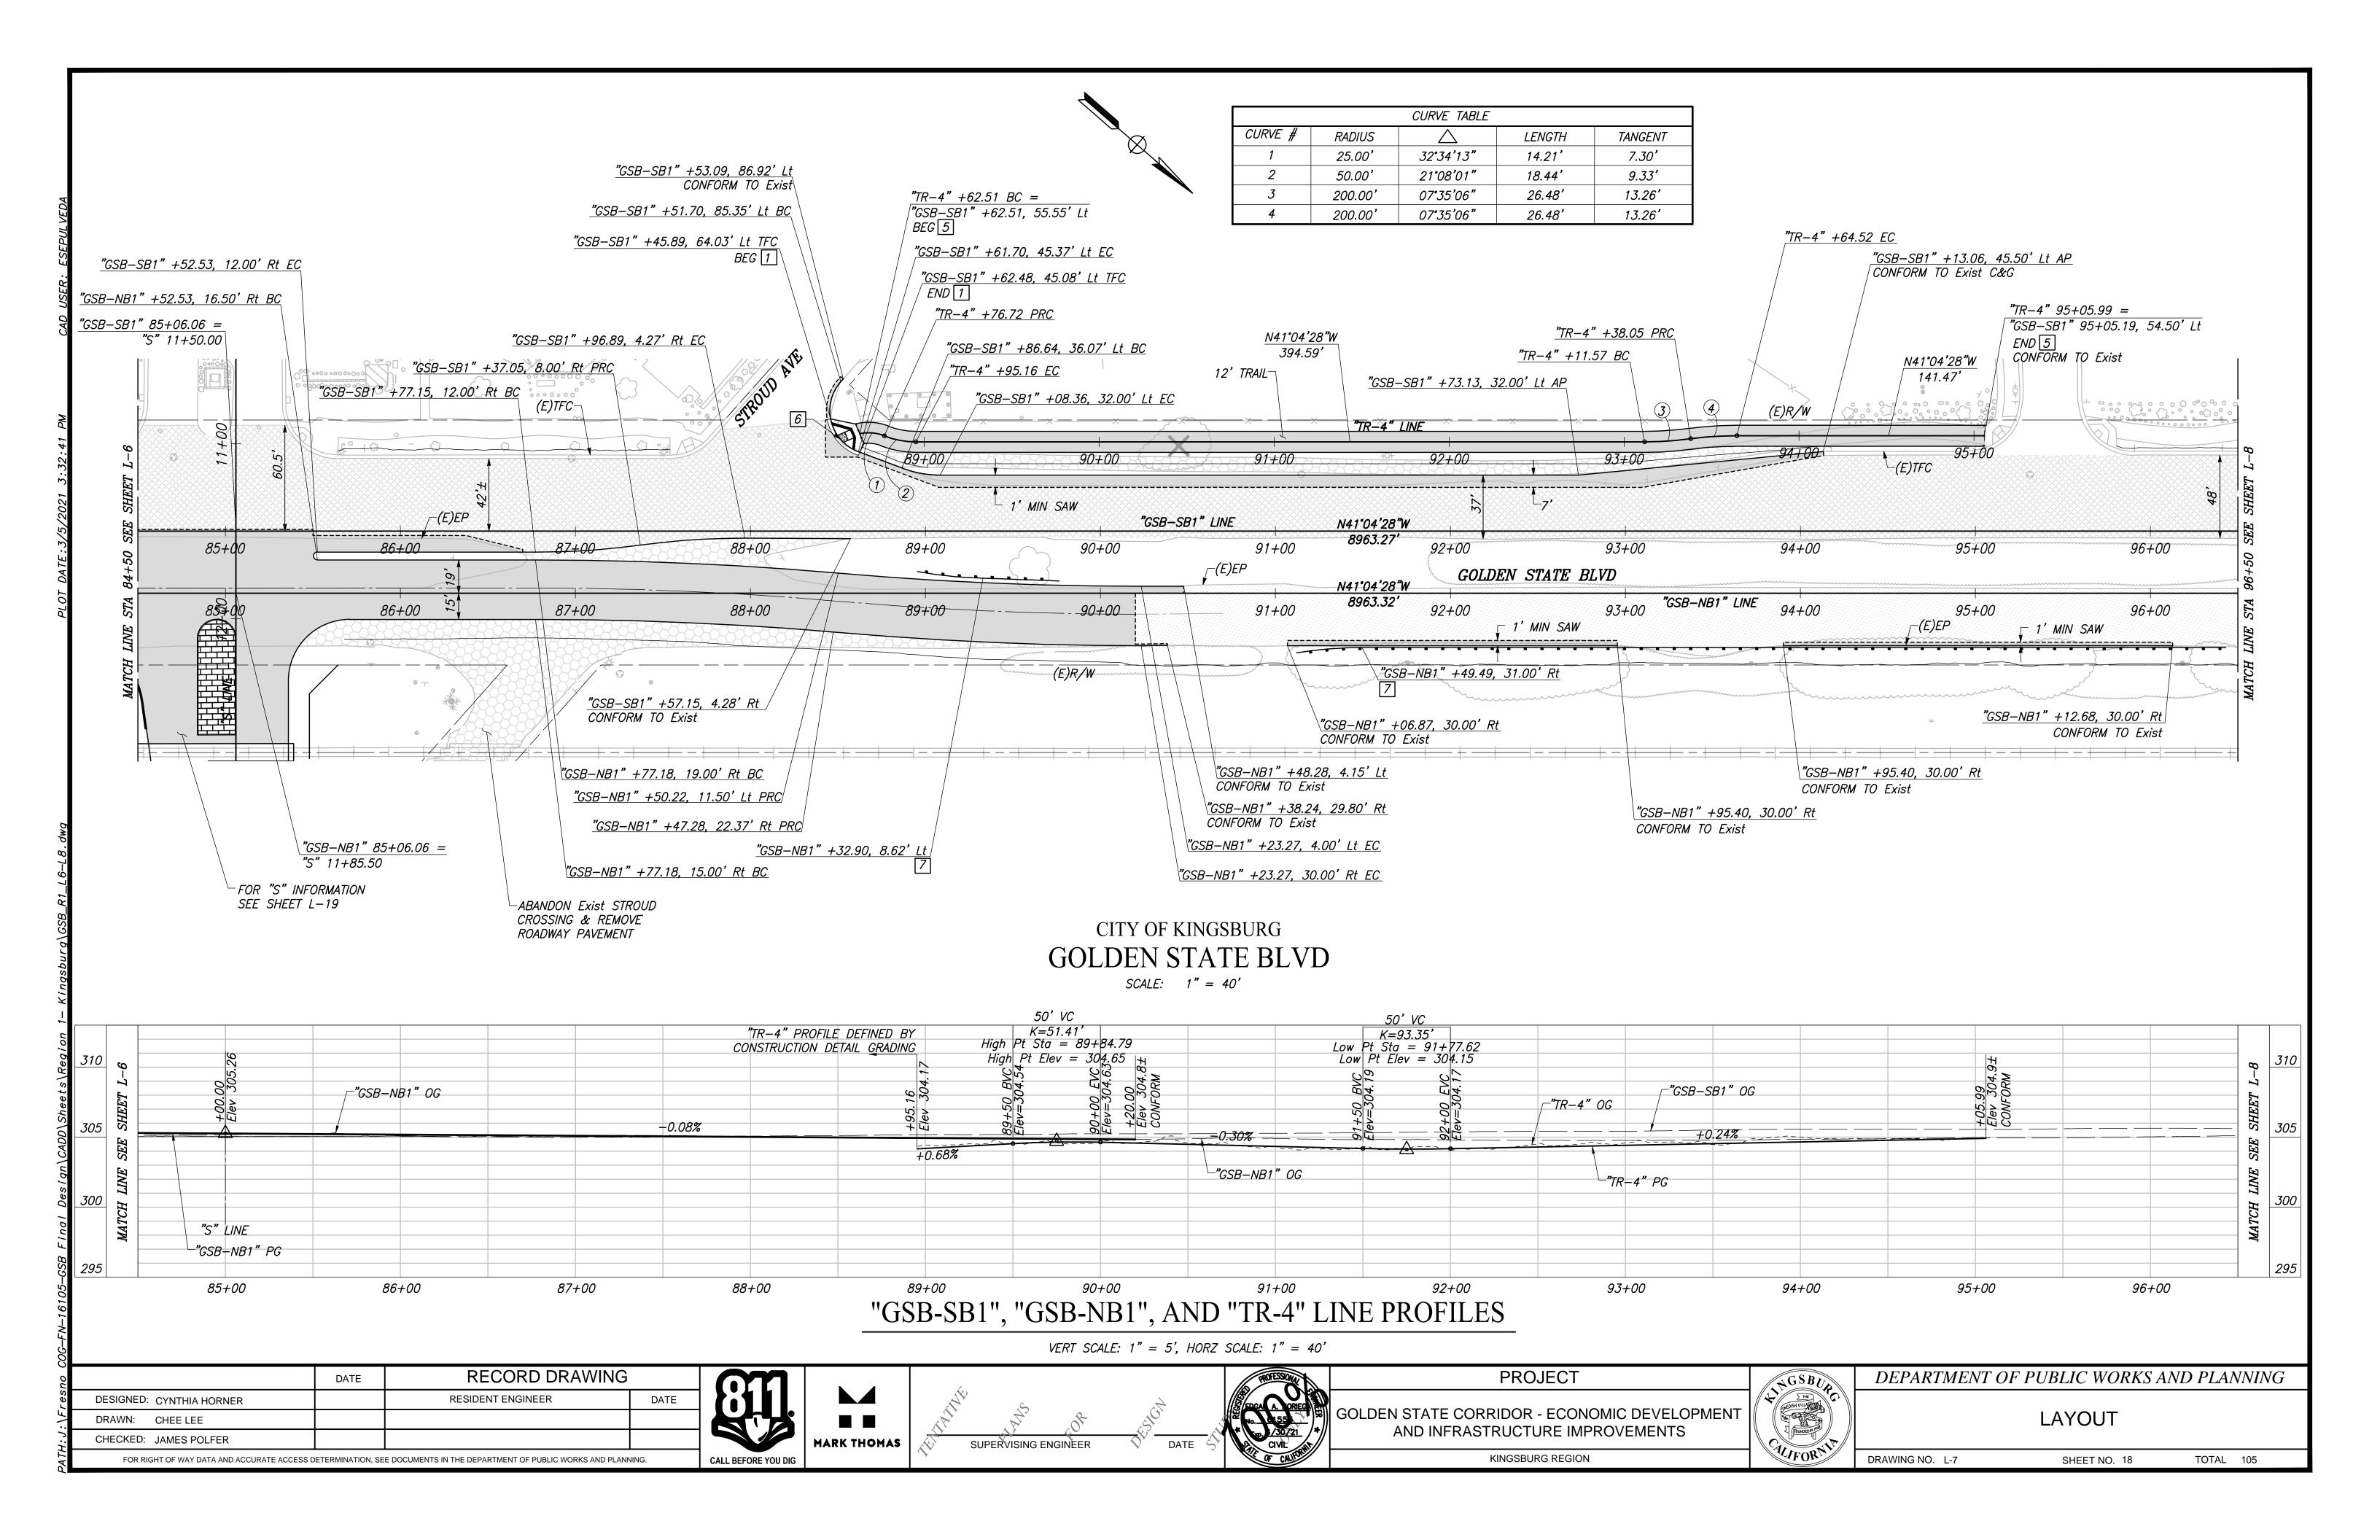


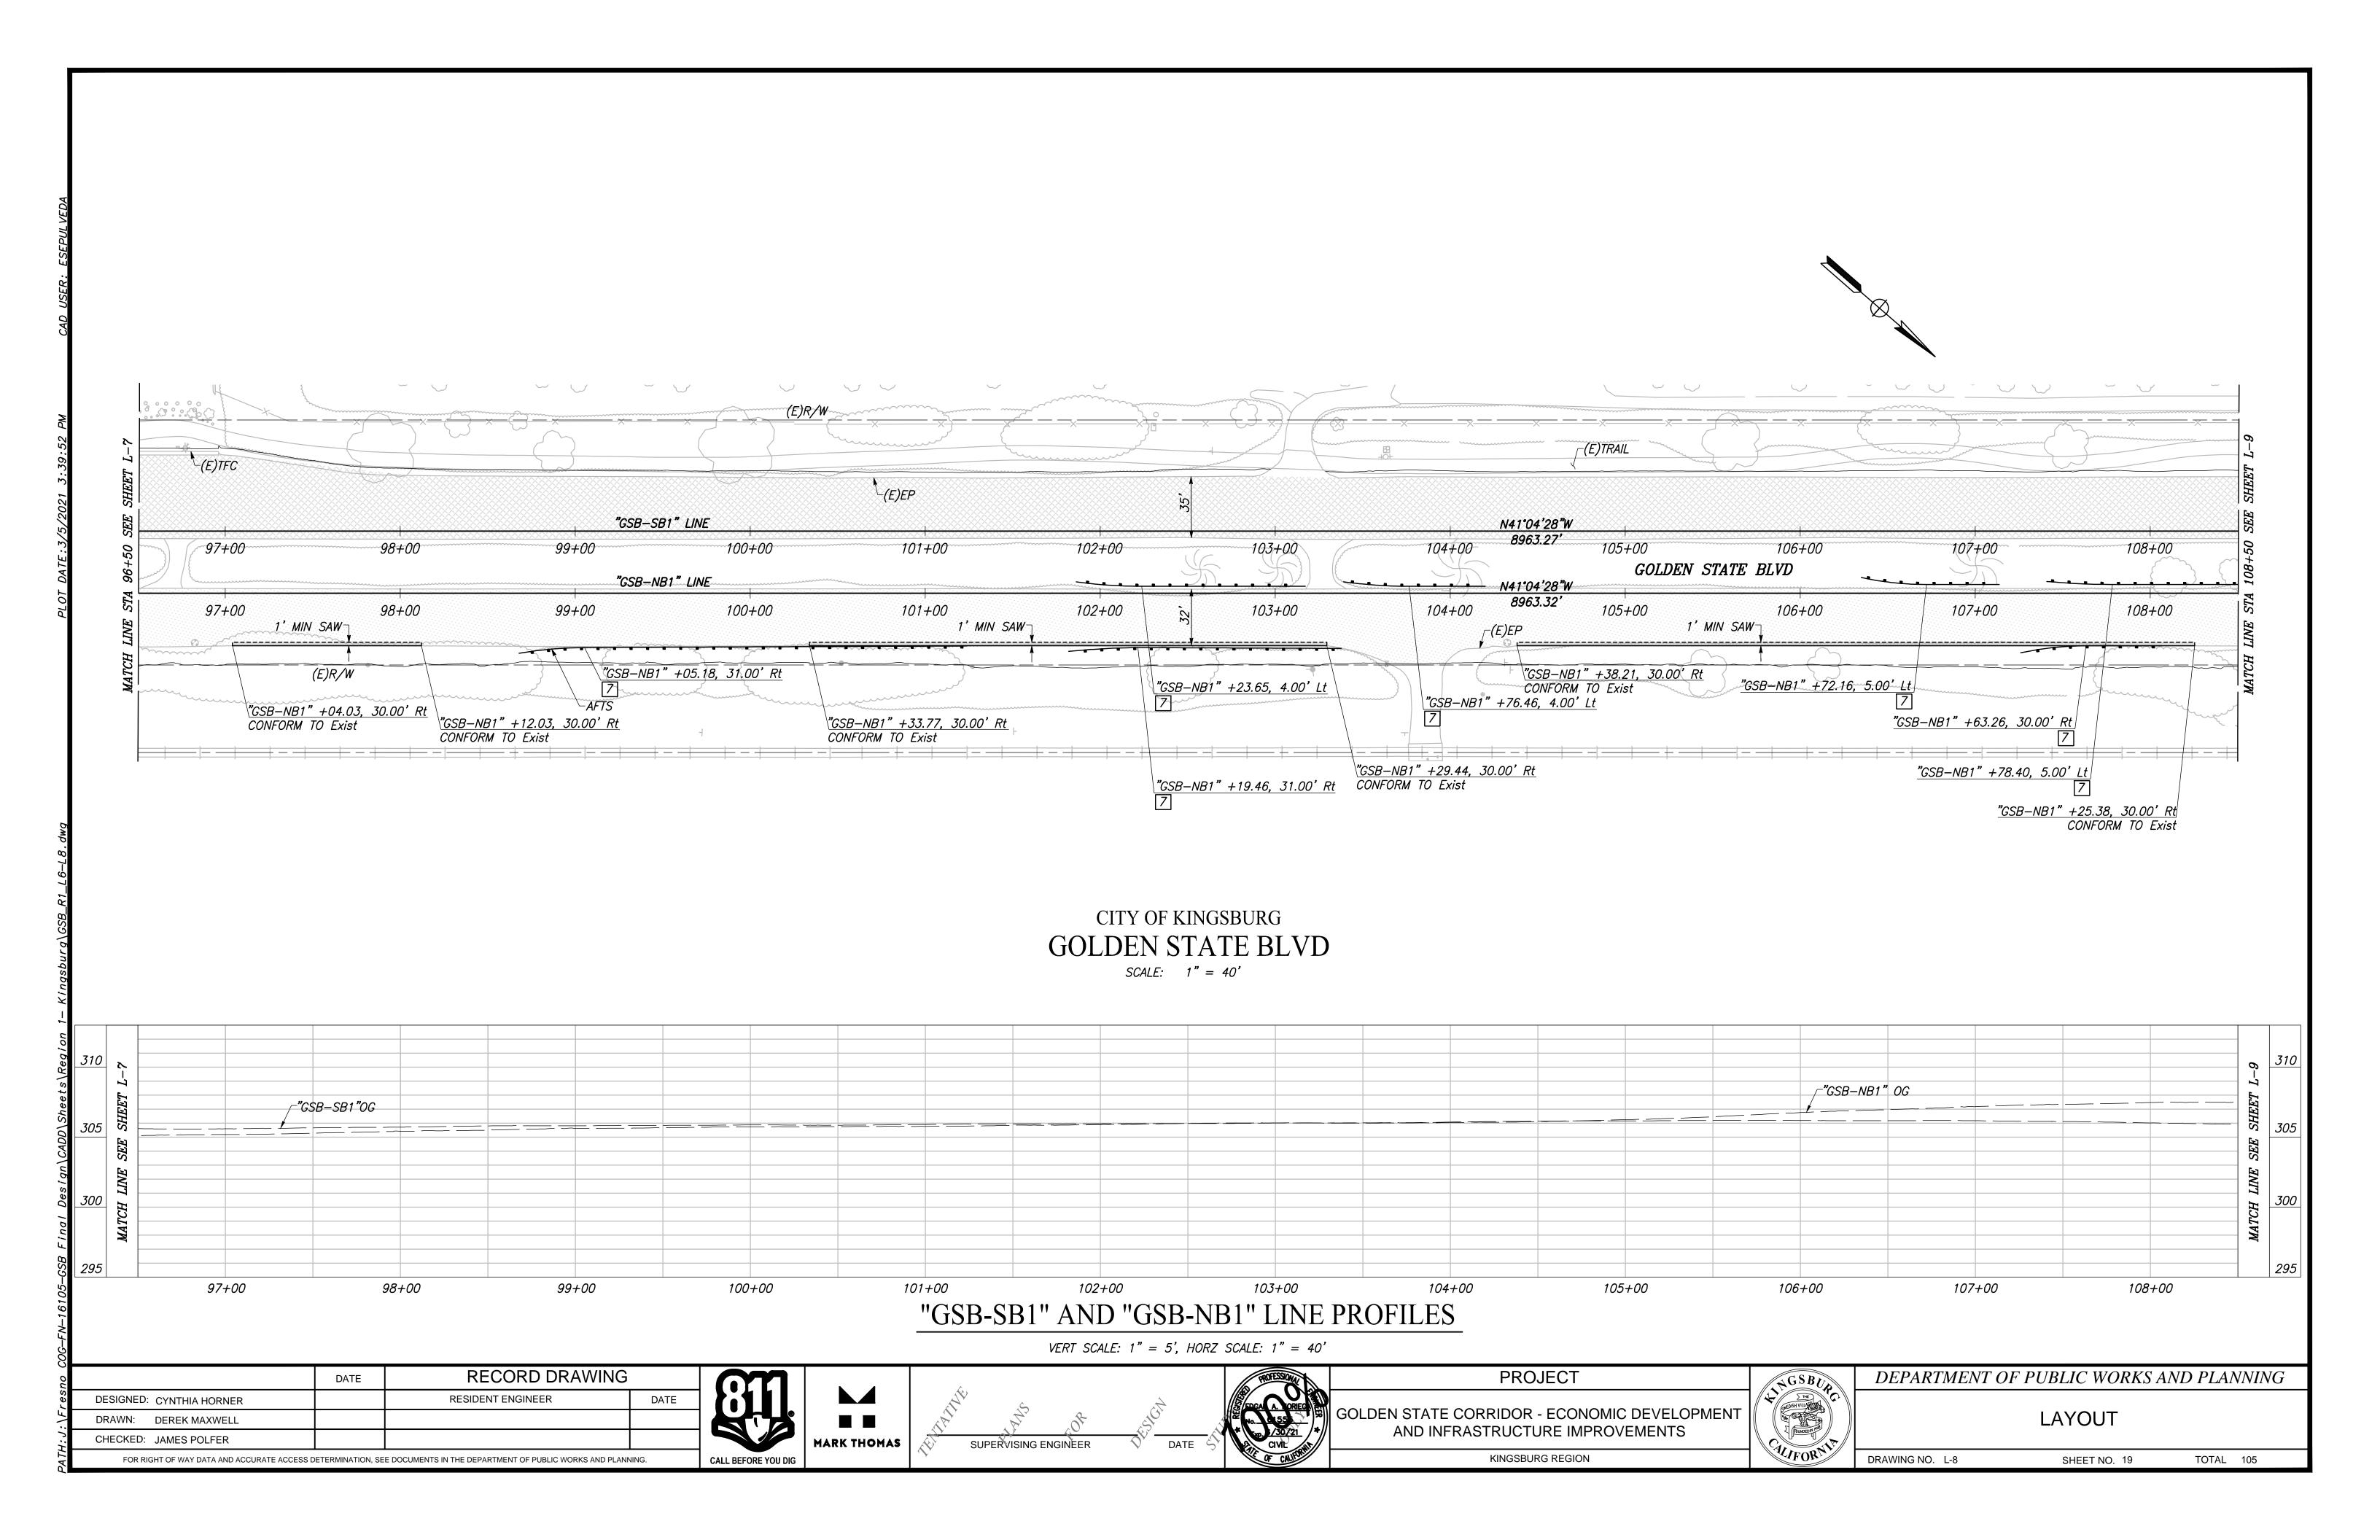


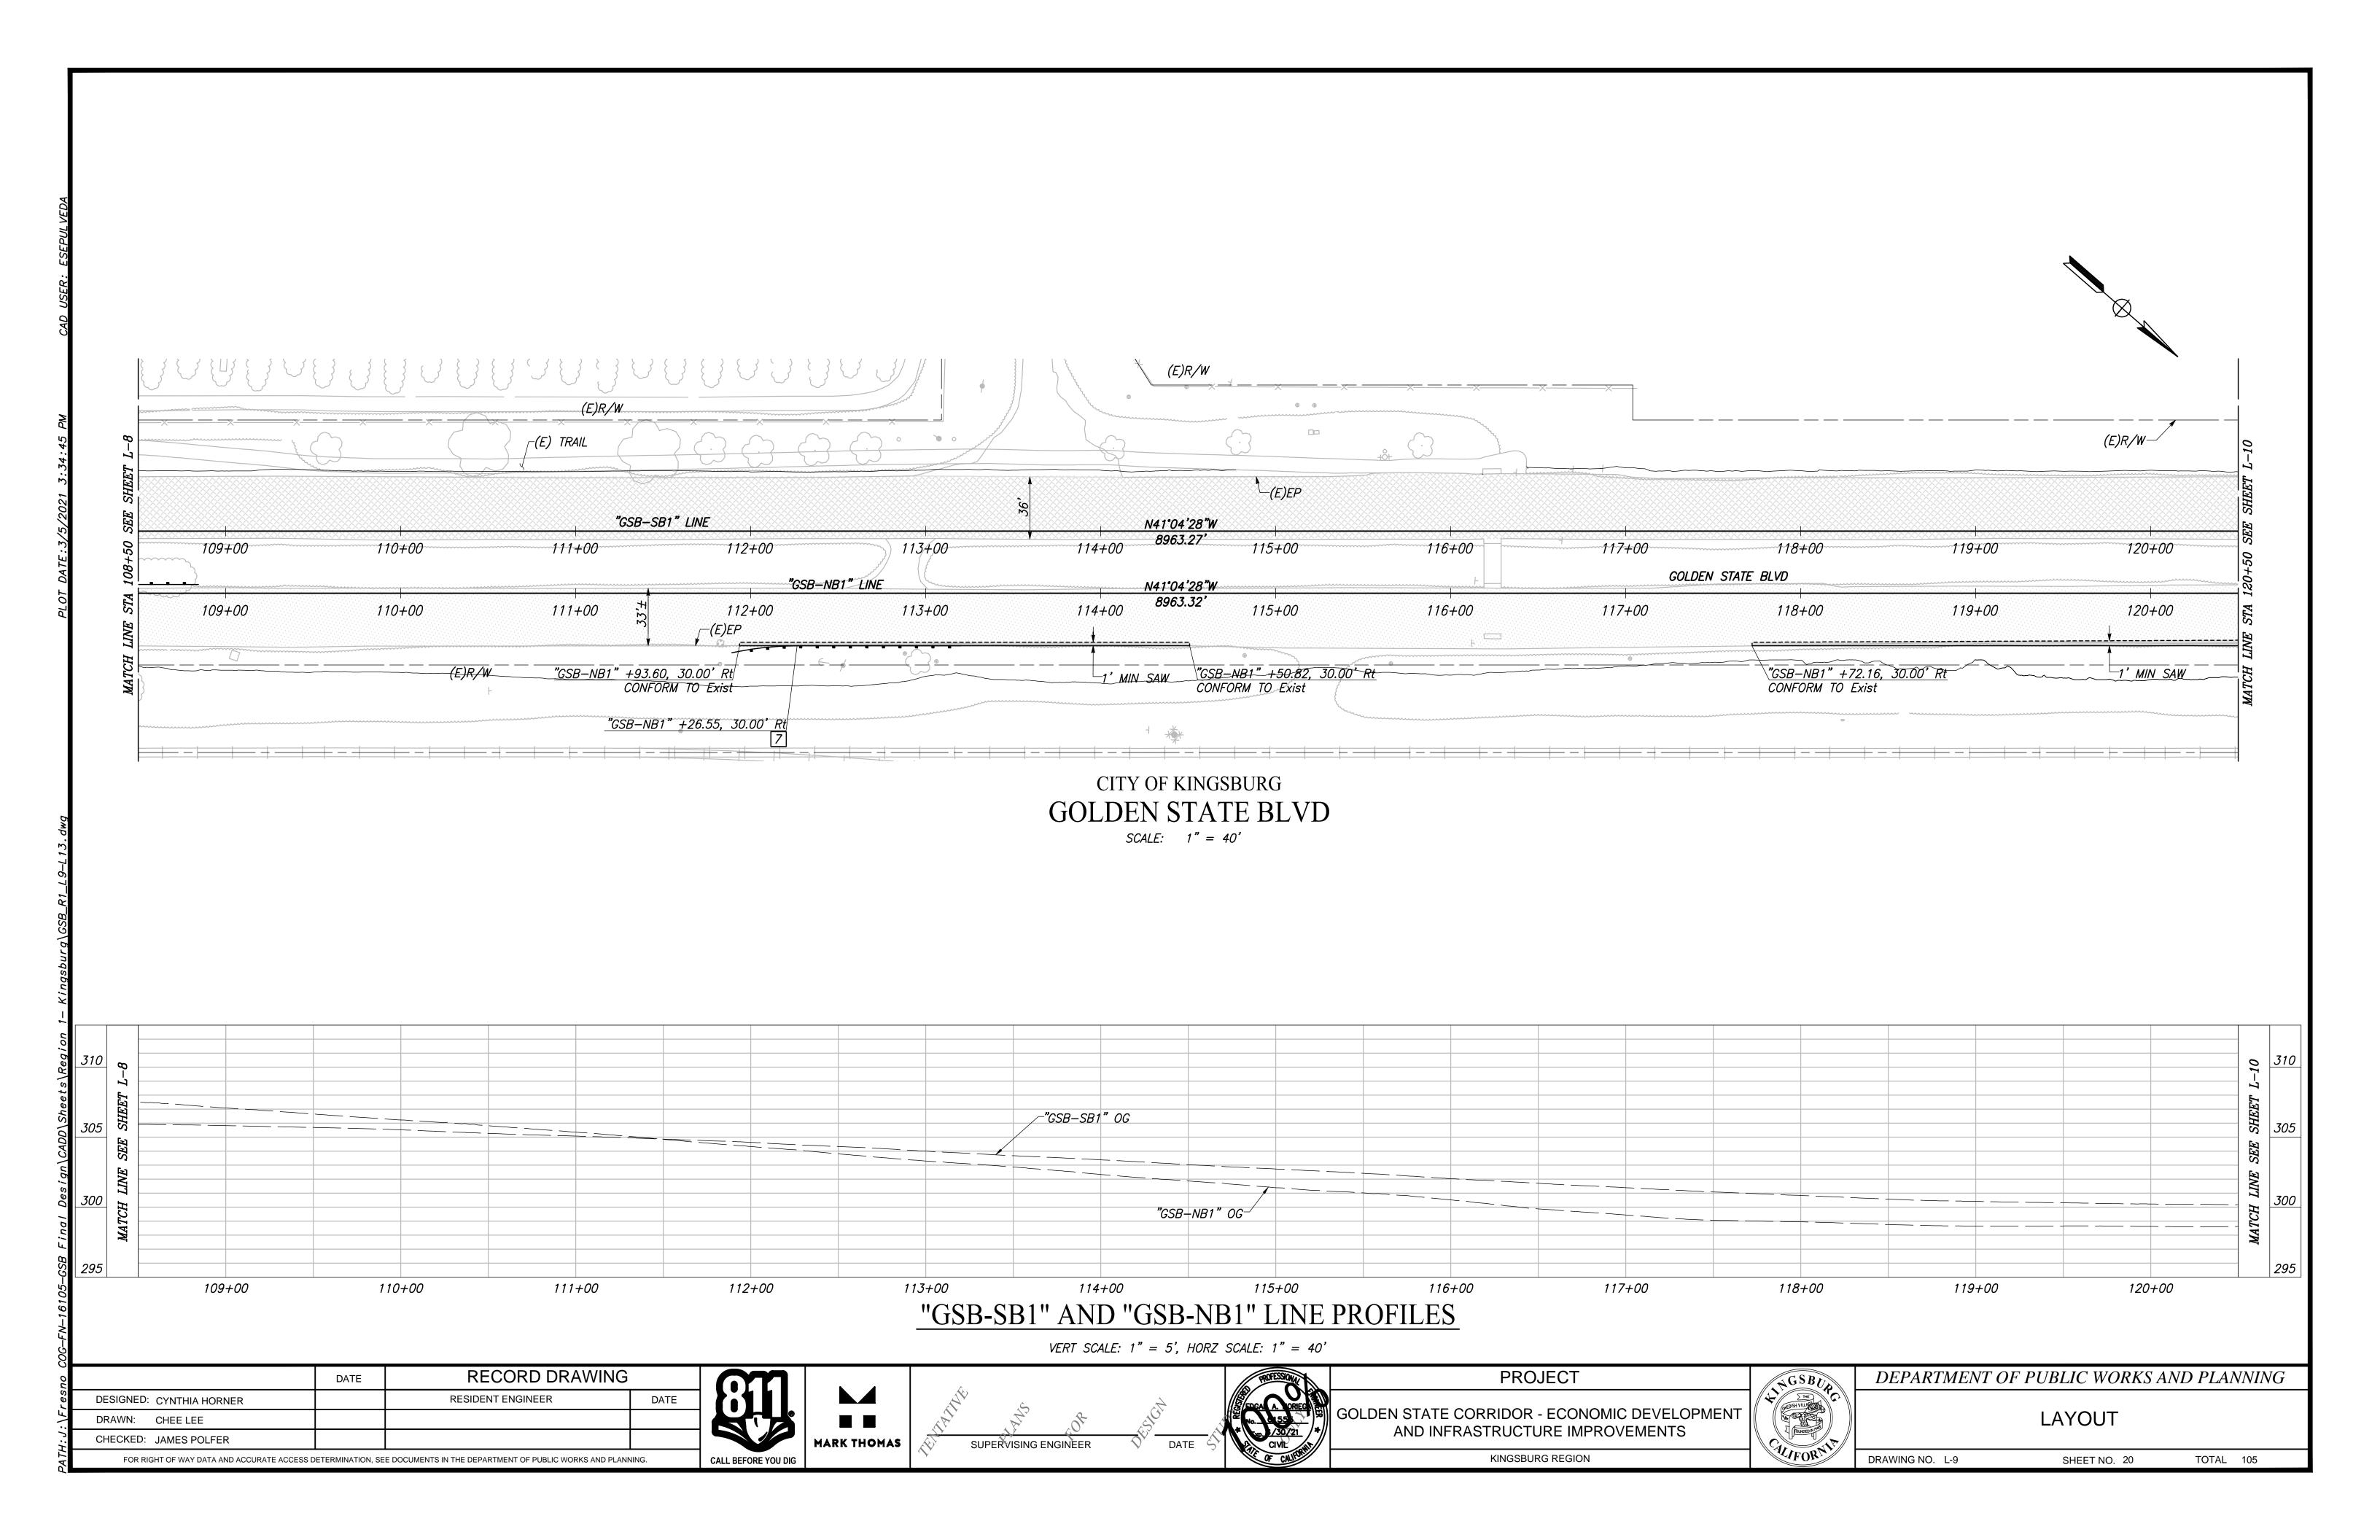


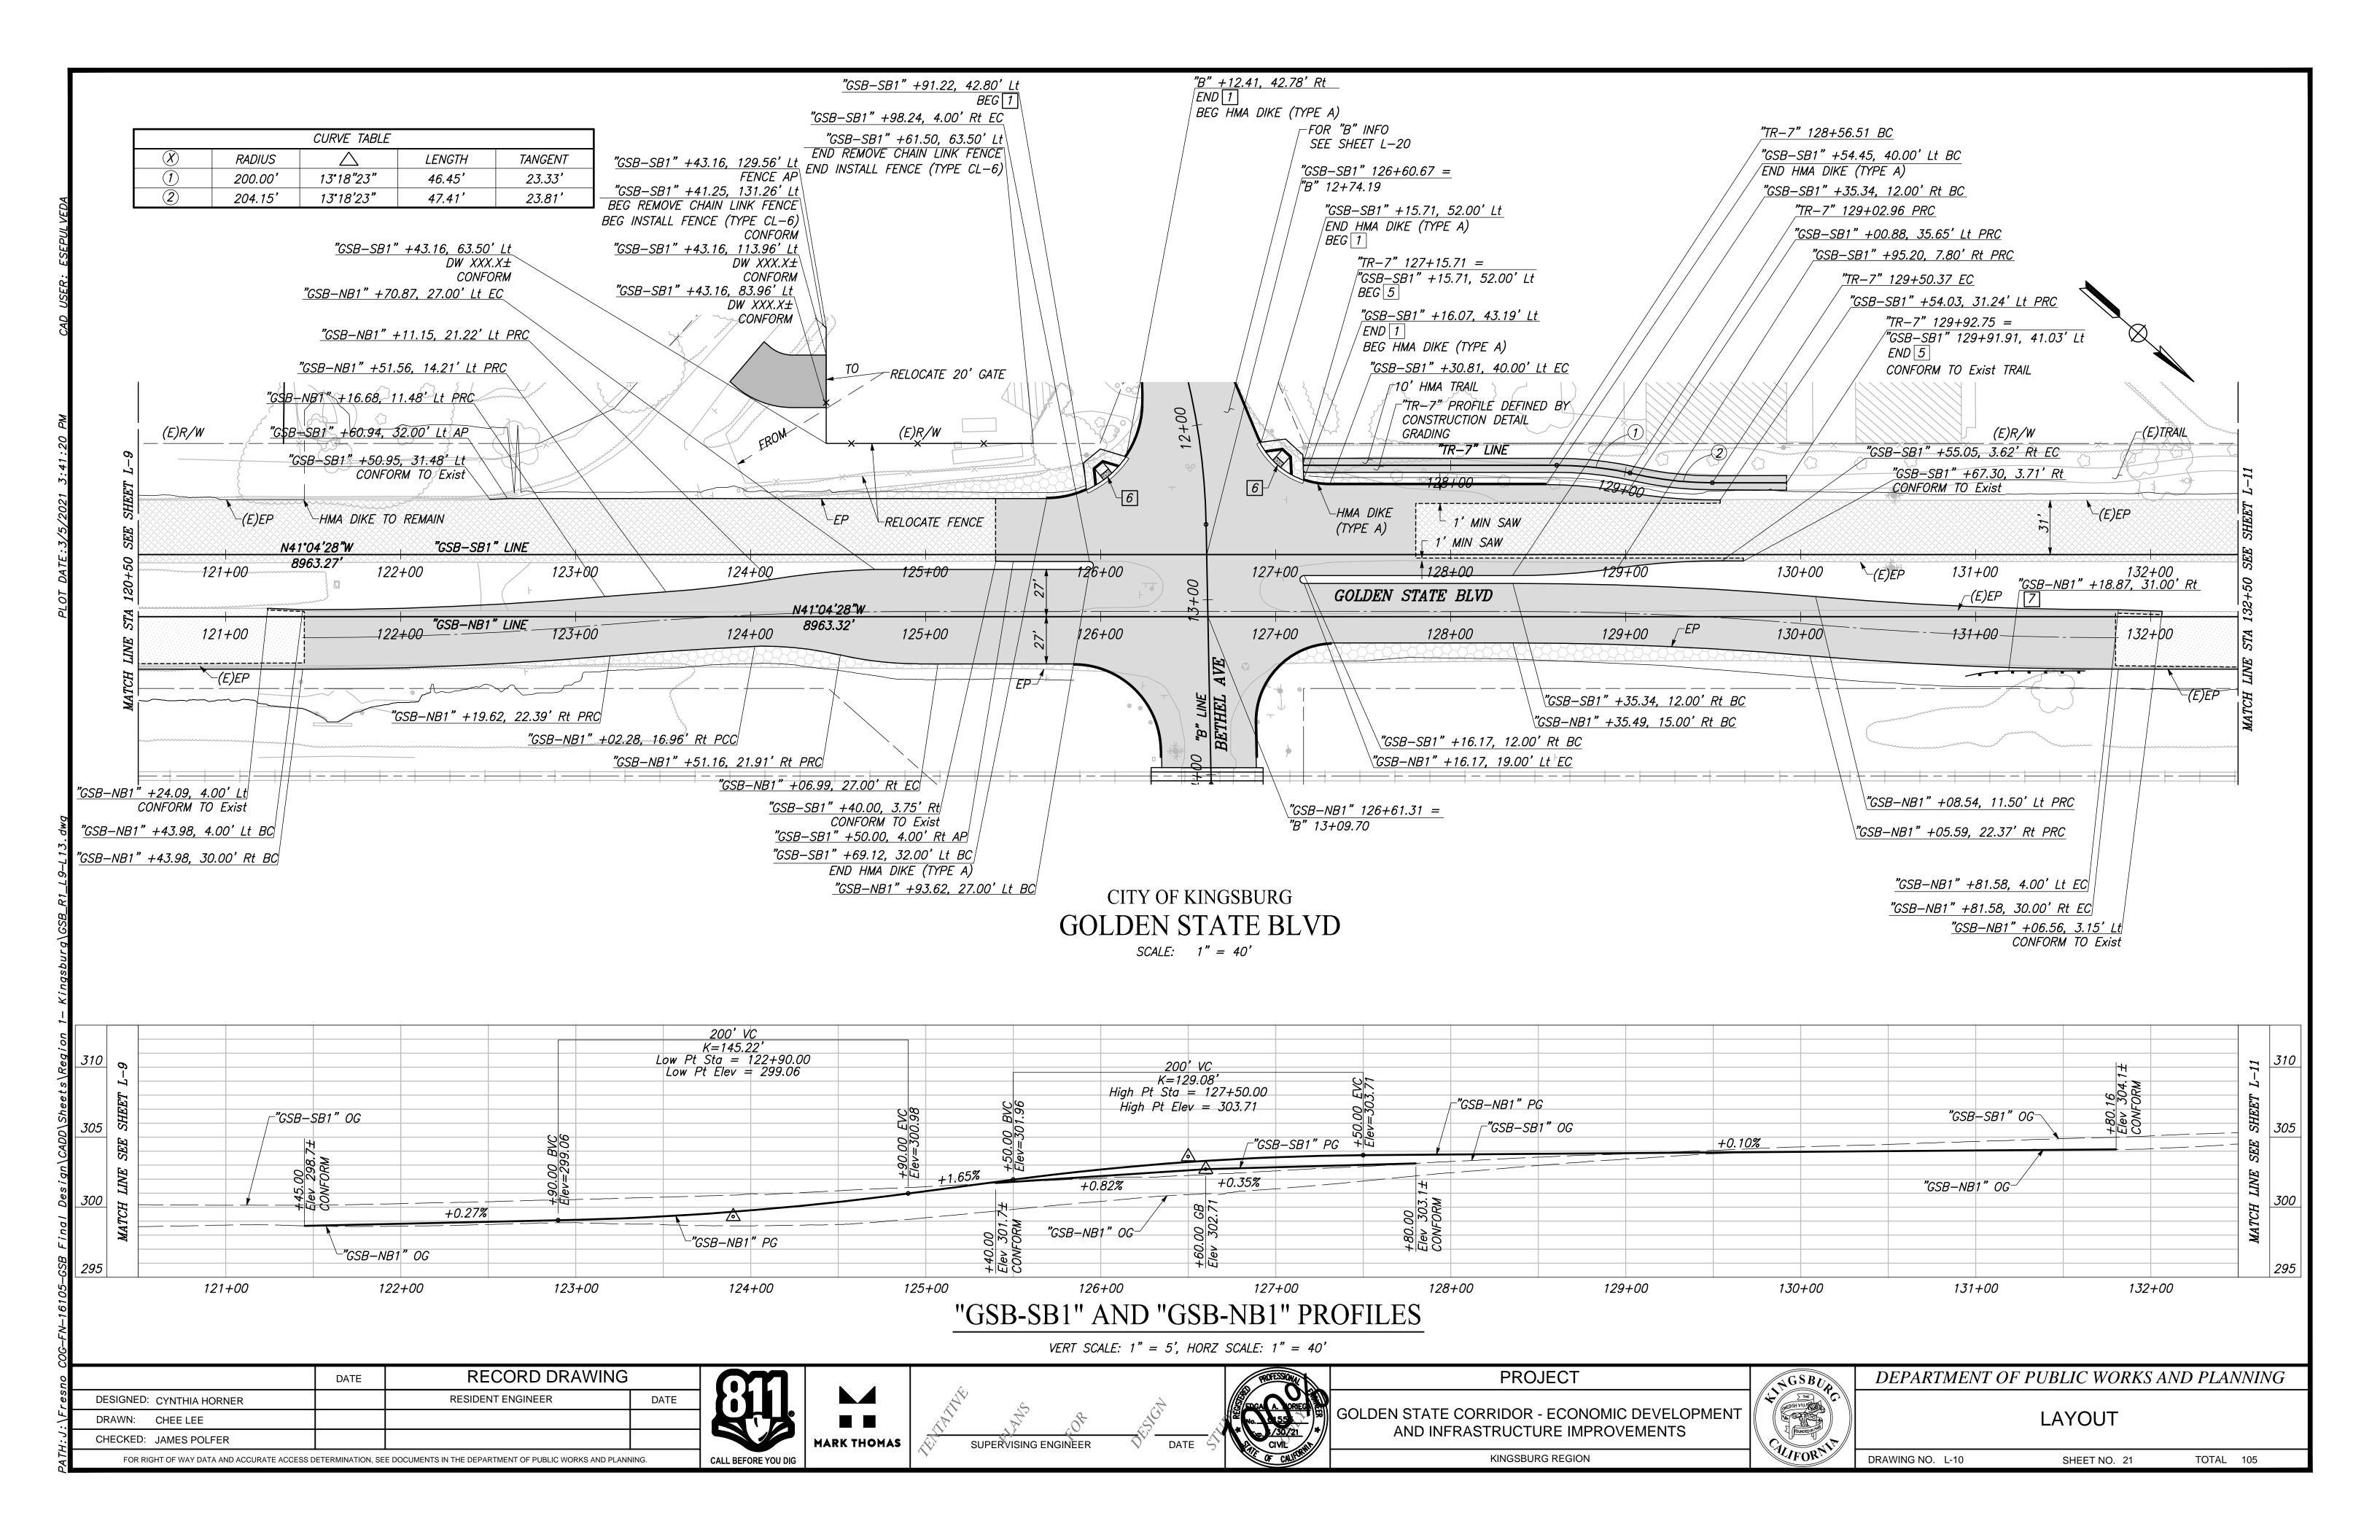


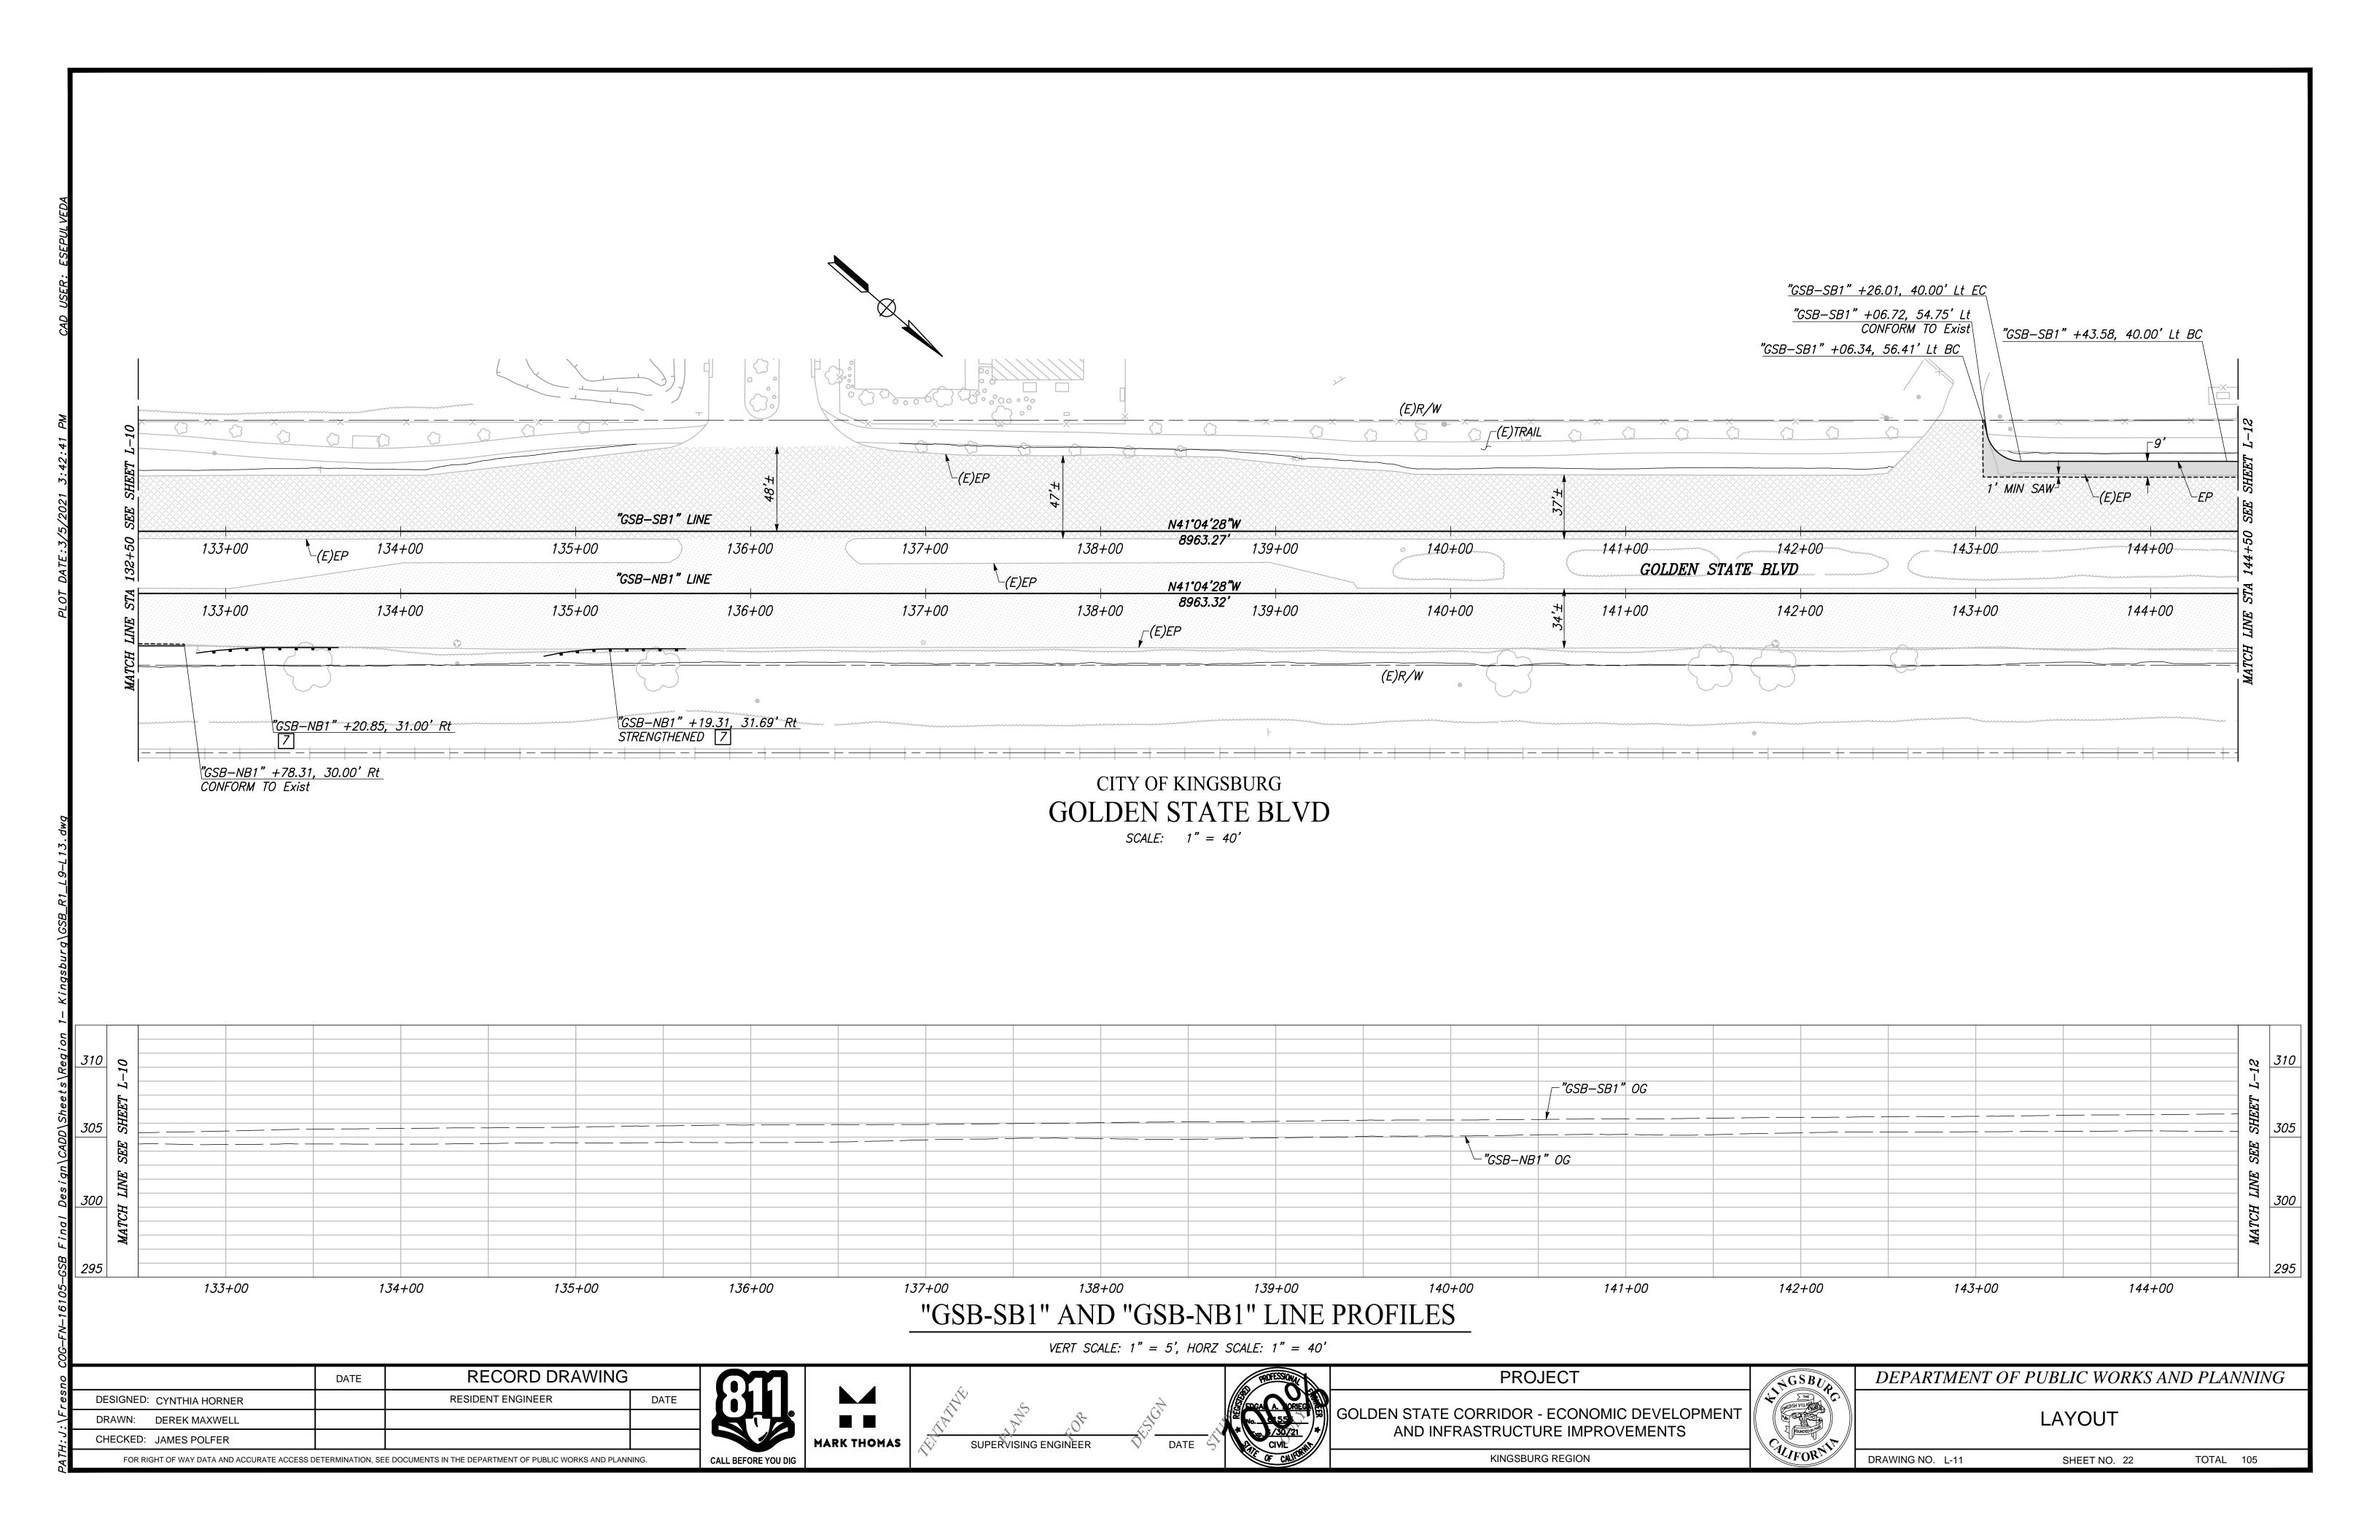


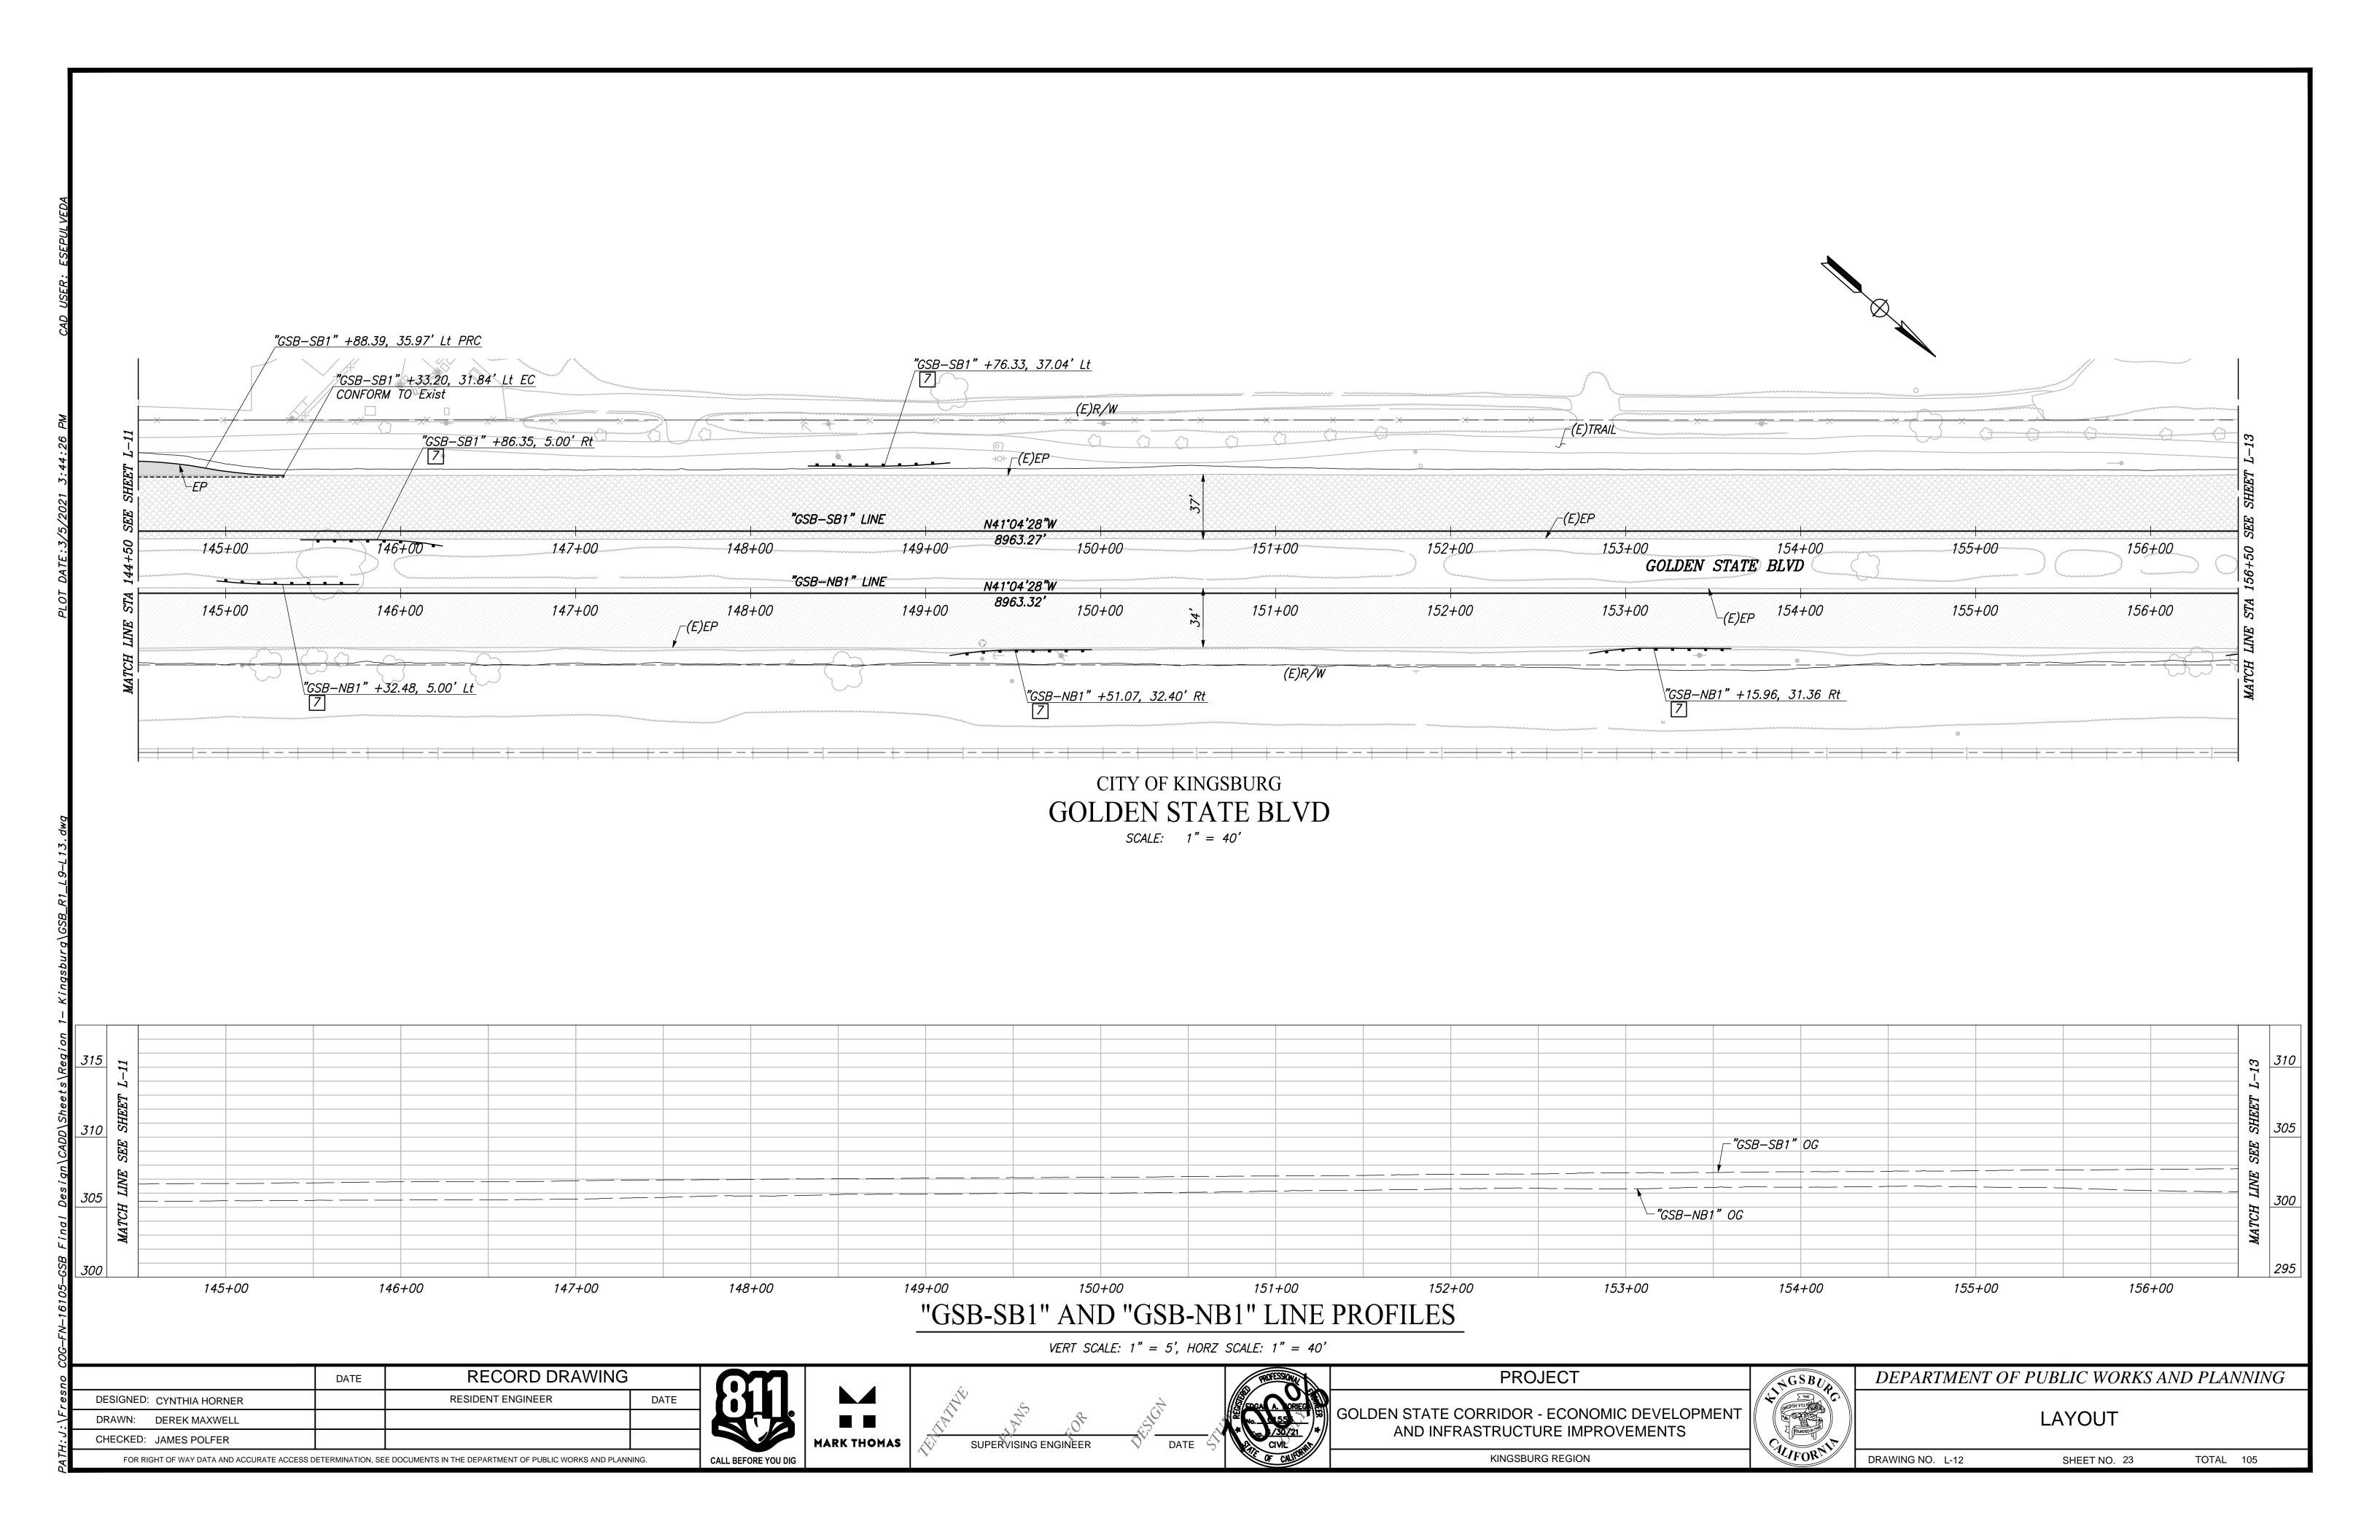

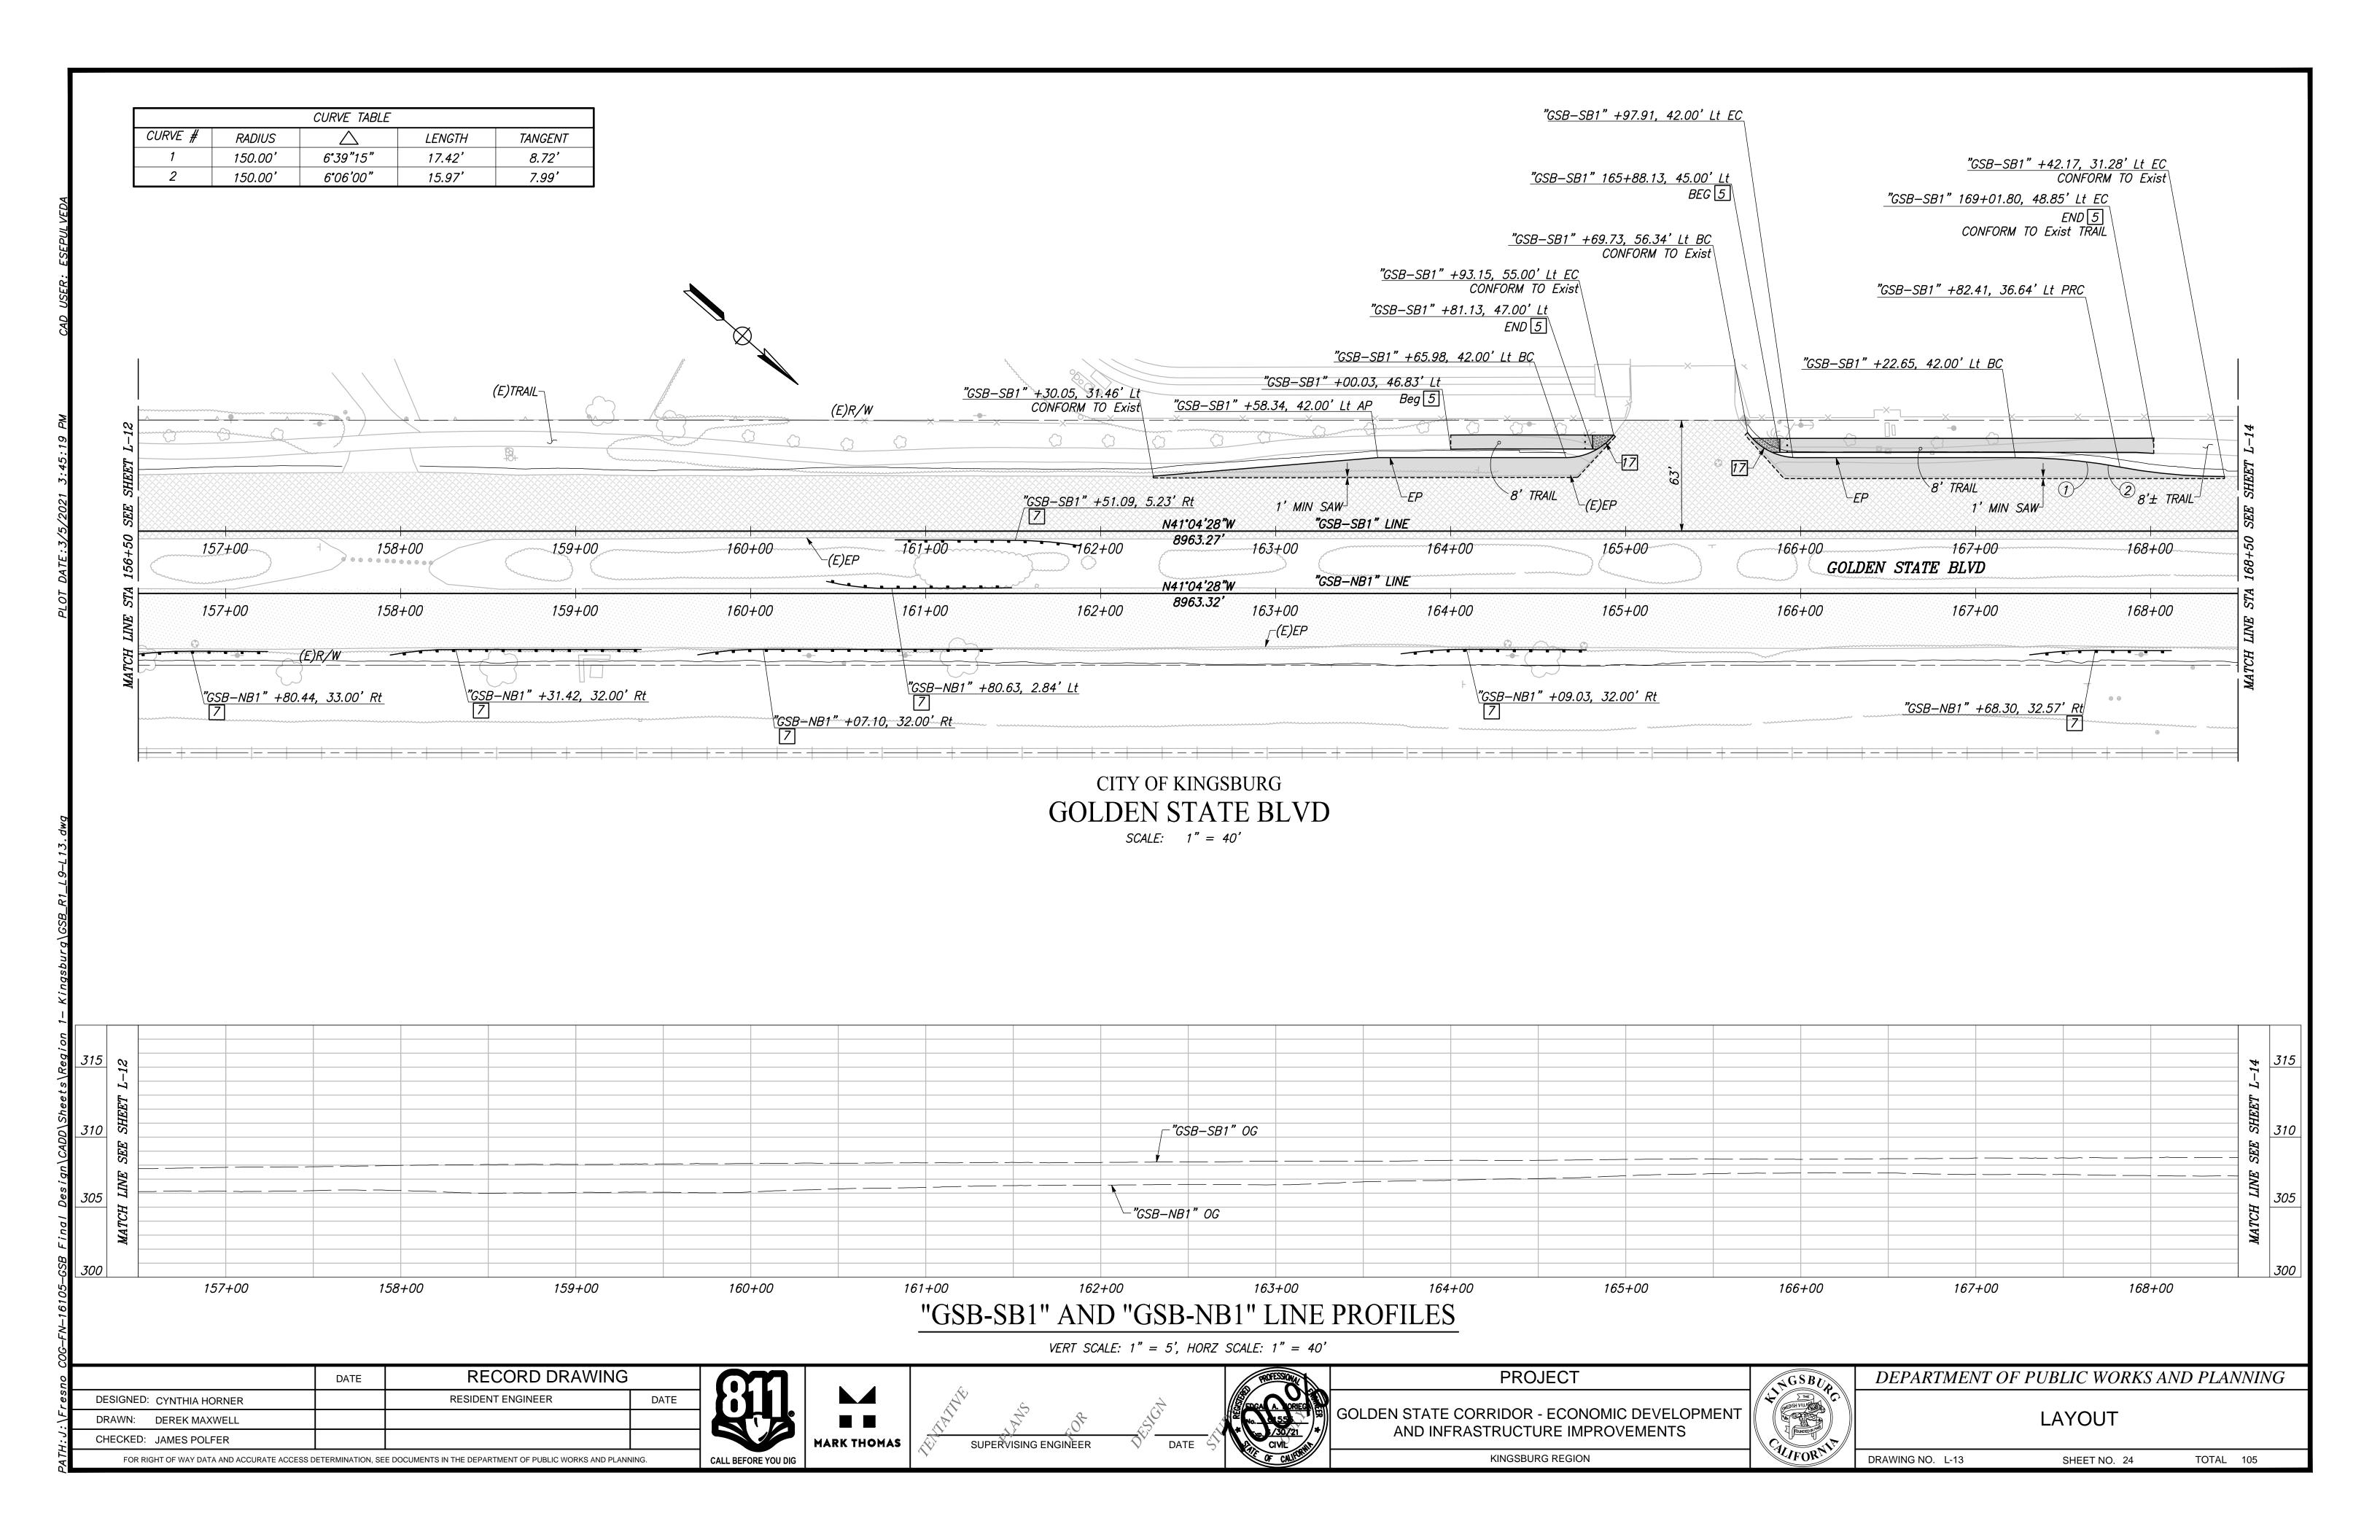

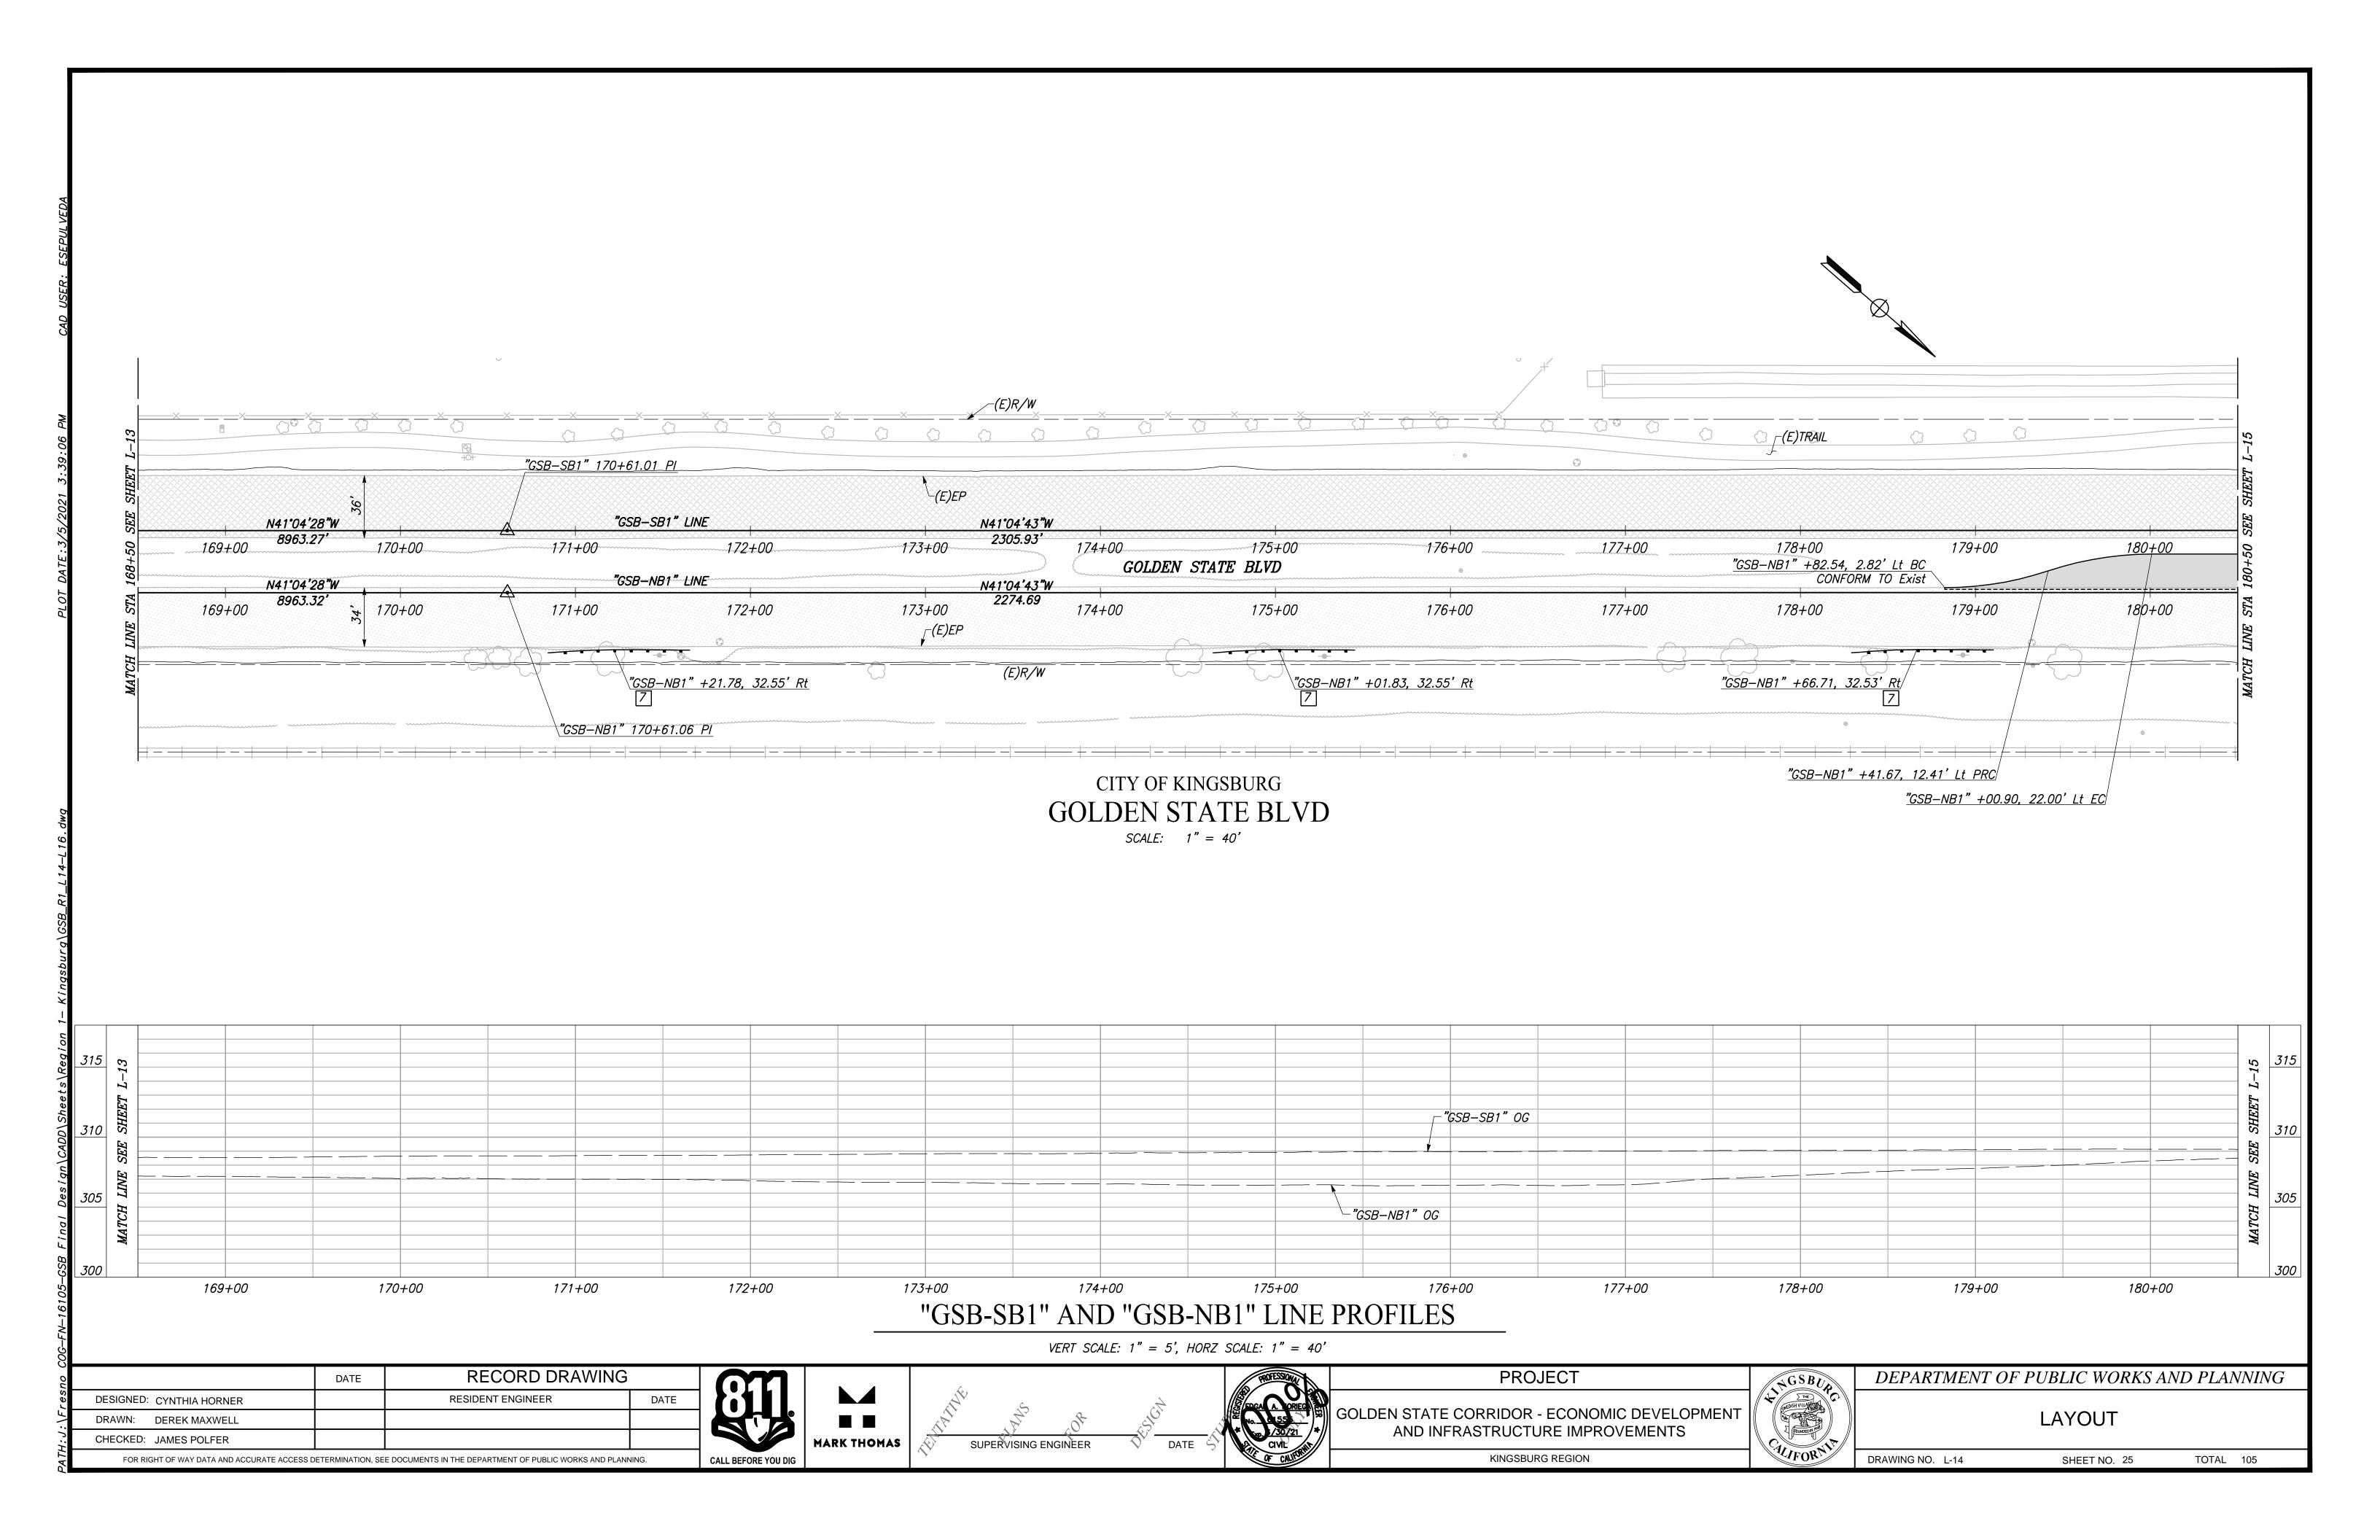

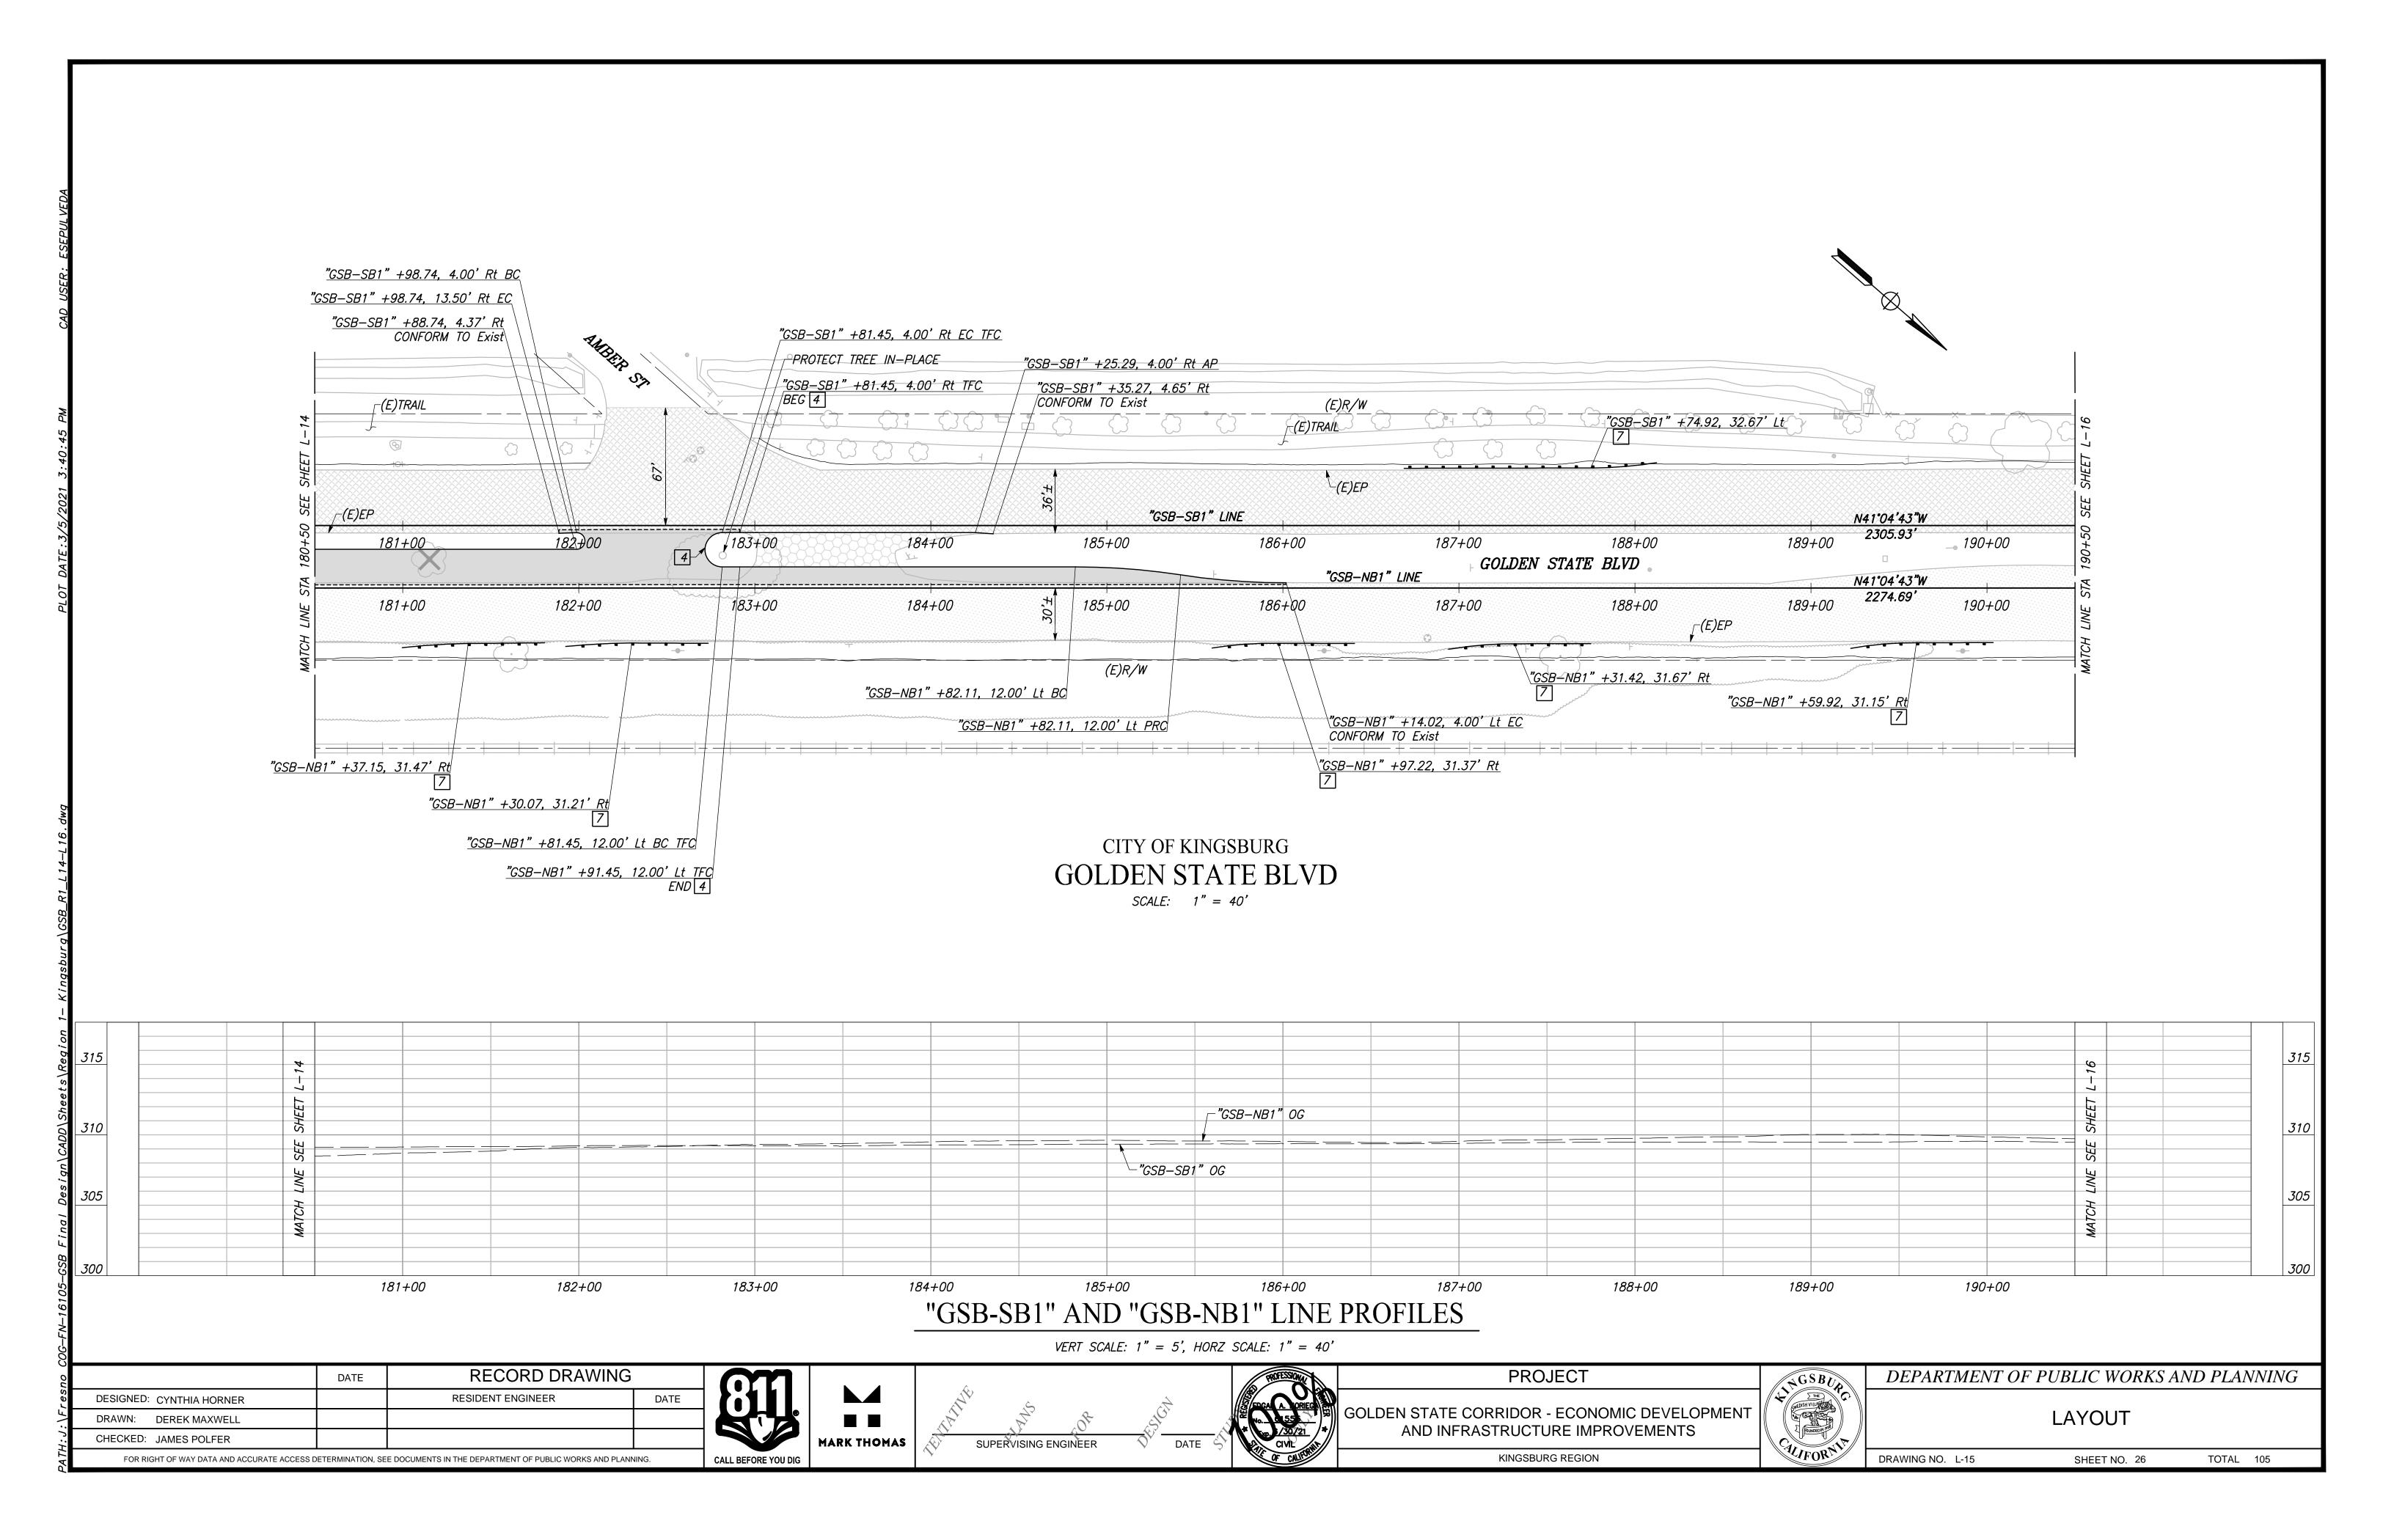

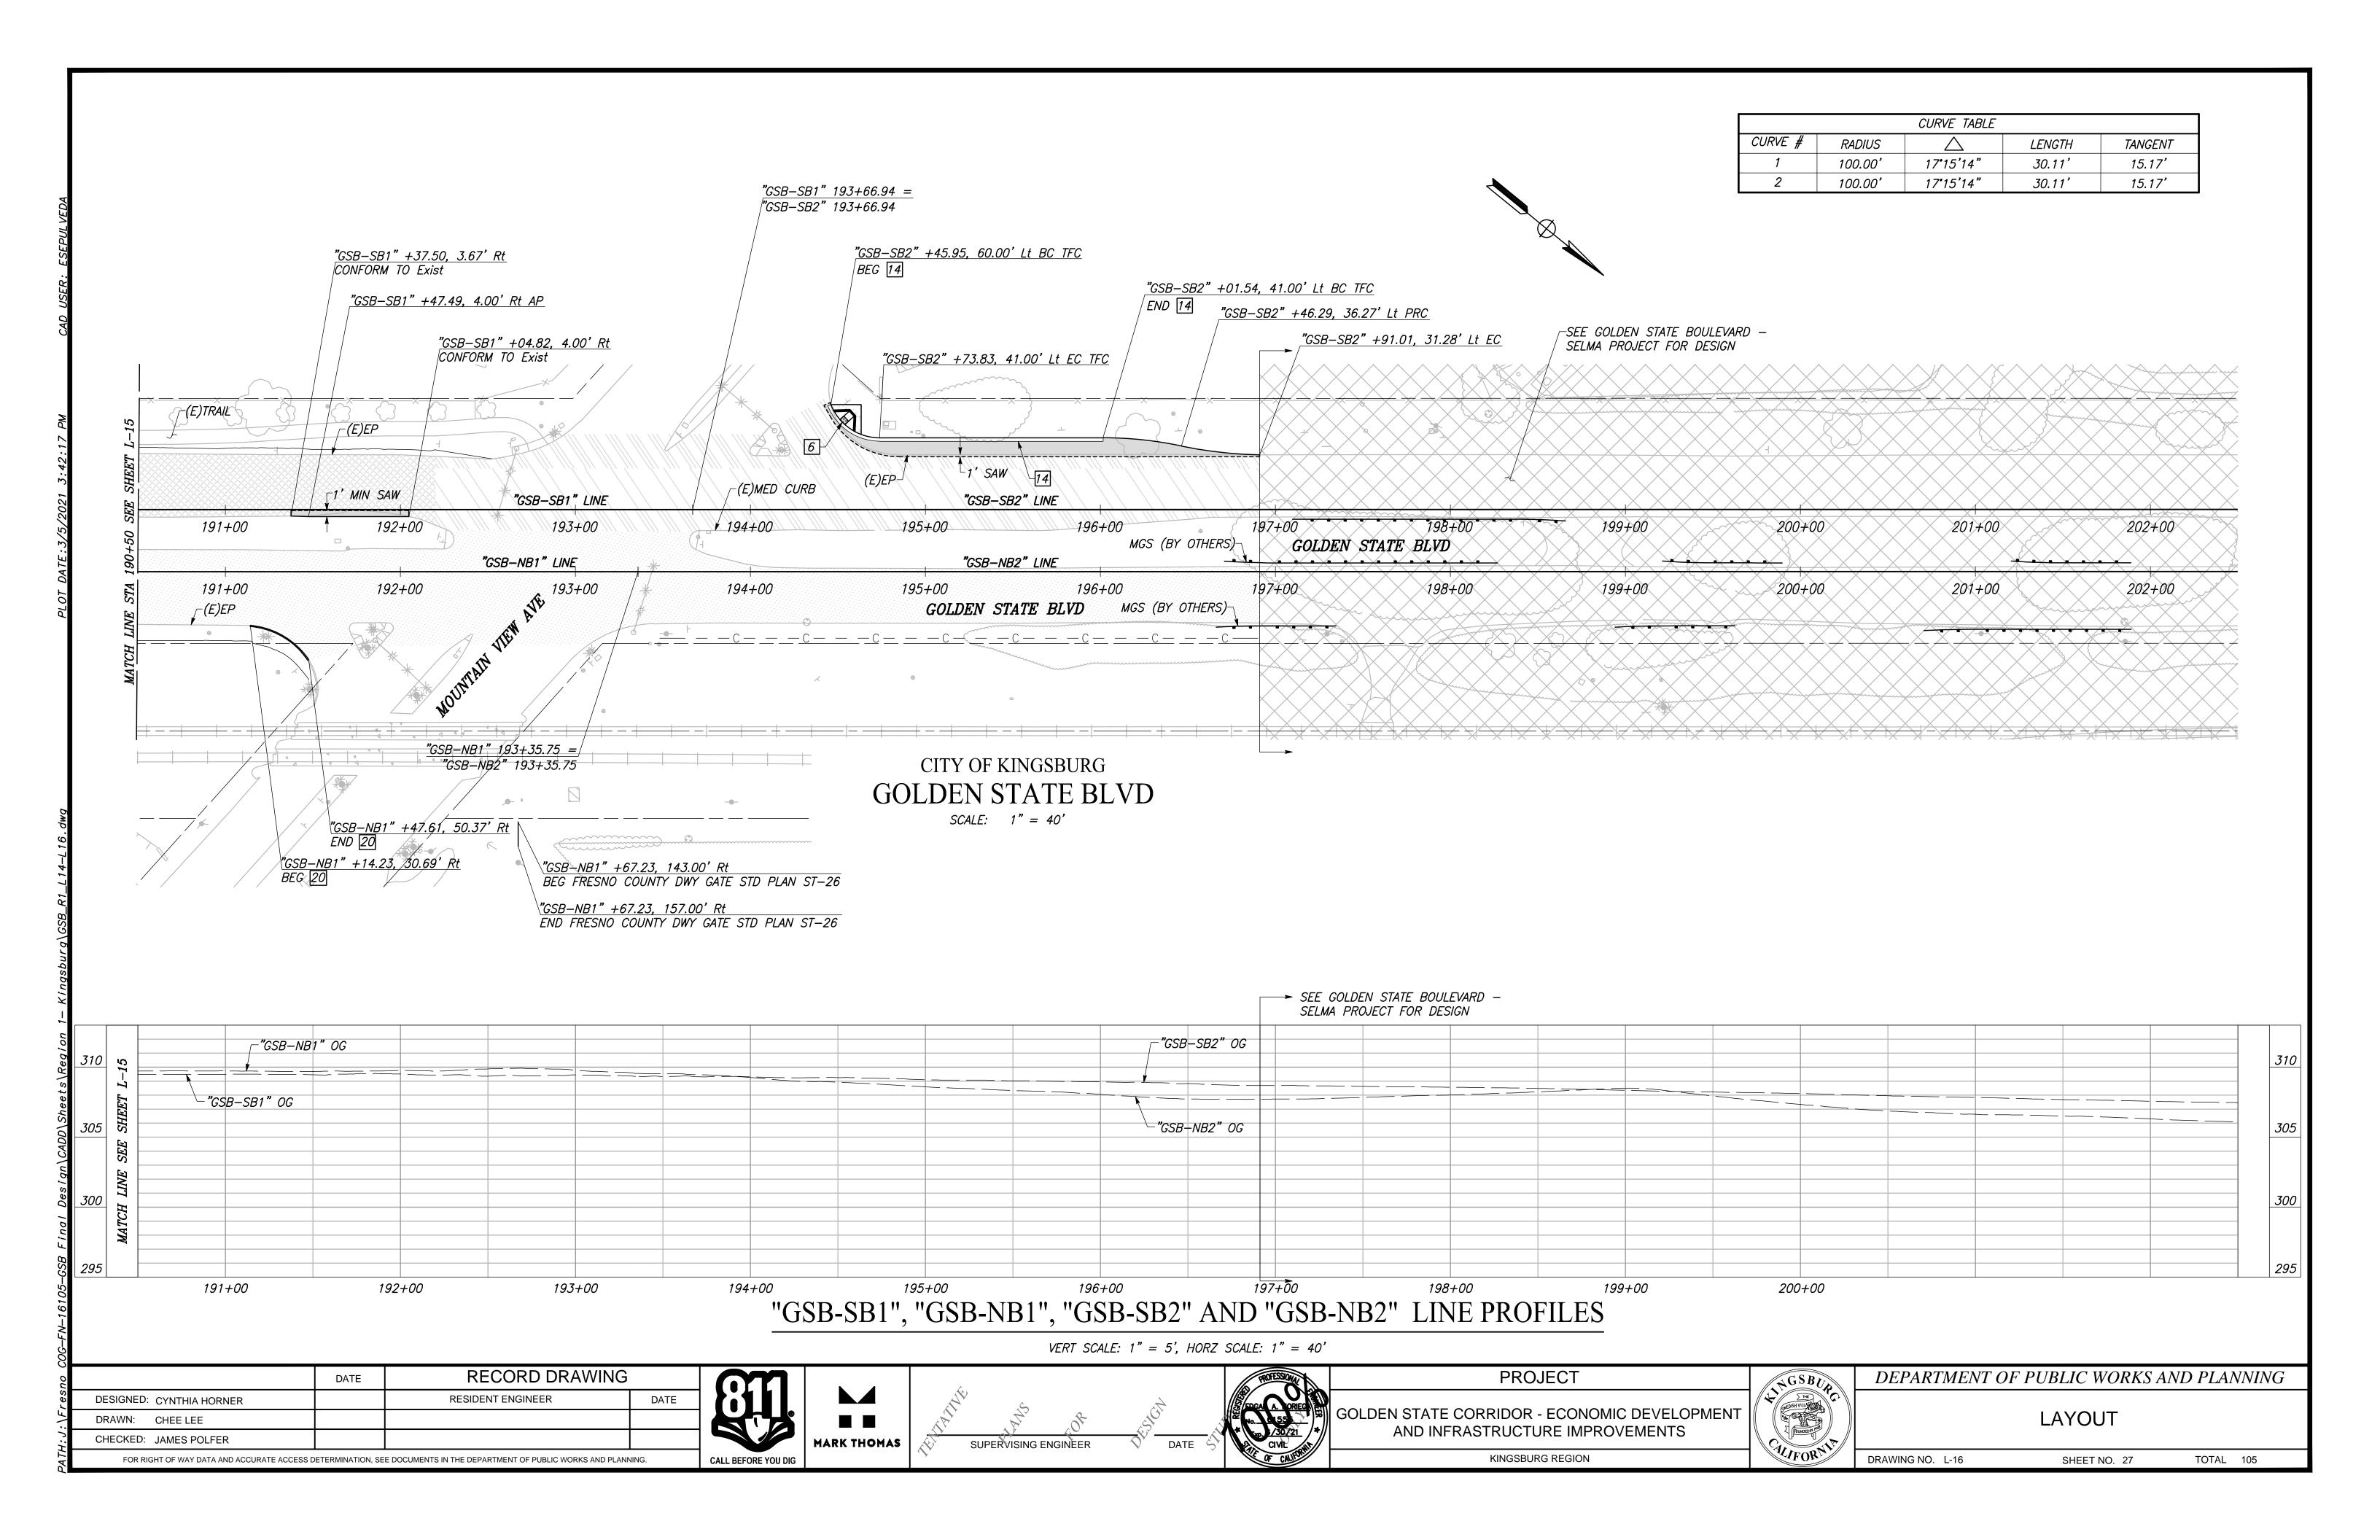


NOTES: FOR THIS SHEET ONLY


- 1) CROSSING DOT# 750618G RR SUBDIVISION: FRESNO
- 2) "L" DENOTES THE DISTANCE FROM THE EXISTING OR PROPOSED RAILROAD WARNING DEVICE TO FACE OF THE CURB.
- 3) "W DENOTES THE DISTANCE FROM THE EXISTING OR PROPOSED RAILROAD WARNING TO CENTERLINE OF TRACK.
- 4) THE CONTRACTOR TO INSTALL TRUNCATED


 DOMES 2' MIN FROM CENTER OF RAILROAD

 WARNING DEVICE OR 12' FROM NEAREST

 RAII
- 5) TERMINATED PROPOSED DIKE 10' FROM CENTERLINE OF TRACKS.
- 6) RAISED MEDIAN SHALL TERMINATE 10' FROM CENTERLINE OF TRACKS.
- 7) GRADE CROSSING PANELS TO EXTEND 3' BEYOND EDGE OF TRAVEL WAY.

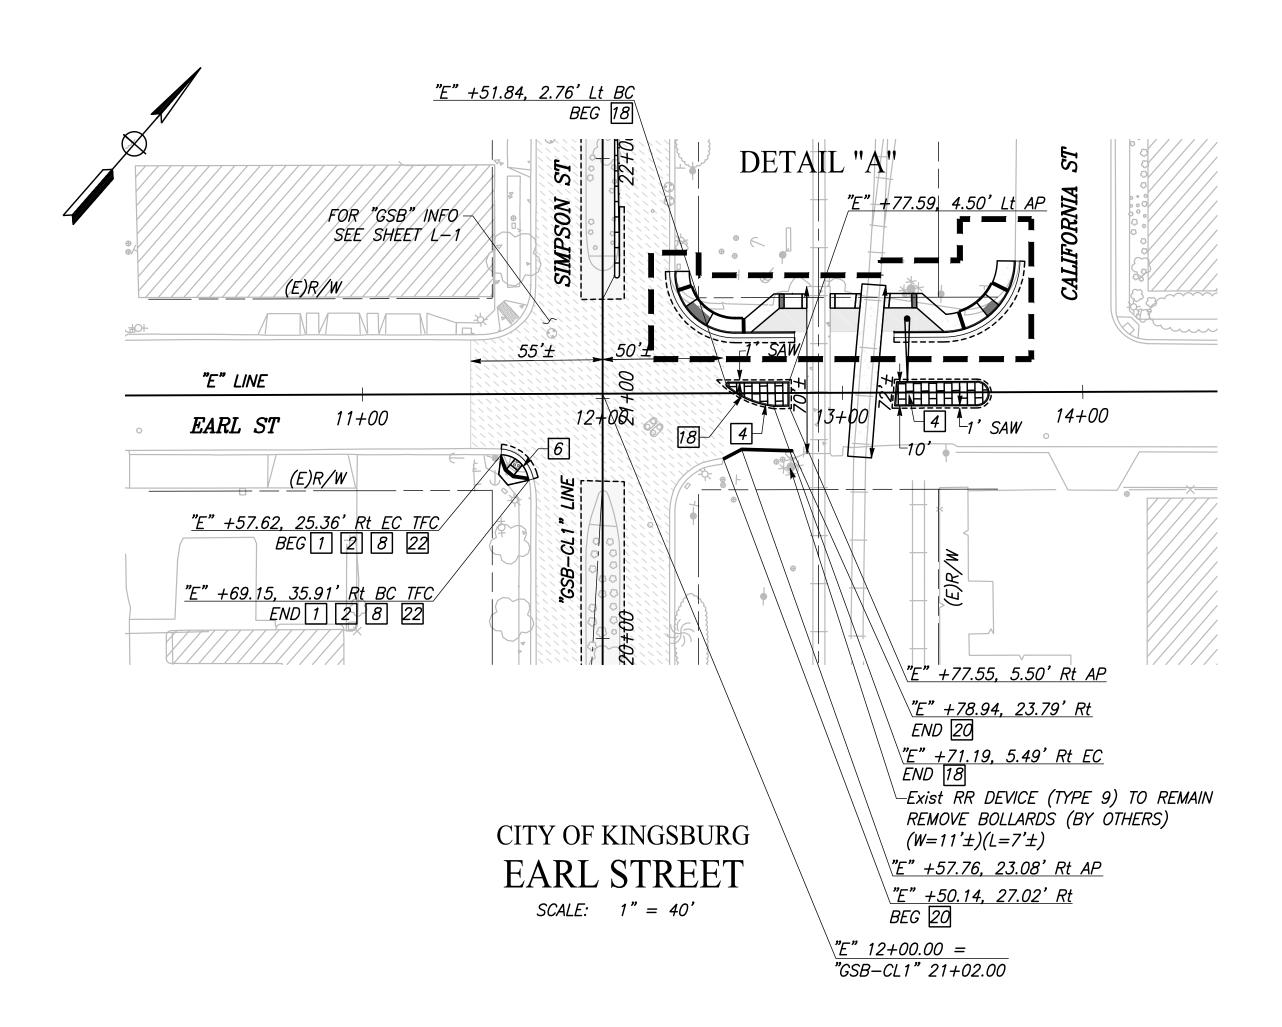

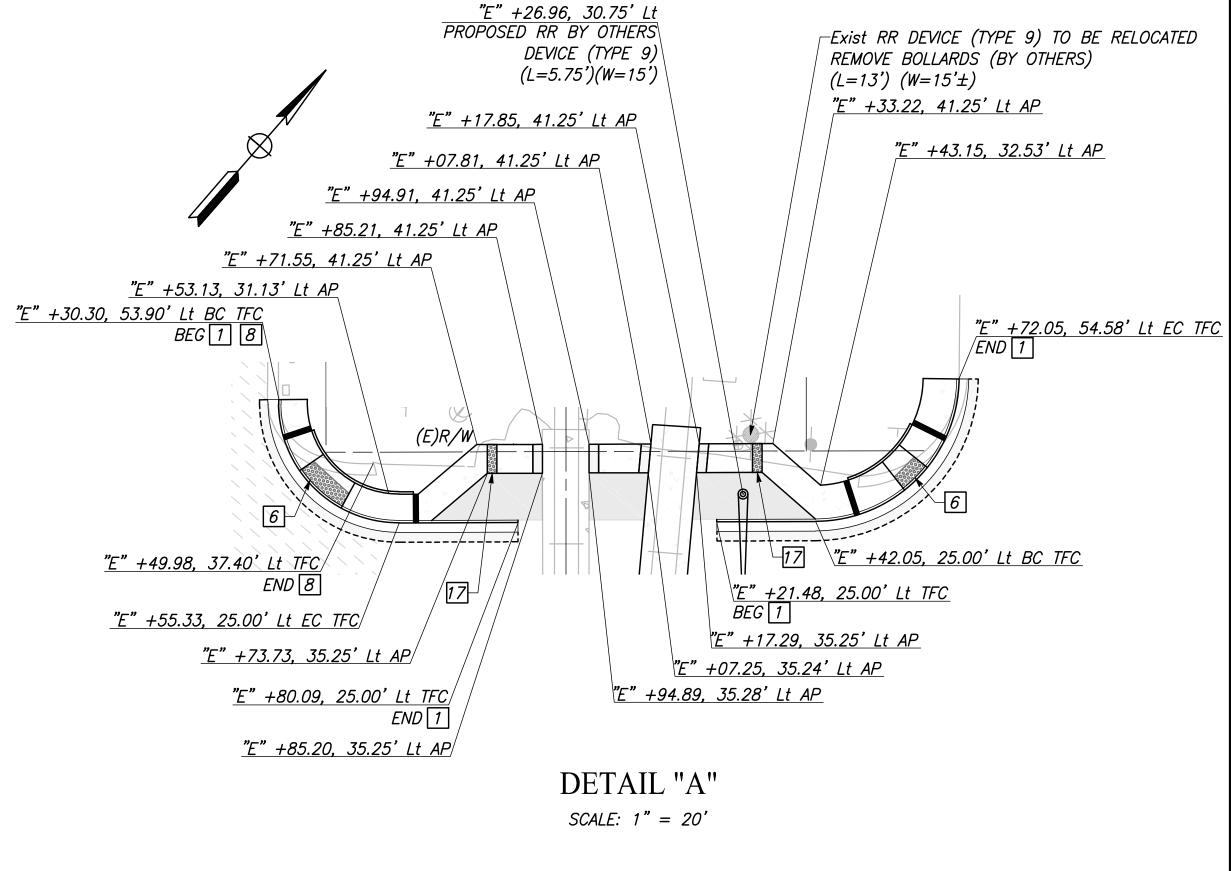

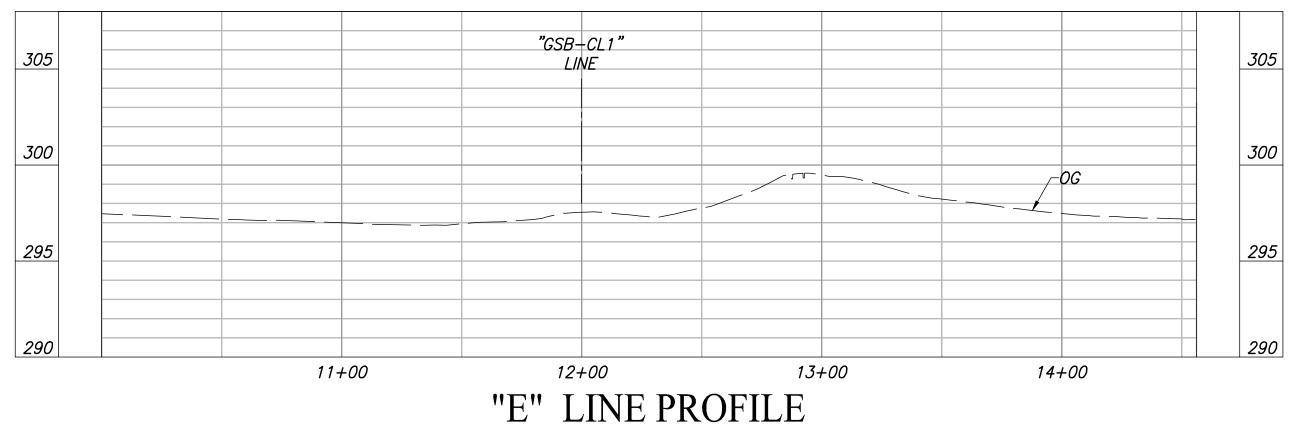

VERT SCALE: 1" = 5', HORZ SCALE: 1" = 40'

DATE RECORD DRAWING

DESIGNED: CYNTHIA HORNER RESIDENT ENGINEER DATE


DRAWN: CHEE LEE

FOR RIGHT OF WAY DATA AND ACCURATE ACCESS DETERMINATION, SEE DOCUMENTS IN THE DEPARTMENT OF PUBLIC WORKS AND PLANNING

CHECKED: JAMES POLFER

CALL BEFORE YOU DIG

MARK THOMAS

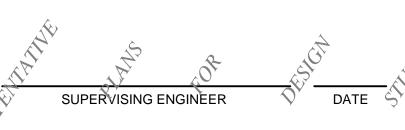



GOLDEN STATE CORRIDOR - ECONOMIC DEVELOPMENT
AND INFRASTRUCTURE IMPROVEMENTS

KINGSBURG REGION

PROJECT




DEPARTMENT OF PUBLIC WORKS AND PLANNING


LAYOUT

DRAWING NO. L-17 SHEET NO. 28 TOTAL 105




- 1) CROSSING DOT# 750630N RR SUBDIVISION: FRESNO
- 2) "L" DENOTES THE DISTANCE FROM THE EXISTING OR PROPOSED RAILROAD WARNING DEVICE TO FACE OF THE CURB.
- 3) "W DENOTES THE DISTANCE FROM THE EXISTING OR PROPOSED RAILROAD WARNING TO CENTERLINE OF TRACK.
- 4) THE PROPOSED TRUNCATED DOME ARE OFFSET 2' FROM THE RR DEVICE AND 12' FROM THE CENTER LINE OF THE TRACK.
- 5) RAISED MEDIAN SHALL TERMINATE 10' FROM CENTERLINE OF TRACKS.
- 6) GRADE CROSSING PANELS TO EXTEND 3' BEYOND EDGE OF TRAVEL WAY.

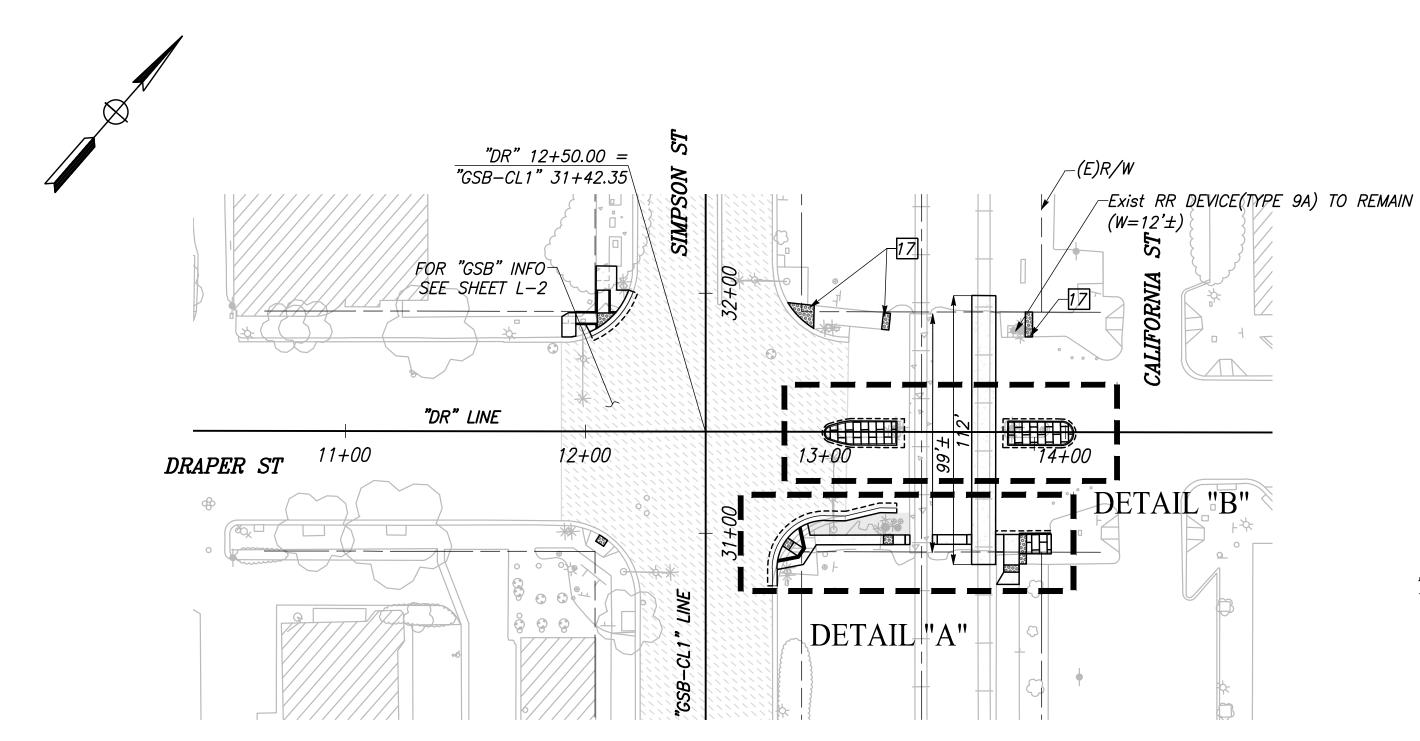


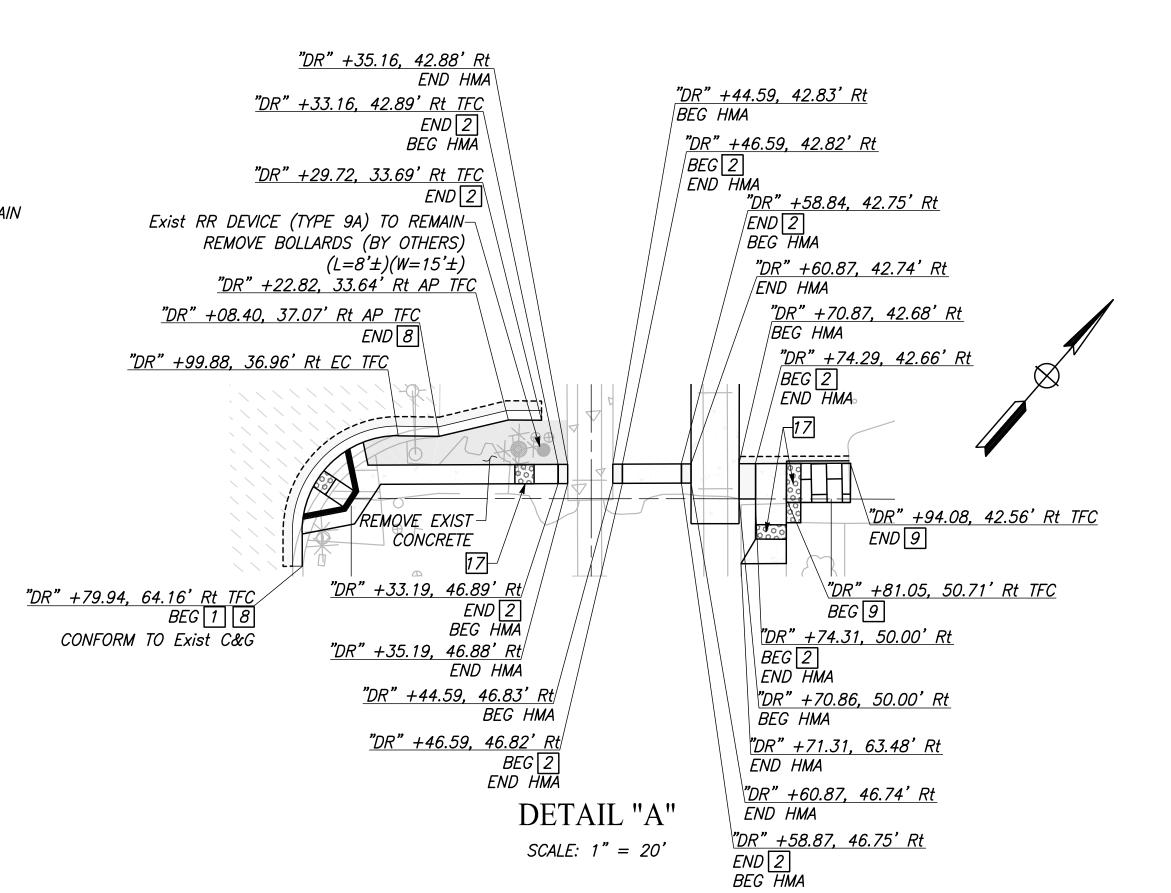

CITY OF KINGSBURG DRAPER STREET SCALE: 1" = 40'

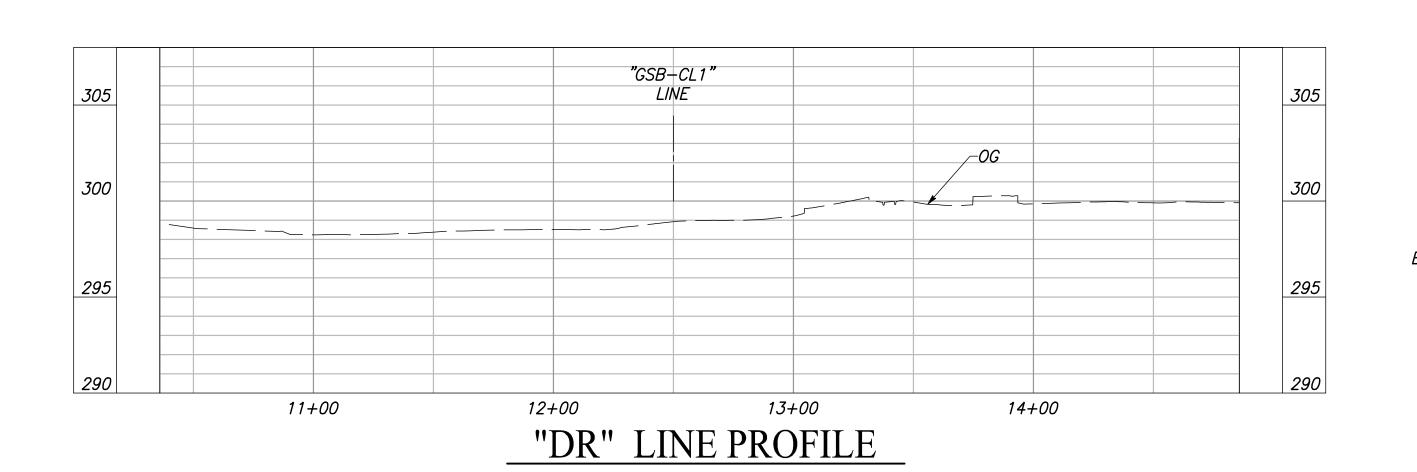

VERT SCALE: 1" = 5', HORZ SCALE: 1" = 40'

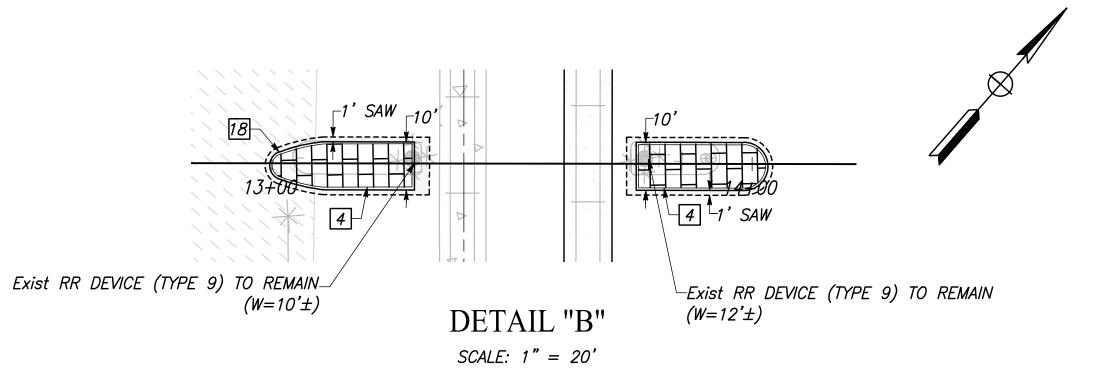

DATE RECORD DRAWING

DESIGNED: CYNTHIA HORNER RESIDENT ENGINEER DATE


DRAWN: DILLON ALAMEDA

CHECKED: JAMES POLFER

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CALL BEFORE YOU DIG

MARK THOMAS



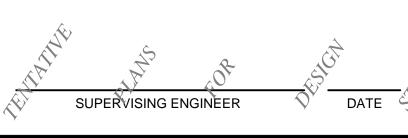

GOLDEN STATE CORRIDOR - ECONOMIC DEVELOPMENT
AND INFRASTRUCTURE IMPROVEMENTS

KINGSBURG REGION


PROJECT




DRAWING NO. L-18 SHEET NO. 29 TOTAL 105



- 1) CROSSING DOT# 750621P RR SUBDIVISION: FRESNO
- 2) "L" DENOTES THE DISTANCE FROM THE EXISTING OR PROPOSED RAILROAD WARNING DEVICE TO FACE OF THE CURB.
- 3) "W DENOTES THE DISTANCE FROM THE EXISTING OR PROPOSED RAILROAD WARNING TO CENTERLINE OF TRACK.
- 4) TERMINATED PROPOSED DIKE 10' FROM CENTERLINE OF TRACKS.
- 5) RAISED MEDIAN SHALL TERMINATE 10' FROM CENTERLINE OF TRACKS.
- 6) GRADE CROSSING PANELS TO EXTEND 3' BEYOND EDGE OF TRAVEL WAY.

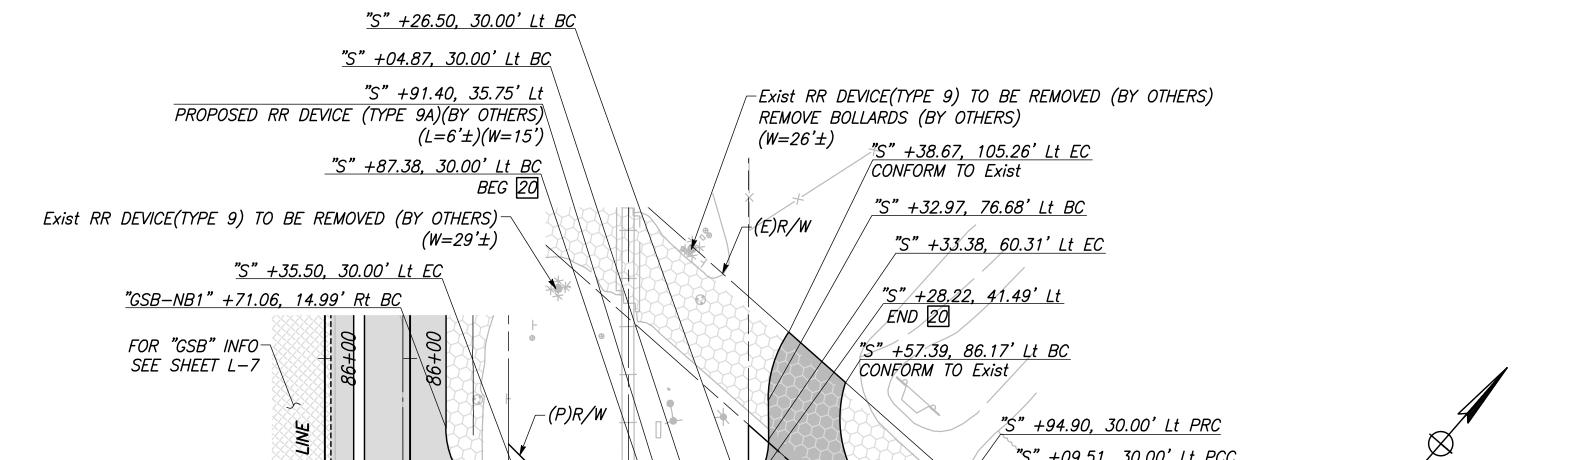

CURVE TABLE CURVE # RADIUS LENGTH *TANGENT 275.00*′ 41°27'53" 199.02 104.09 *390.00*′ *59°47'27"* 406.98 224.22'

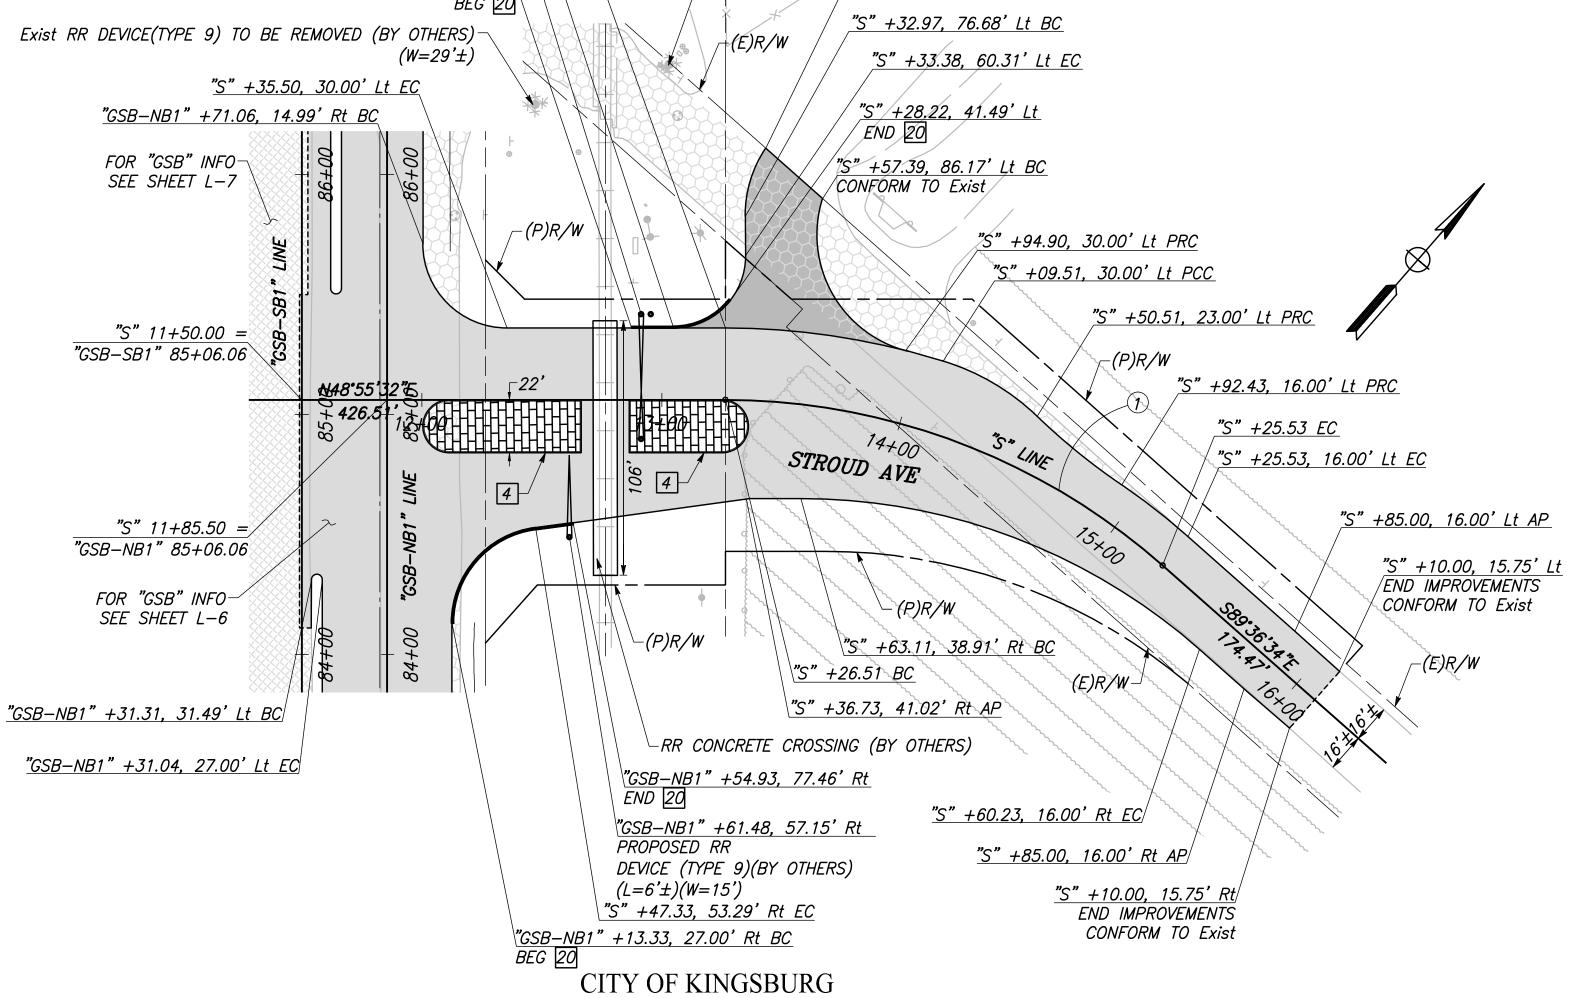

1 +68.78 20 Elev 304. 20 +84.17 Elev 304. – PG -0.71% *305* (-0.1%) "GSB-NB1" "GSB-SB1" LINE 12+00 13+00 15+00 16+00

"S" LINE PROFILE VERT SCALE: 1" = 5', HORZ SCALE: 1" = 40'


STROUD AVENUE

SCALE: 1" = 40'

	DATE	RECORD DRAWING	
DESIGNED: CYNTHIA HORNER		RESIDENT ENGINEER	DATE
DRAWN: CHEE LEE			
CHECKED: JAMES POLFER			

FOR RIGHT OF WAY DATA AND ACCURATE ACCESS DETERMINATION, SEE DOCUMENTS IN THE DEPARTMENT OF PUBLIC WORKS AND PLANNING.

MARK THOMAS

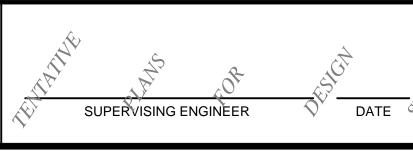



GOLDEN STATE CORRIDOR - ECONOMIC DEVELOPMENT AND INFRASTRUCTURE IMPROVEMENTS KINGSBURG REGION


PROJECT





DEPARTMENT OF PUBLIC WORKS AND PLANNING


LAYOUT


DRAWING NO. L-19 SHEET NO. 30 TOTAL 105

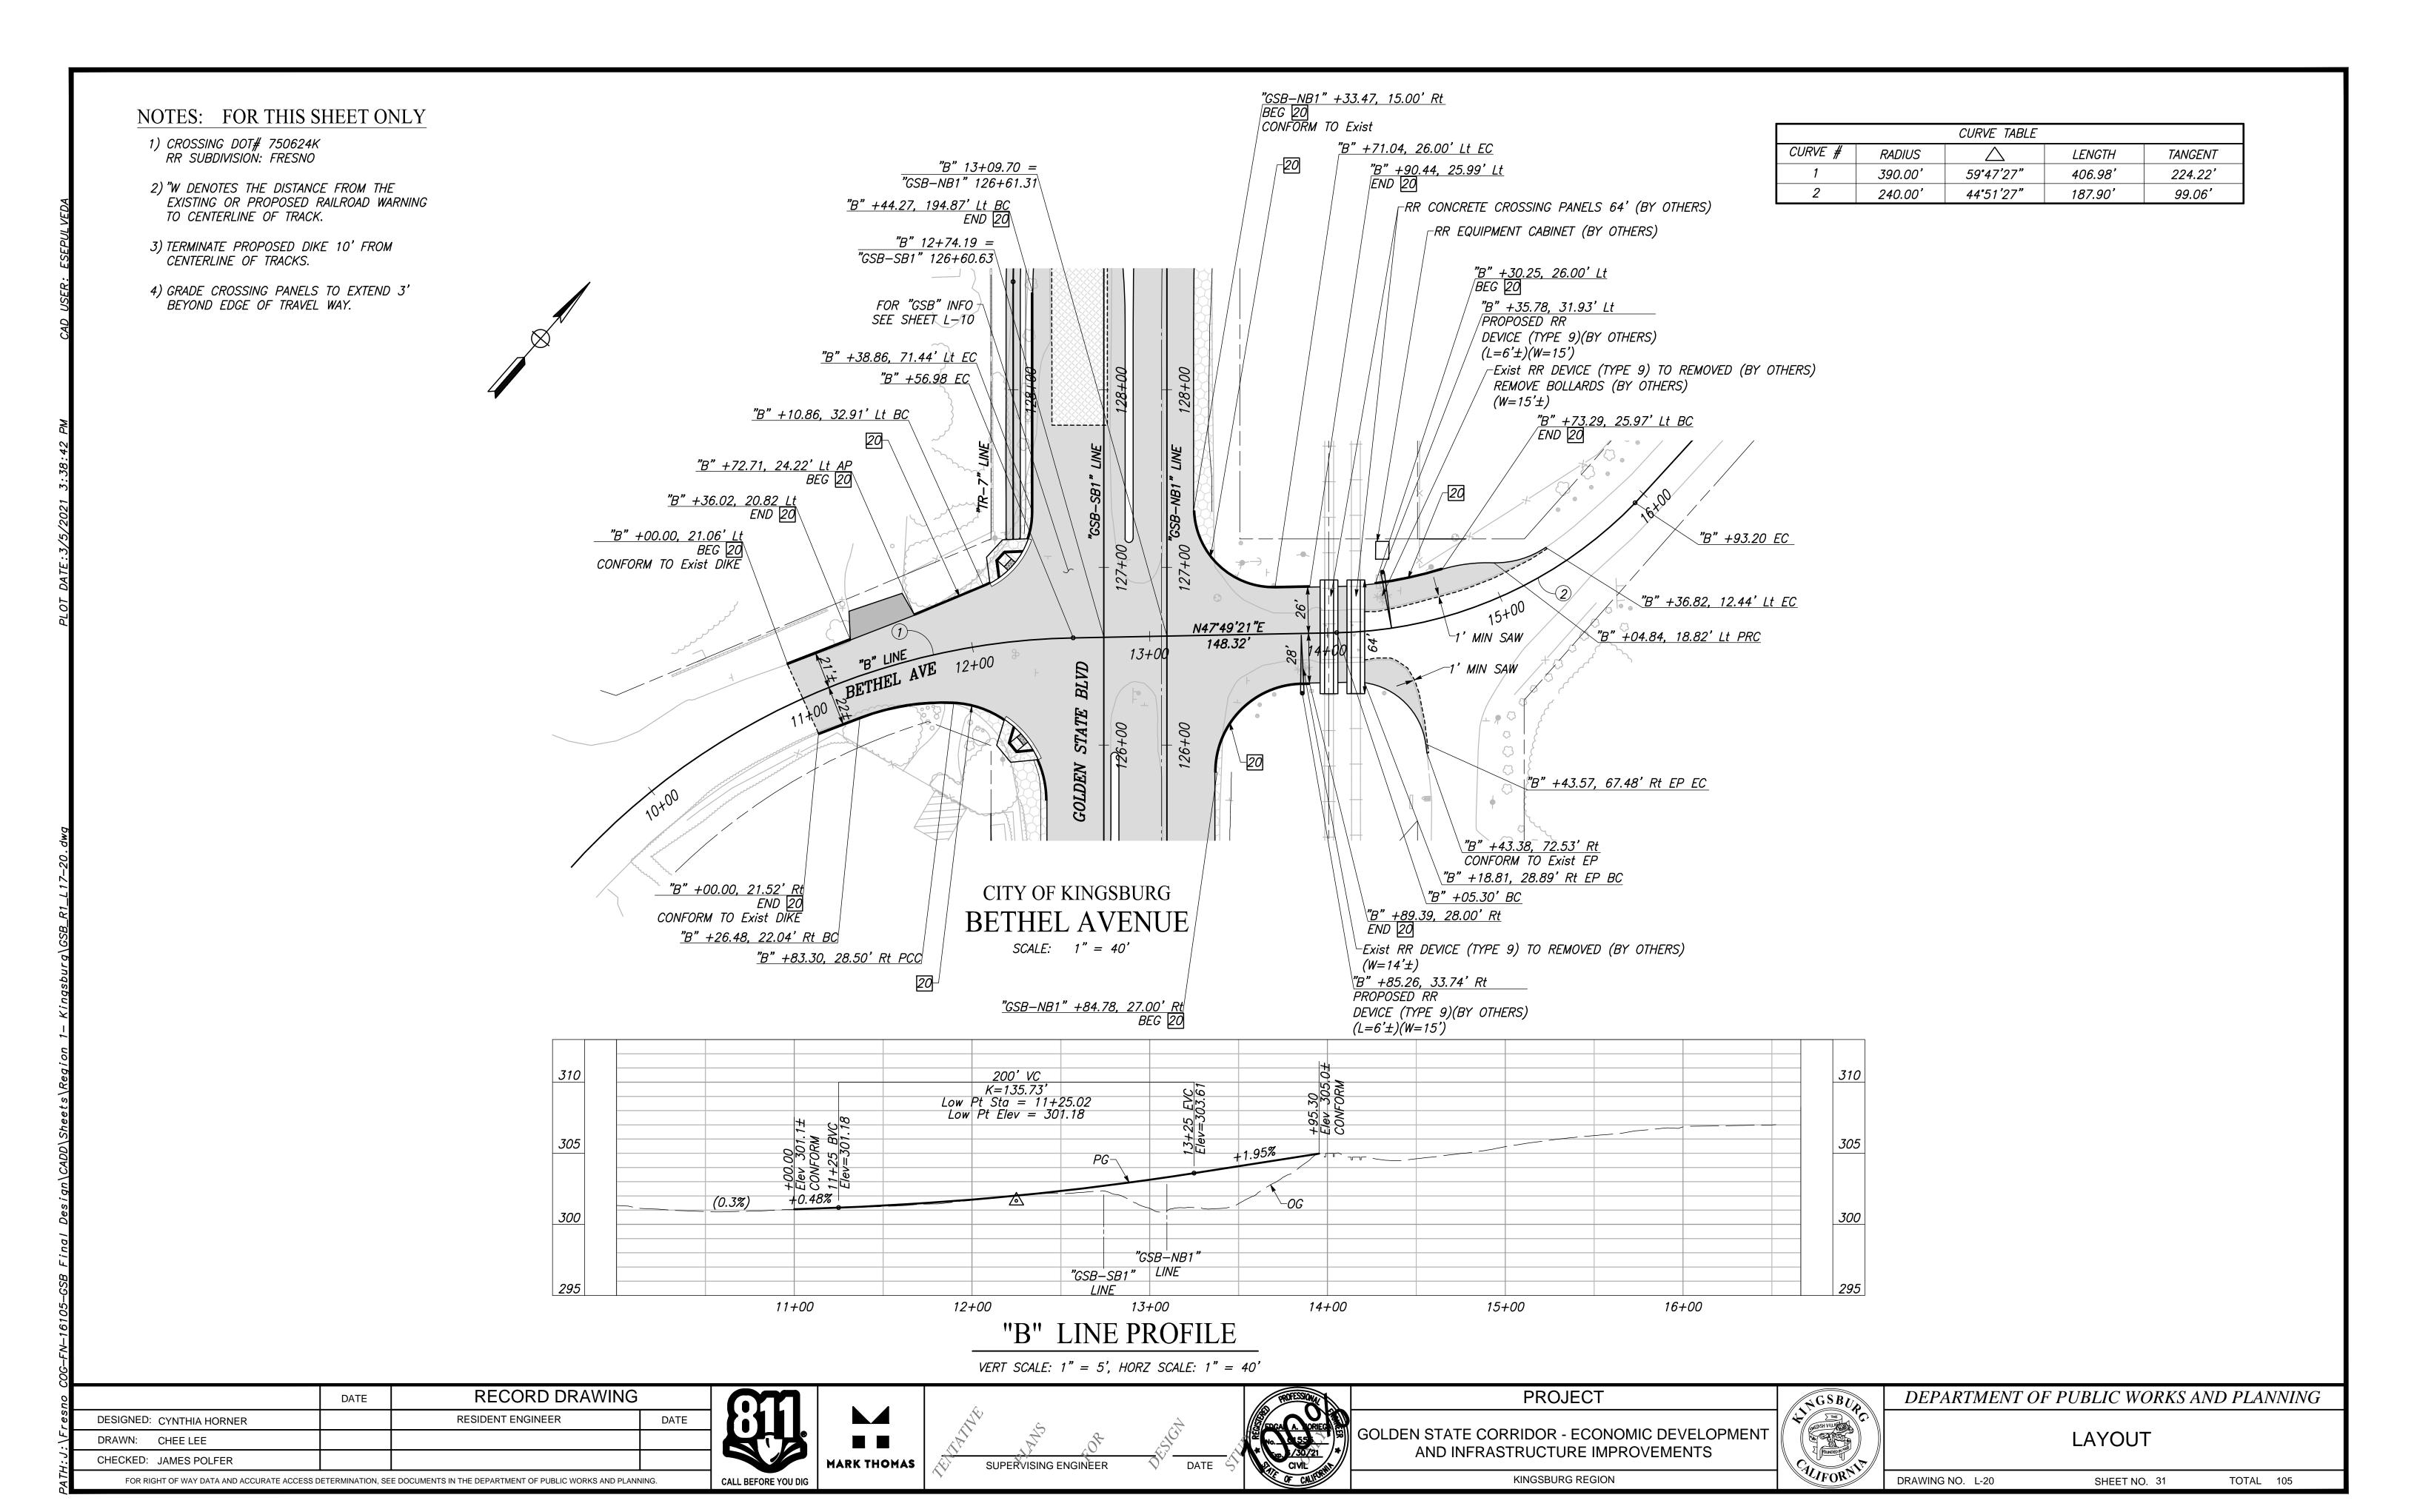


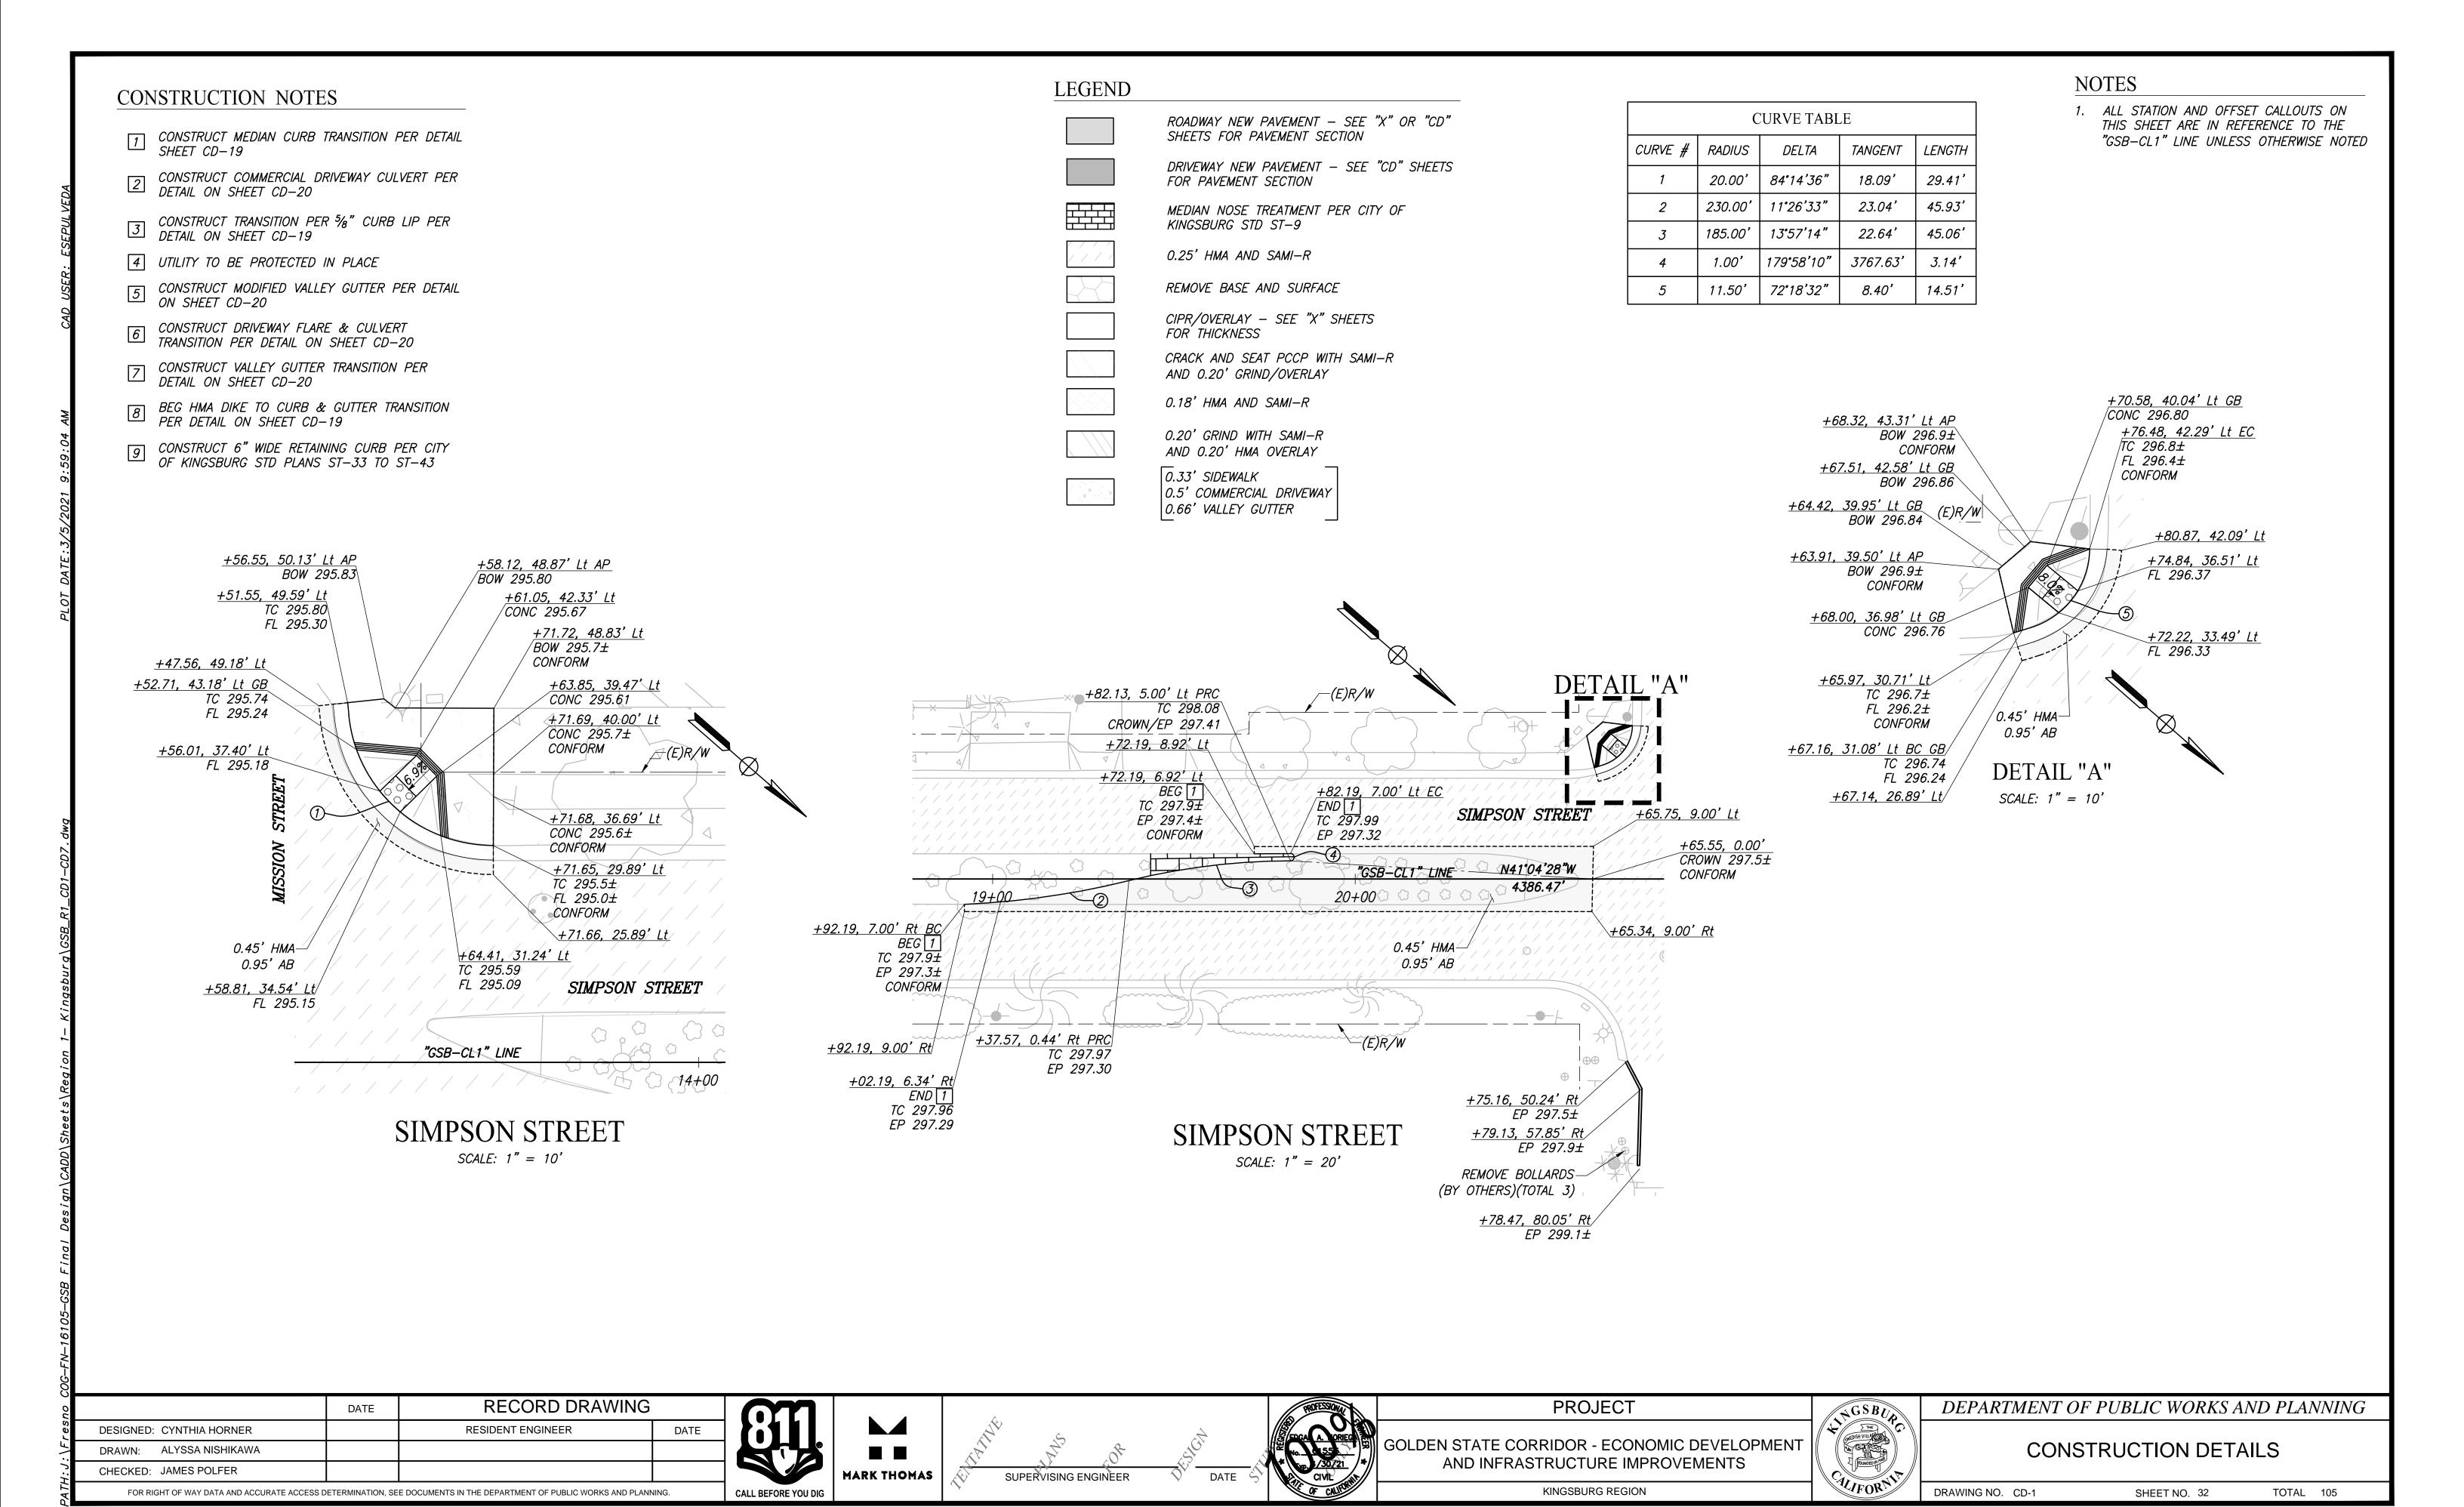


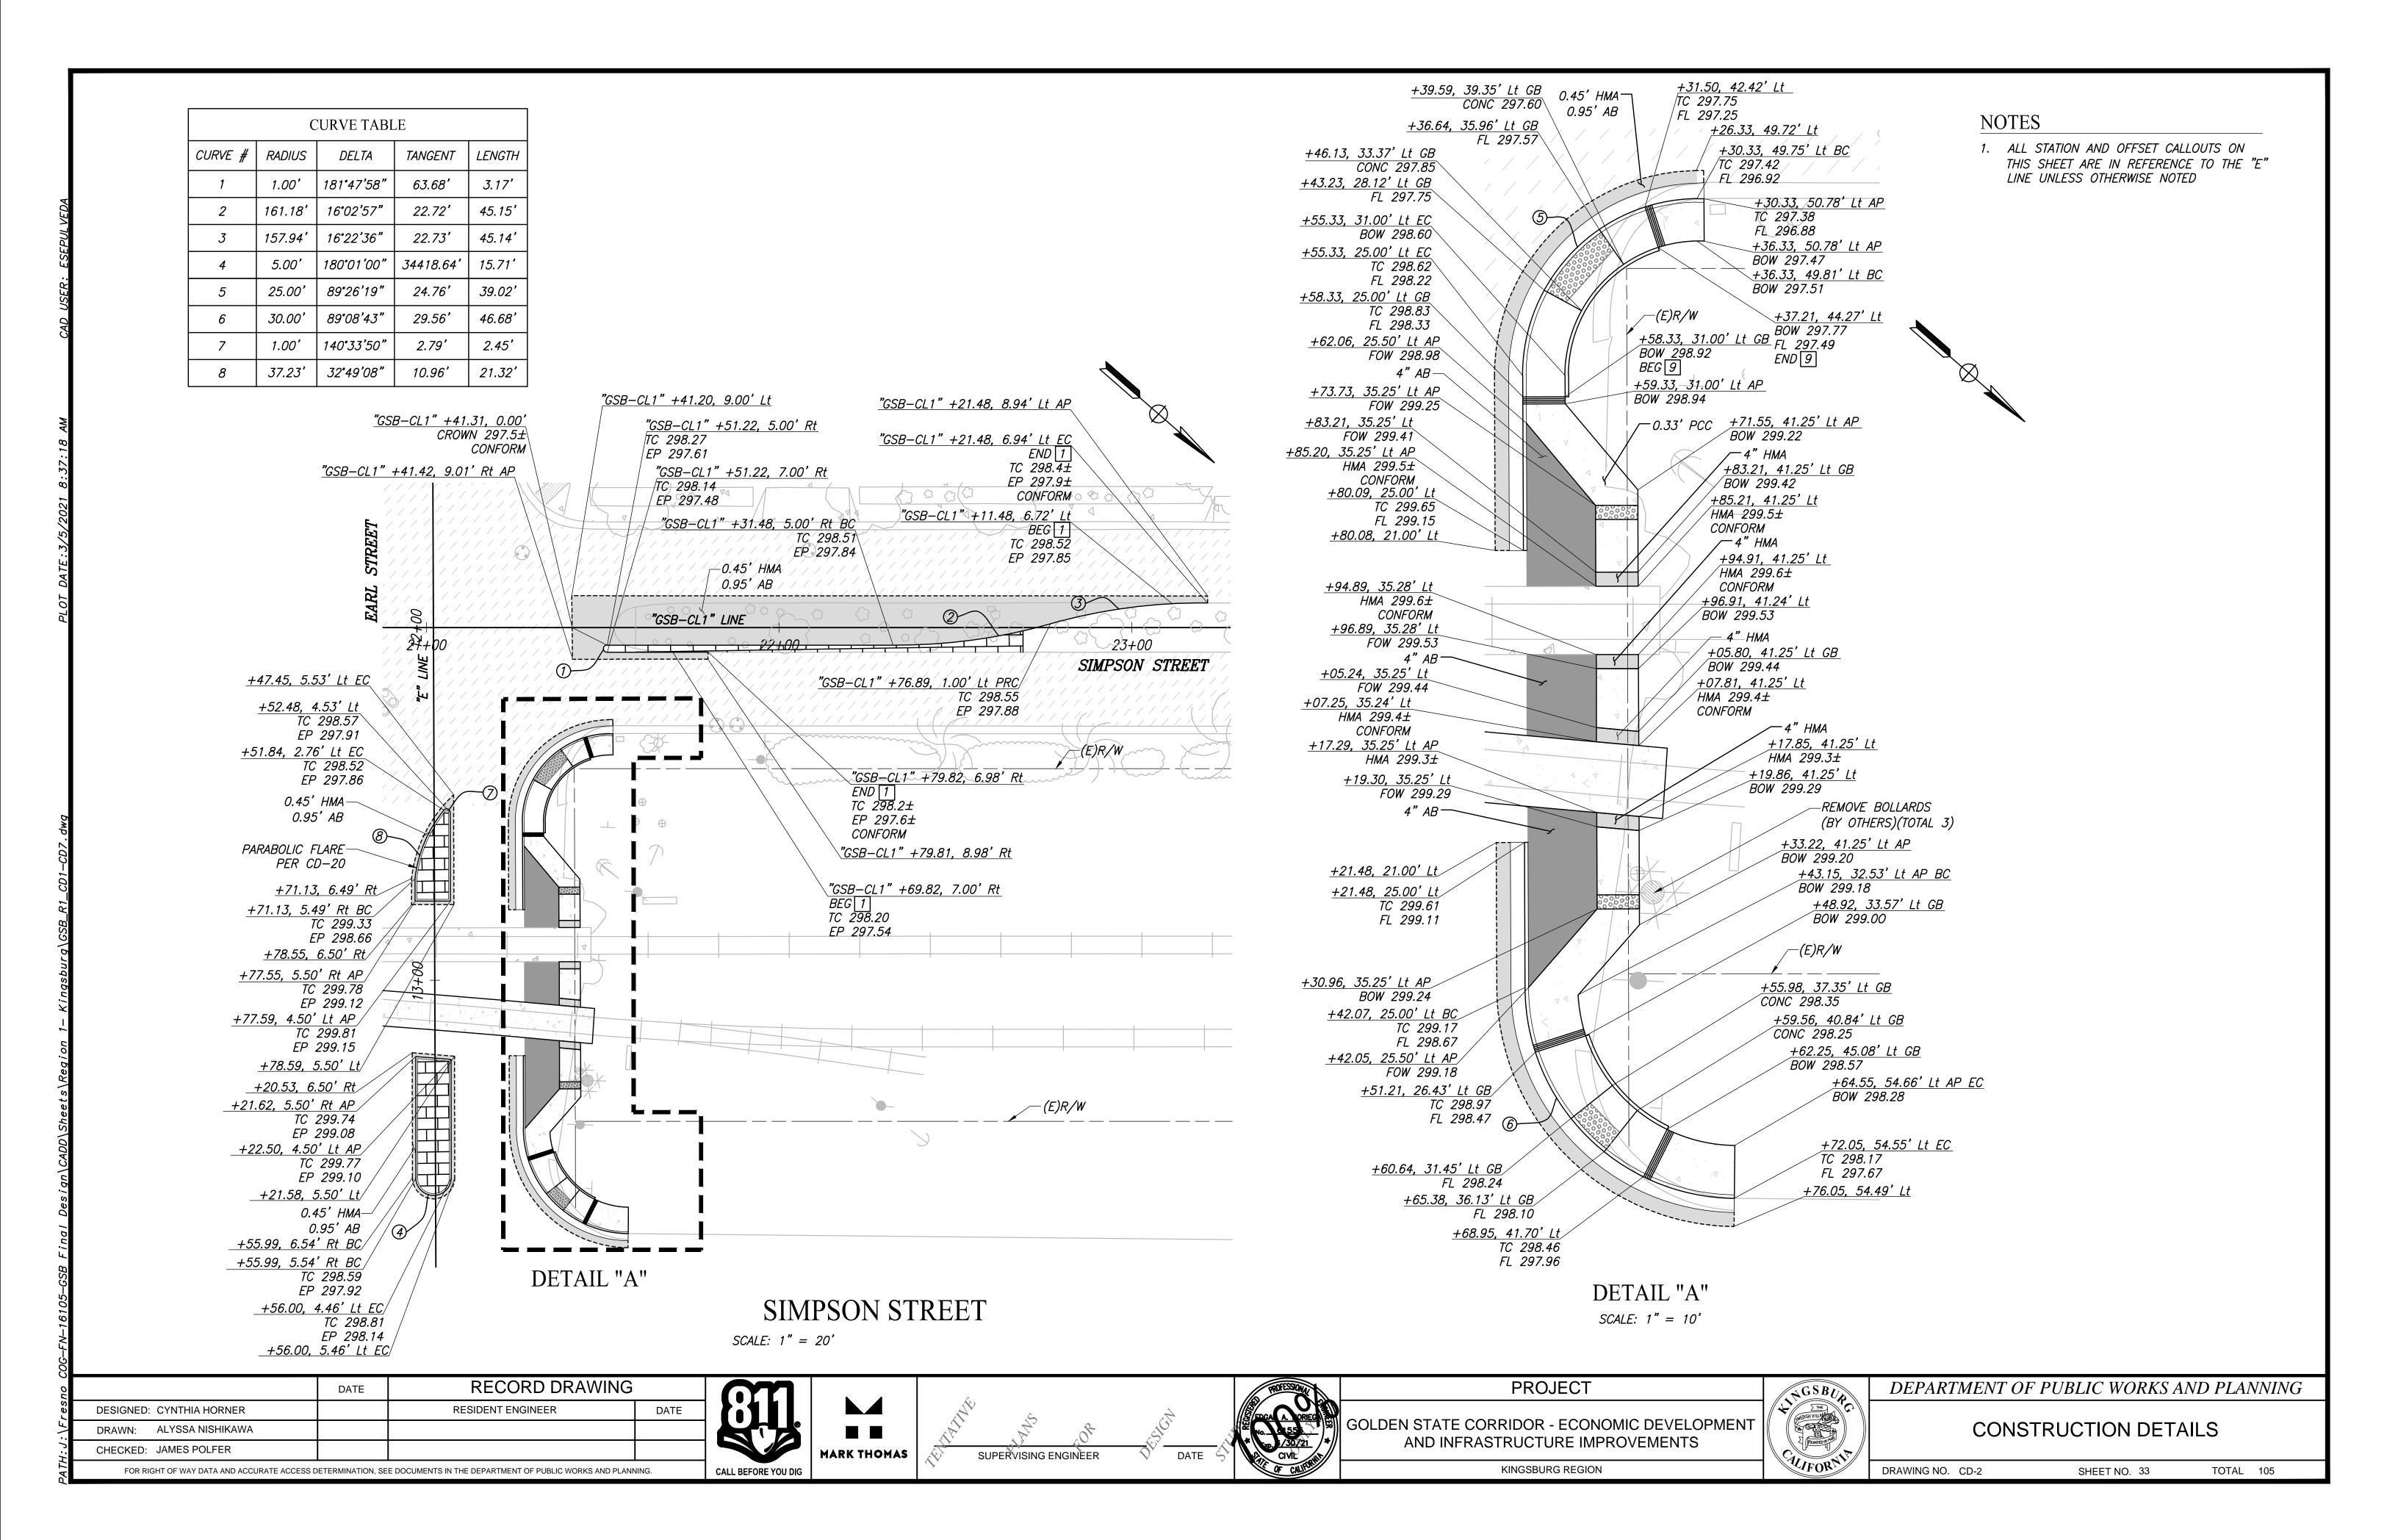


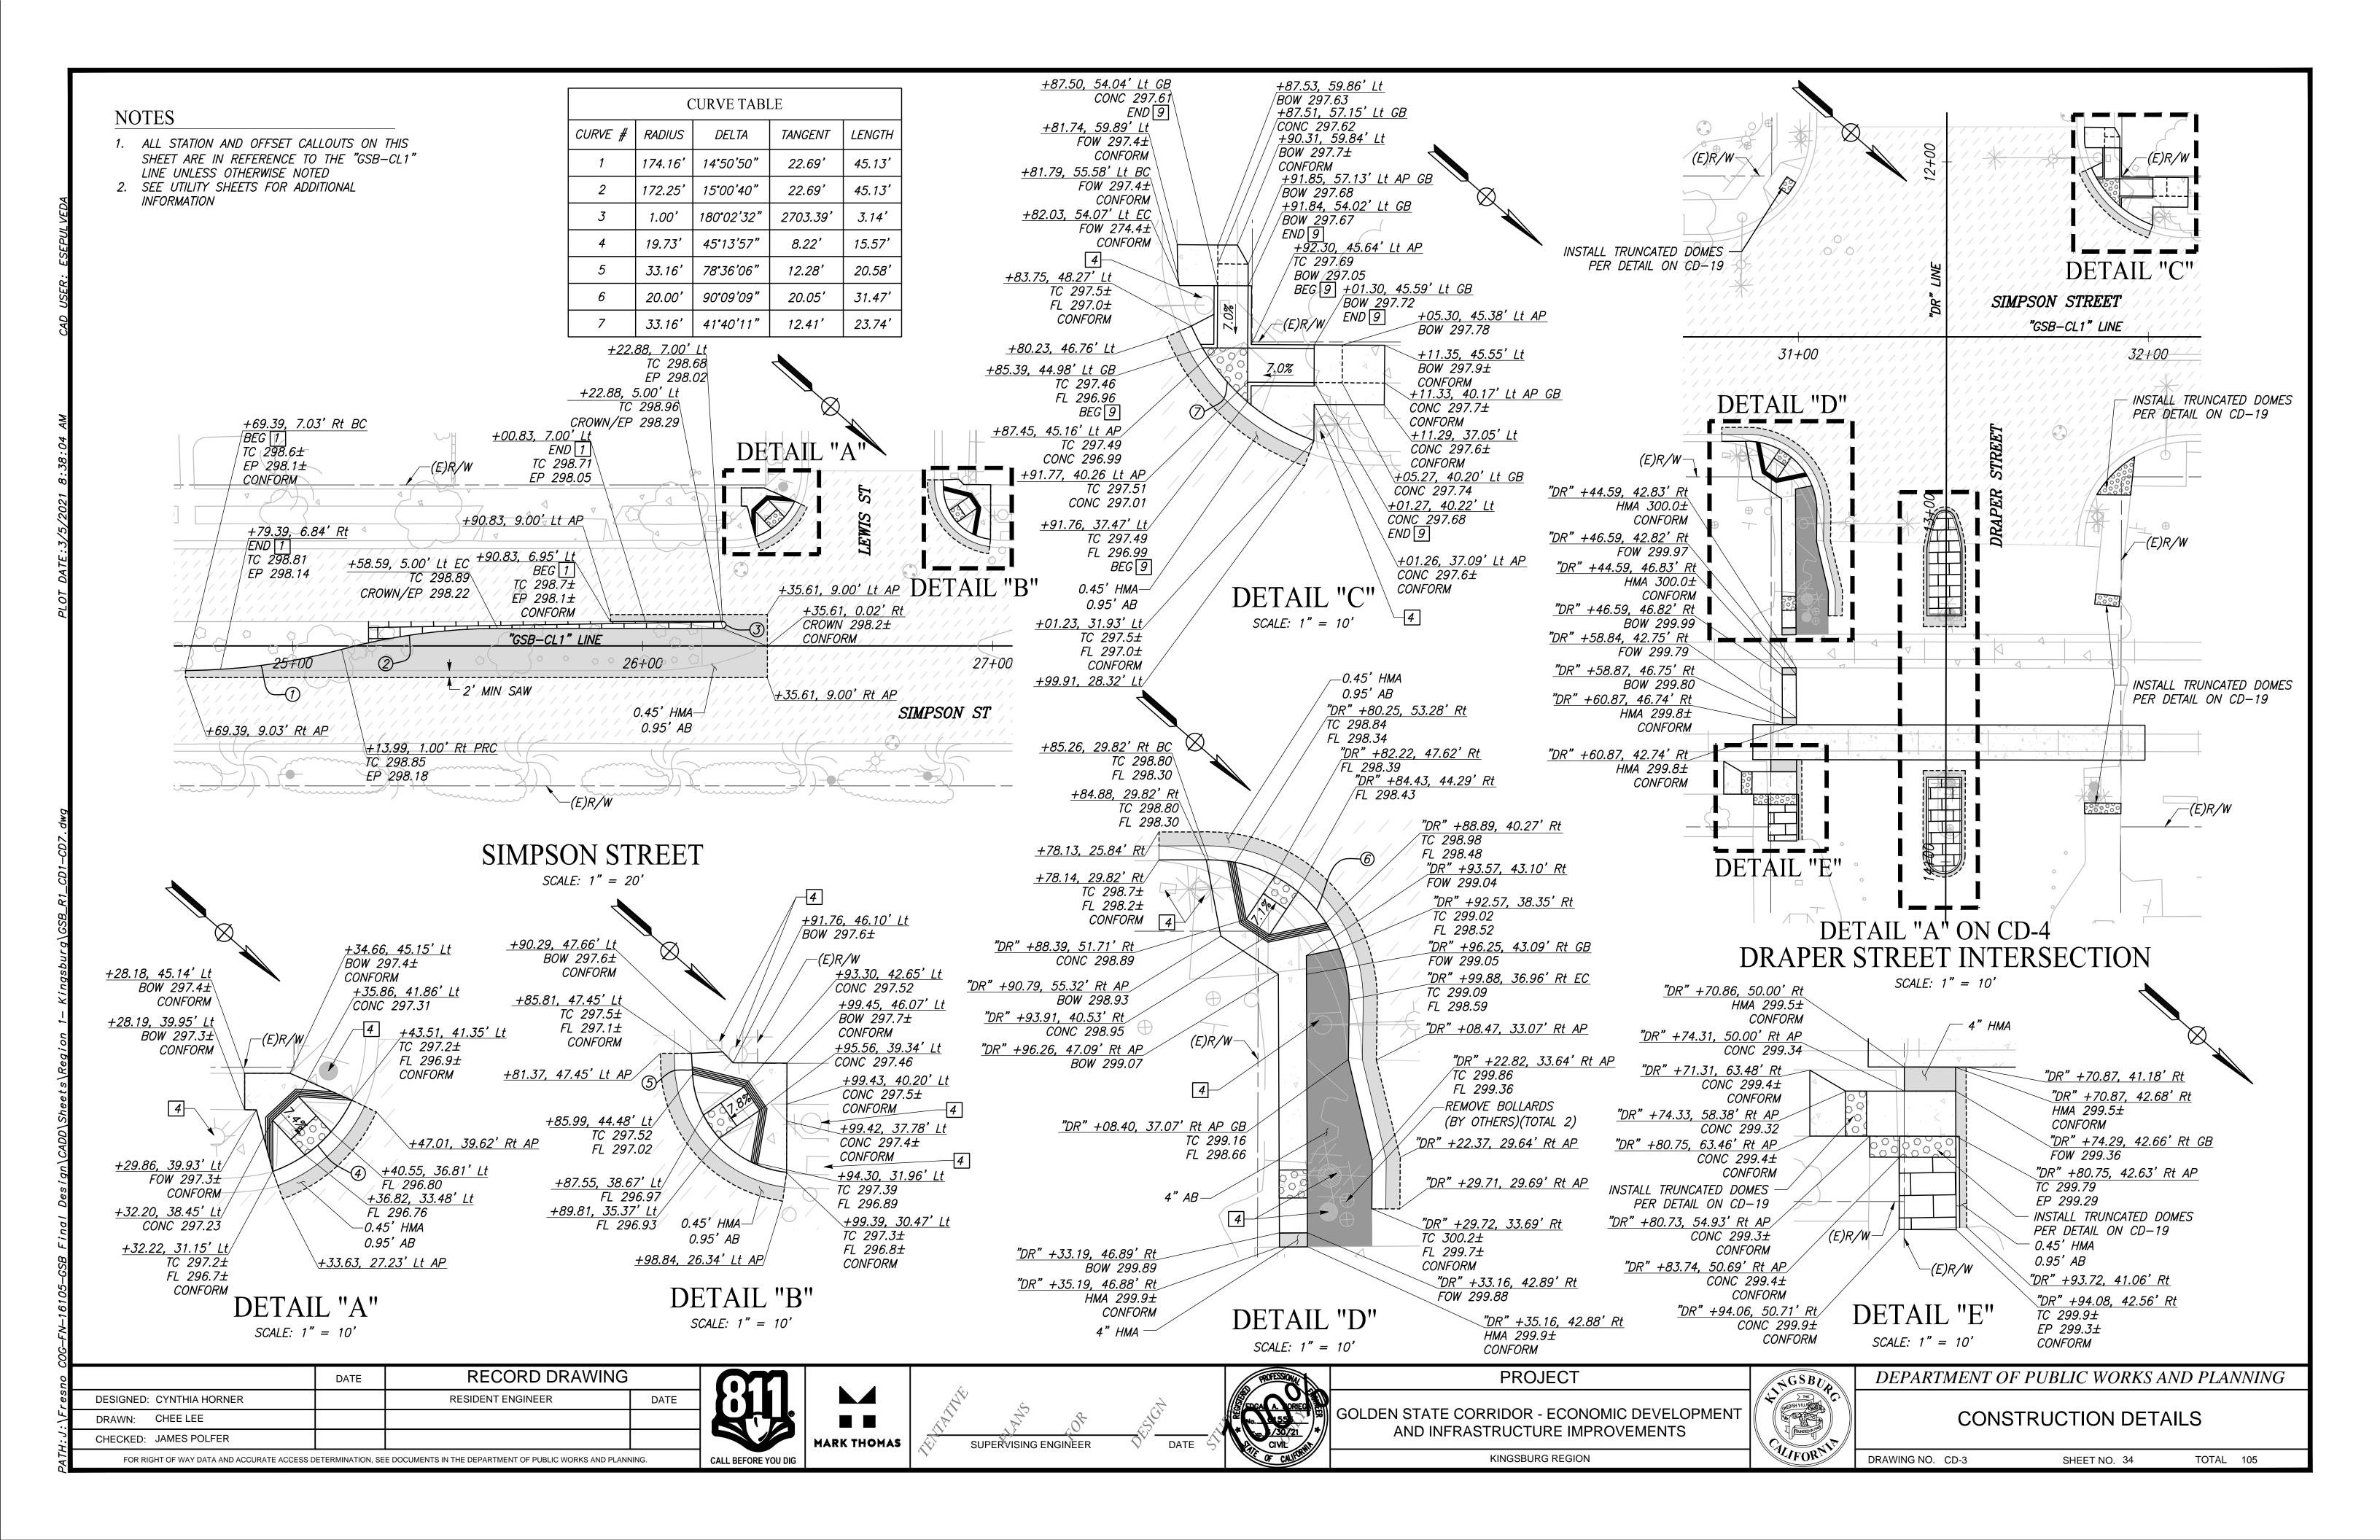


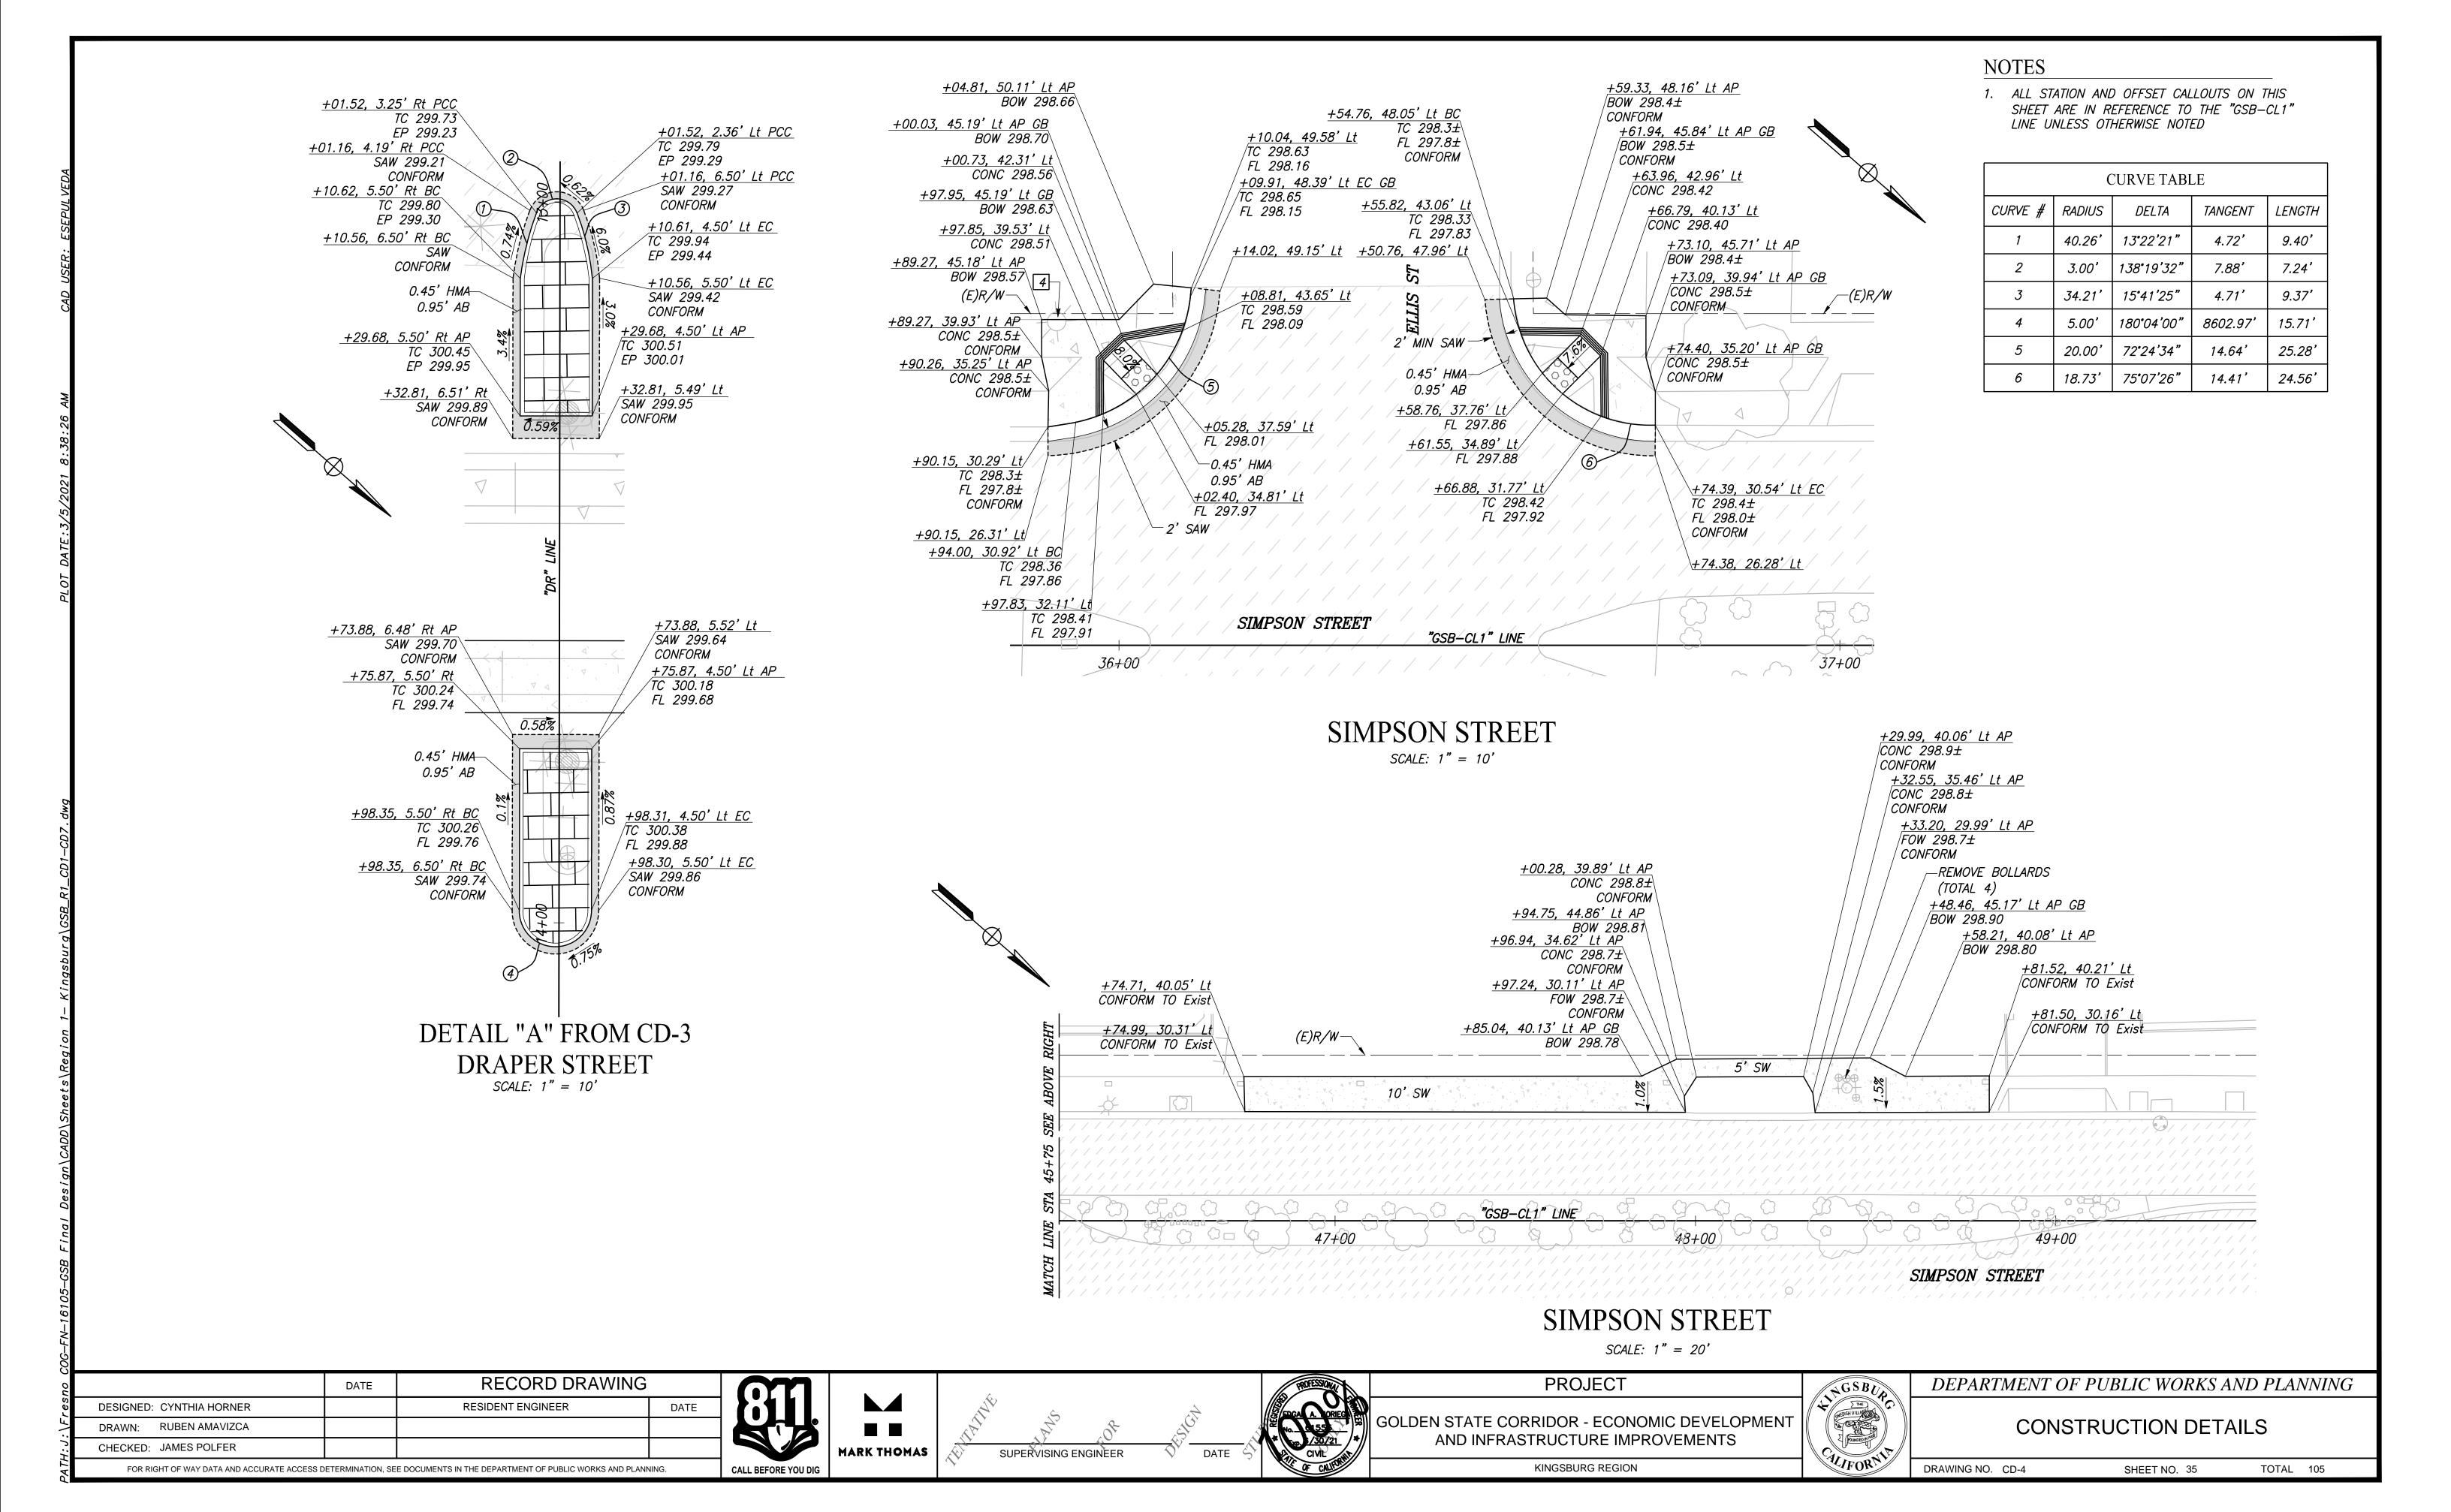


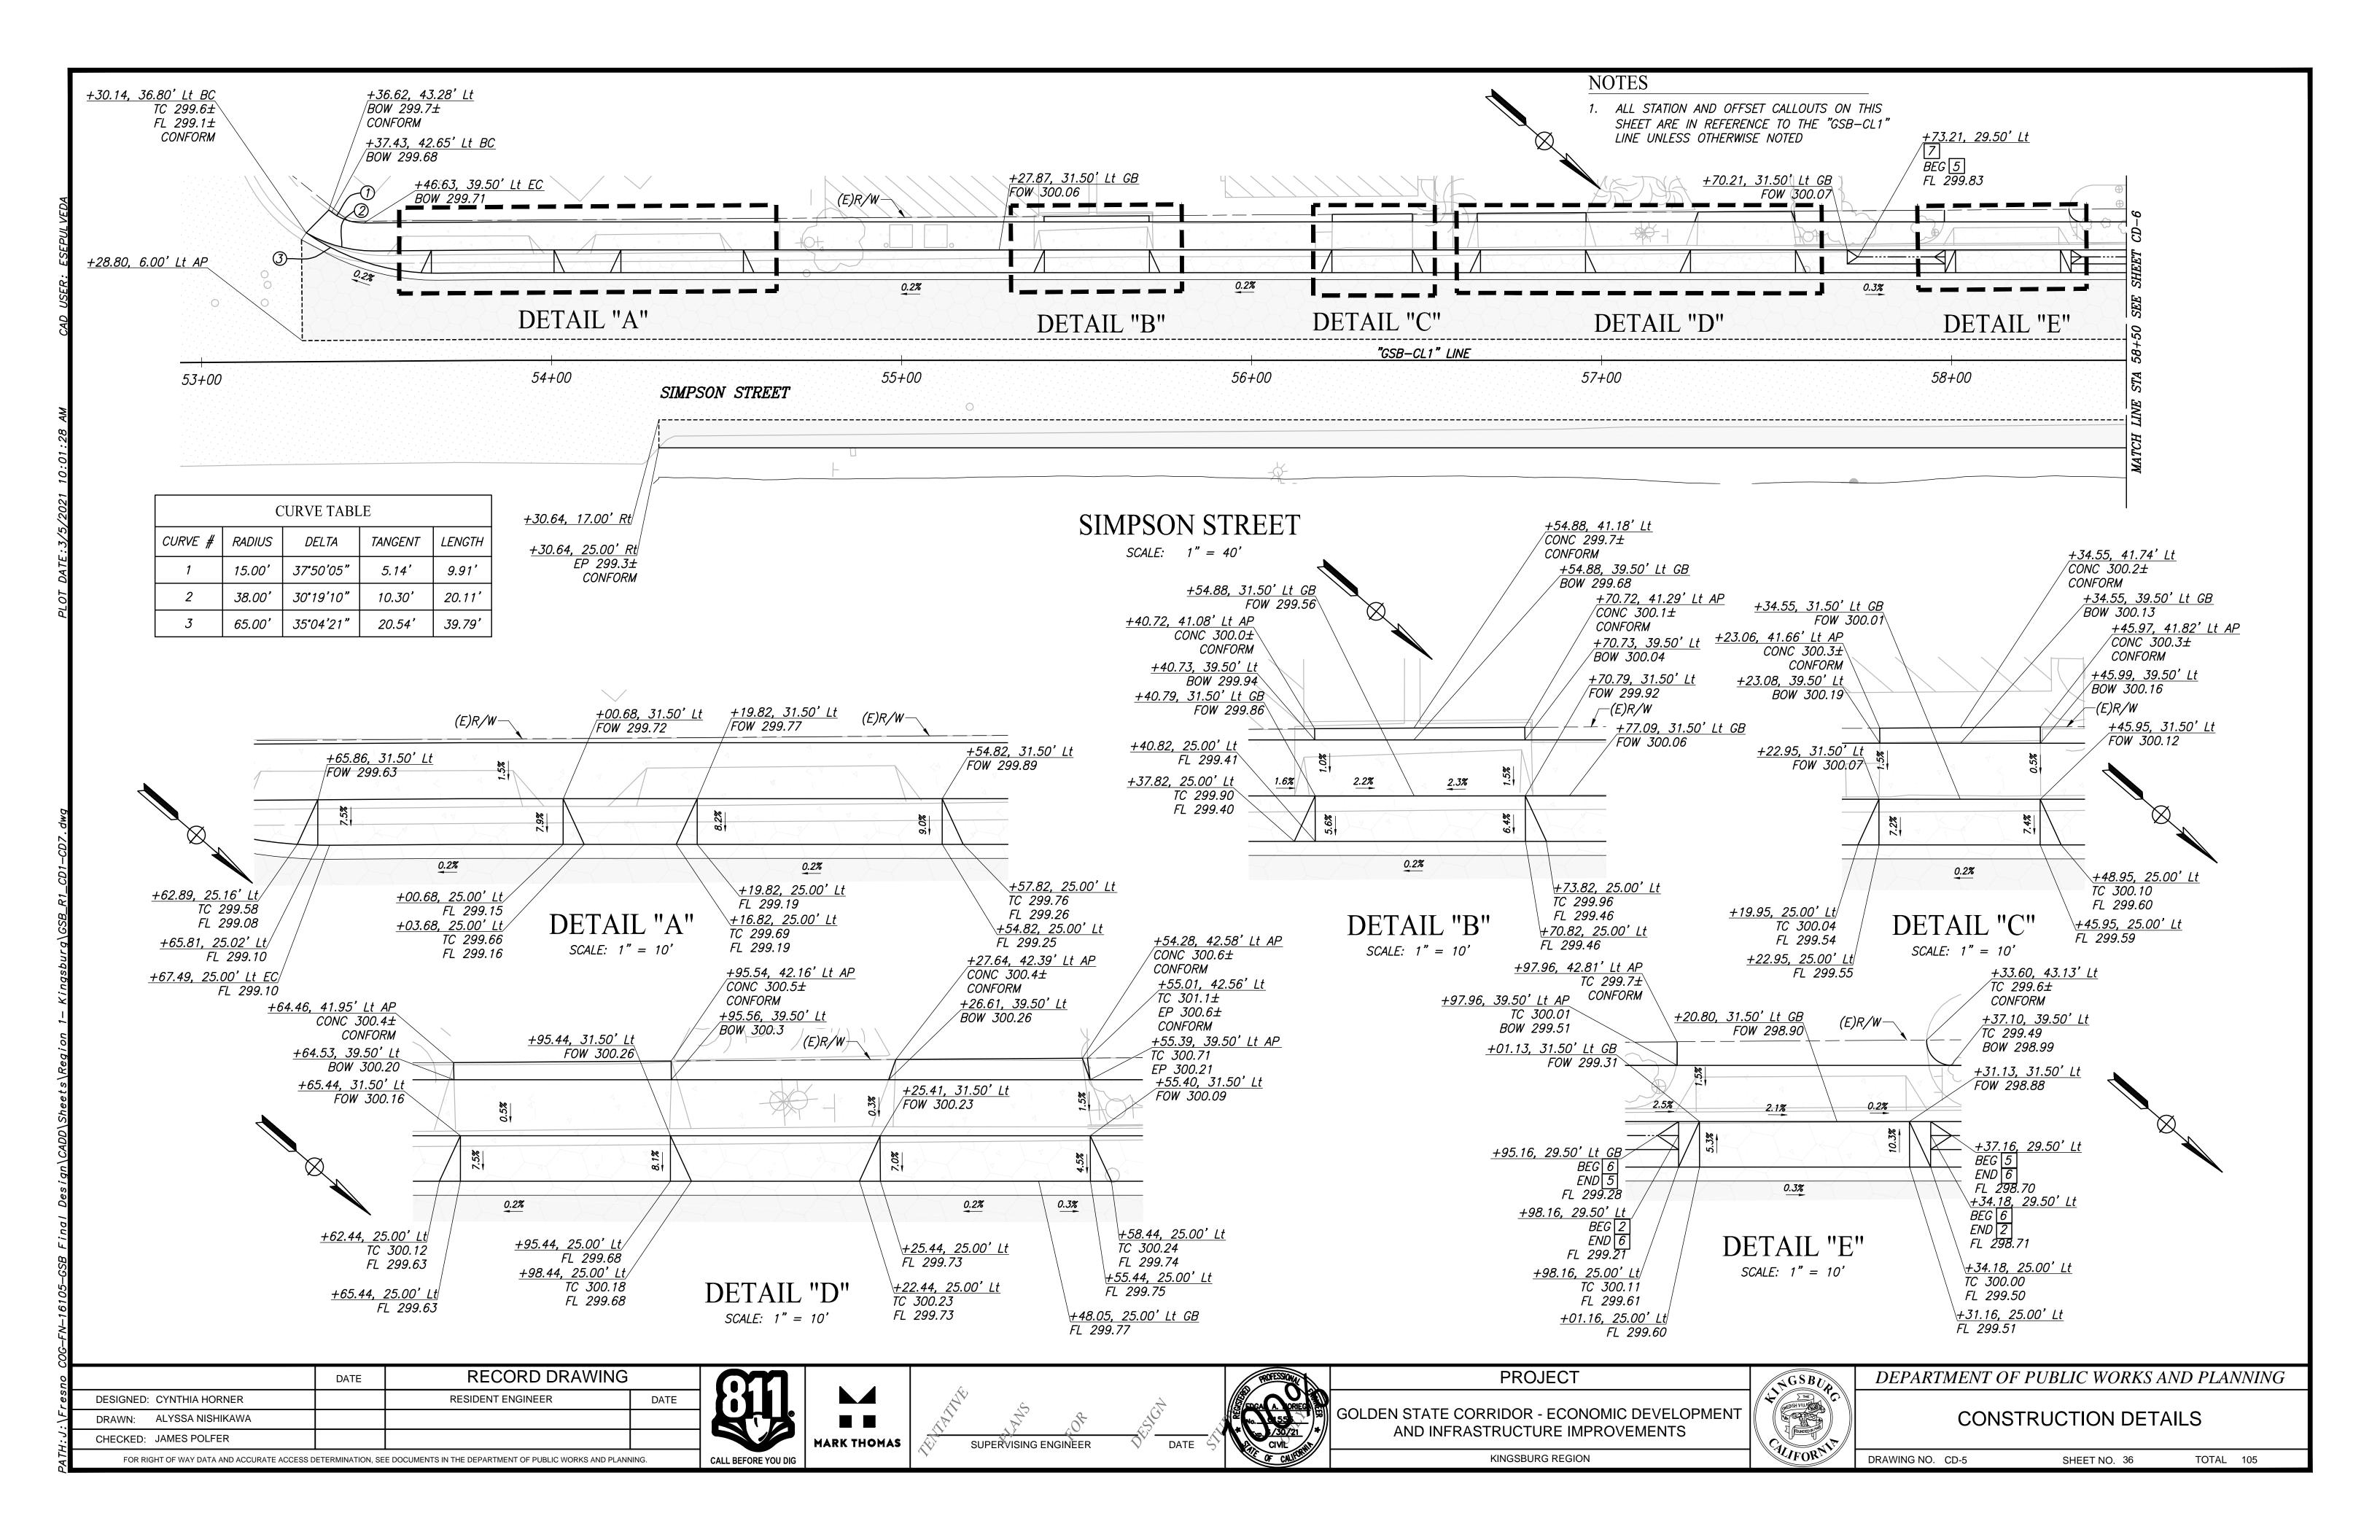


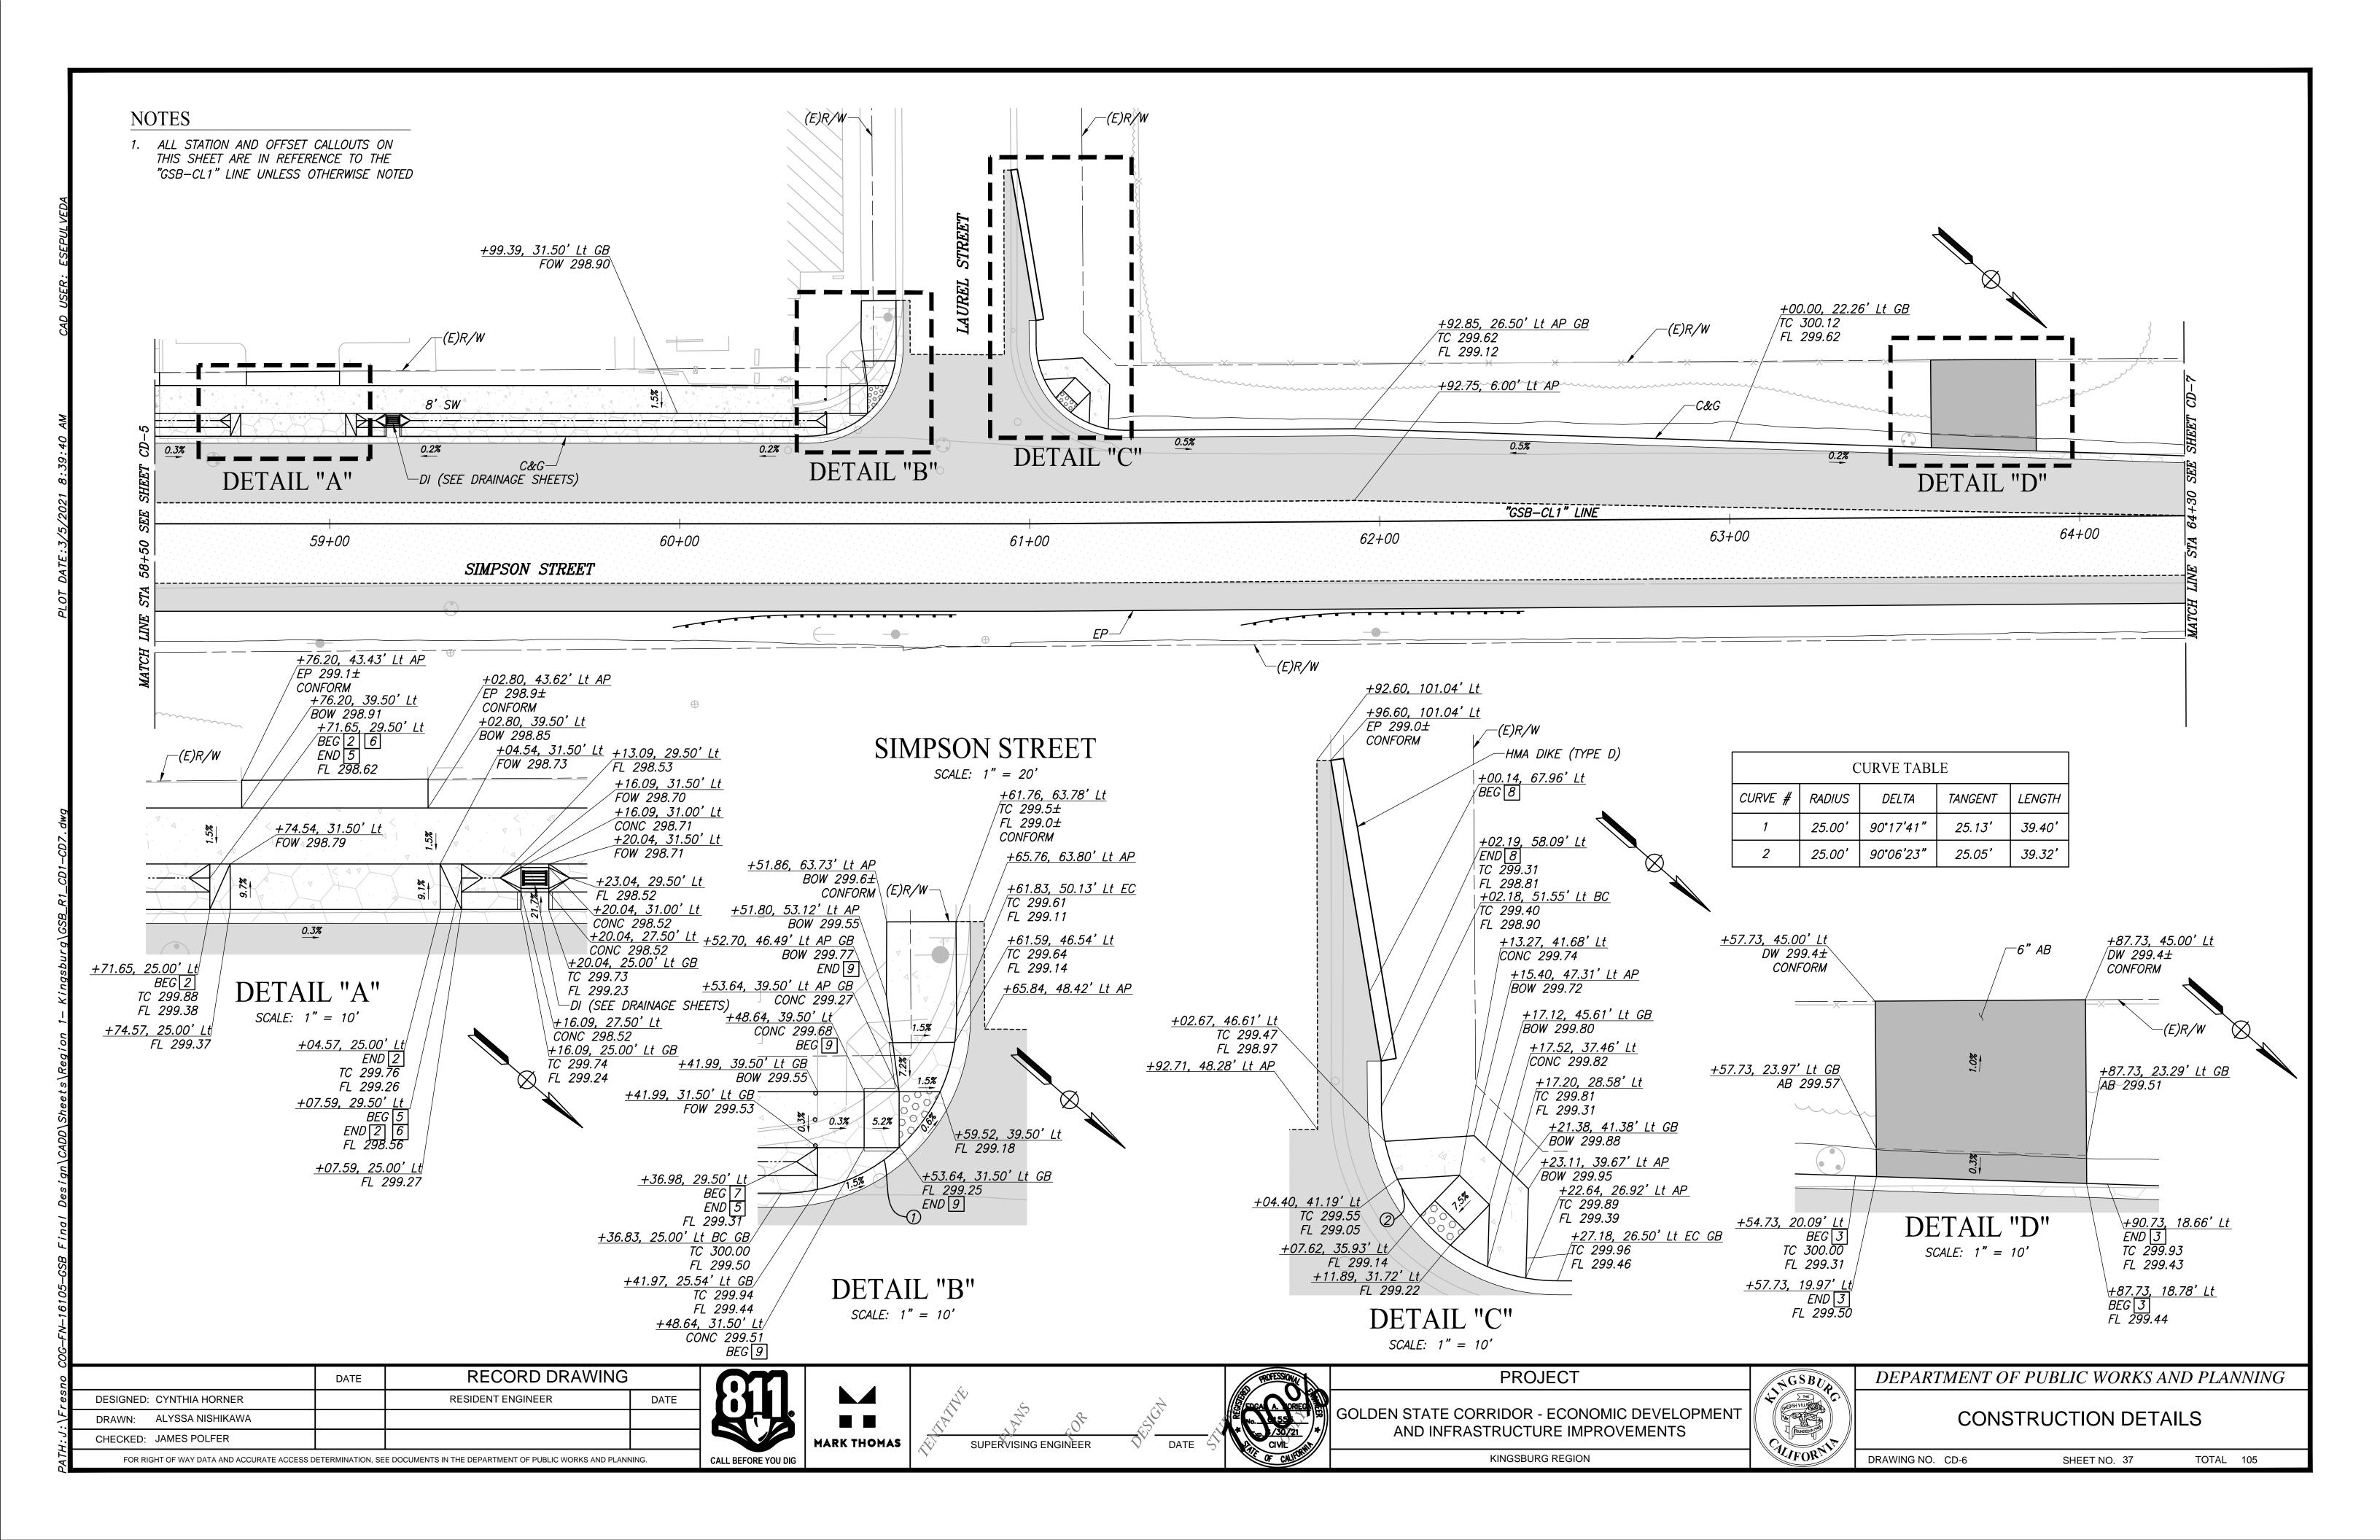


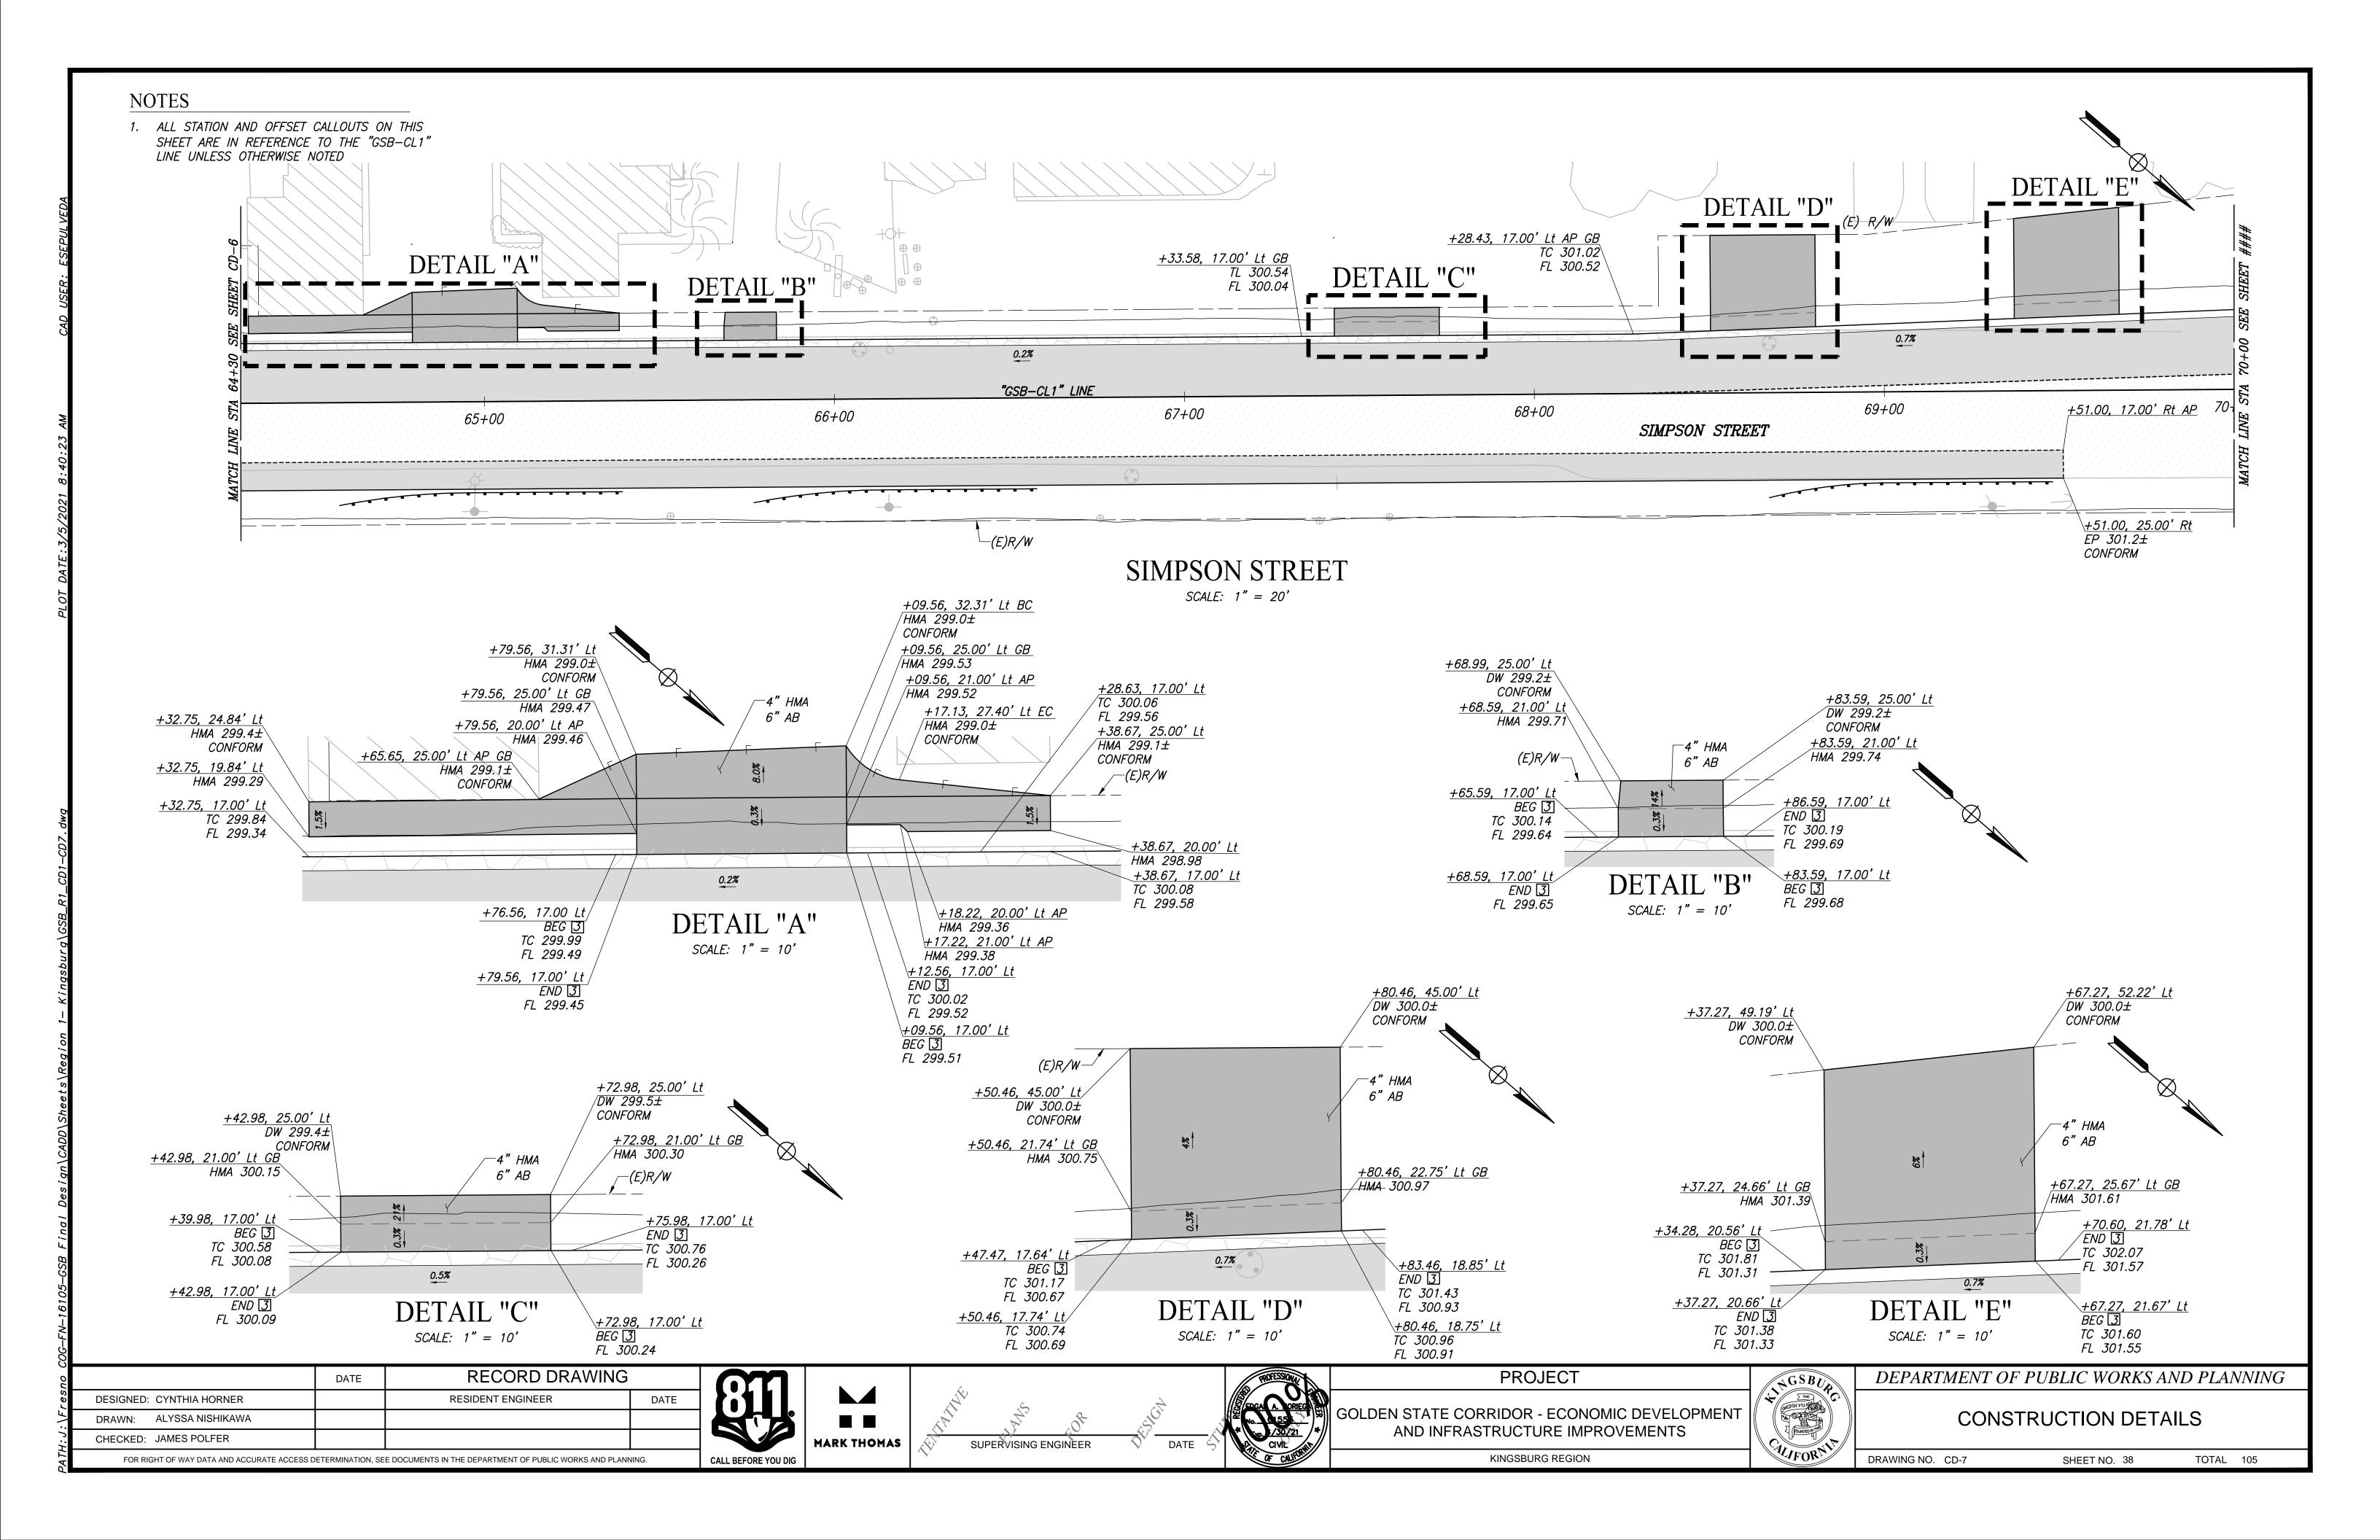


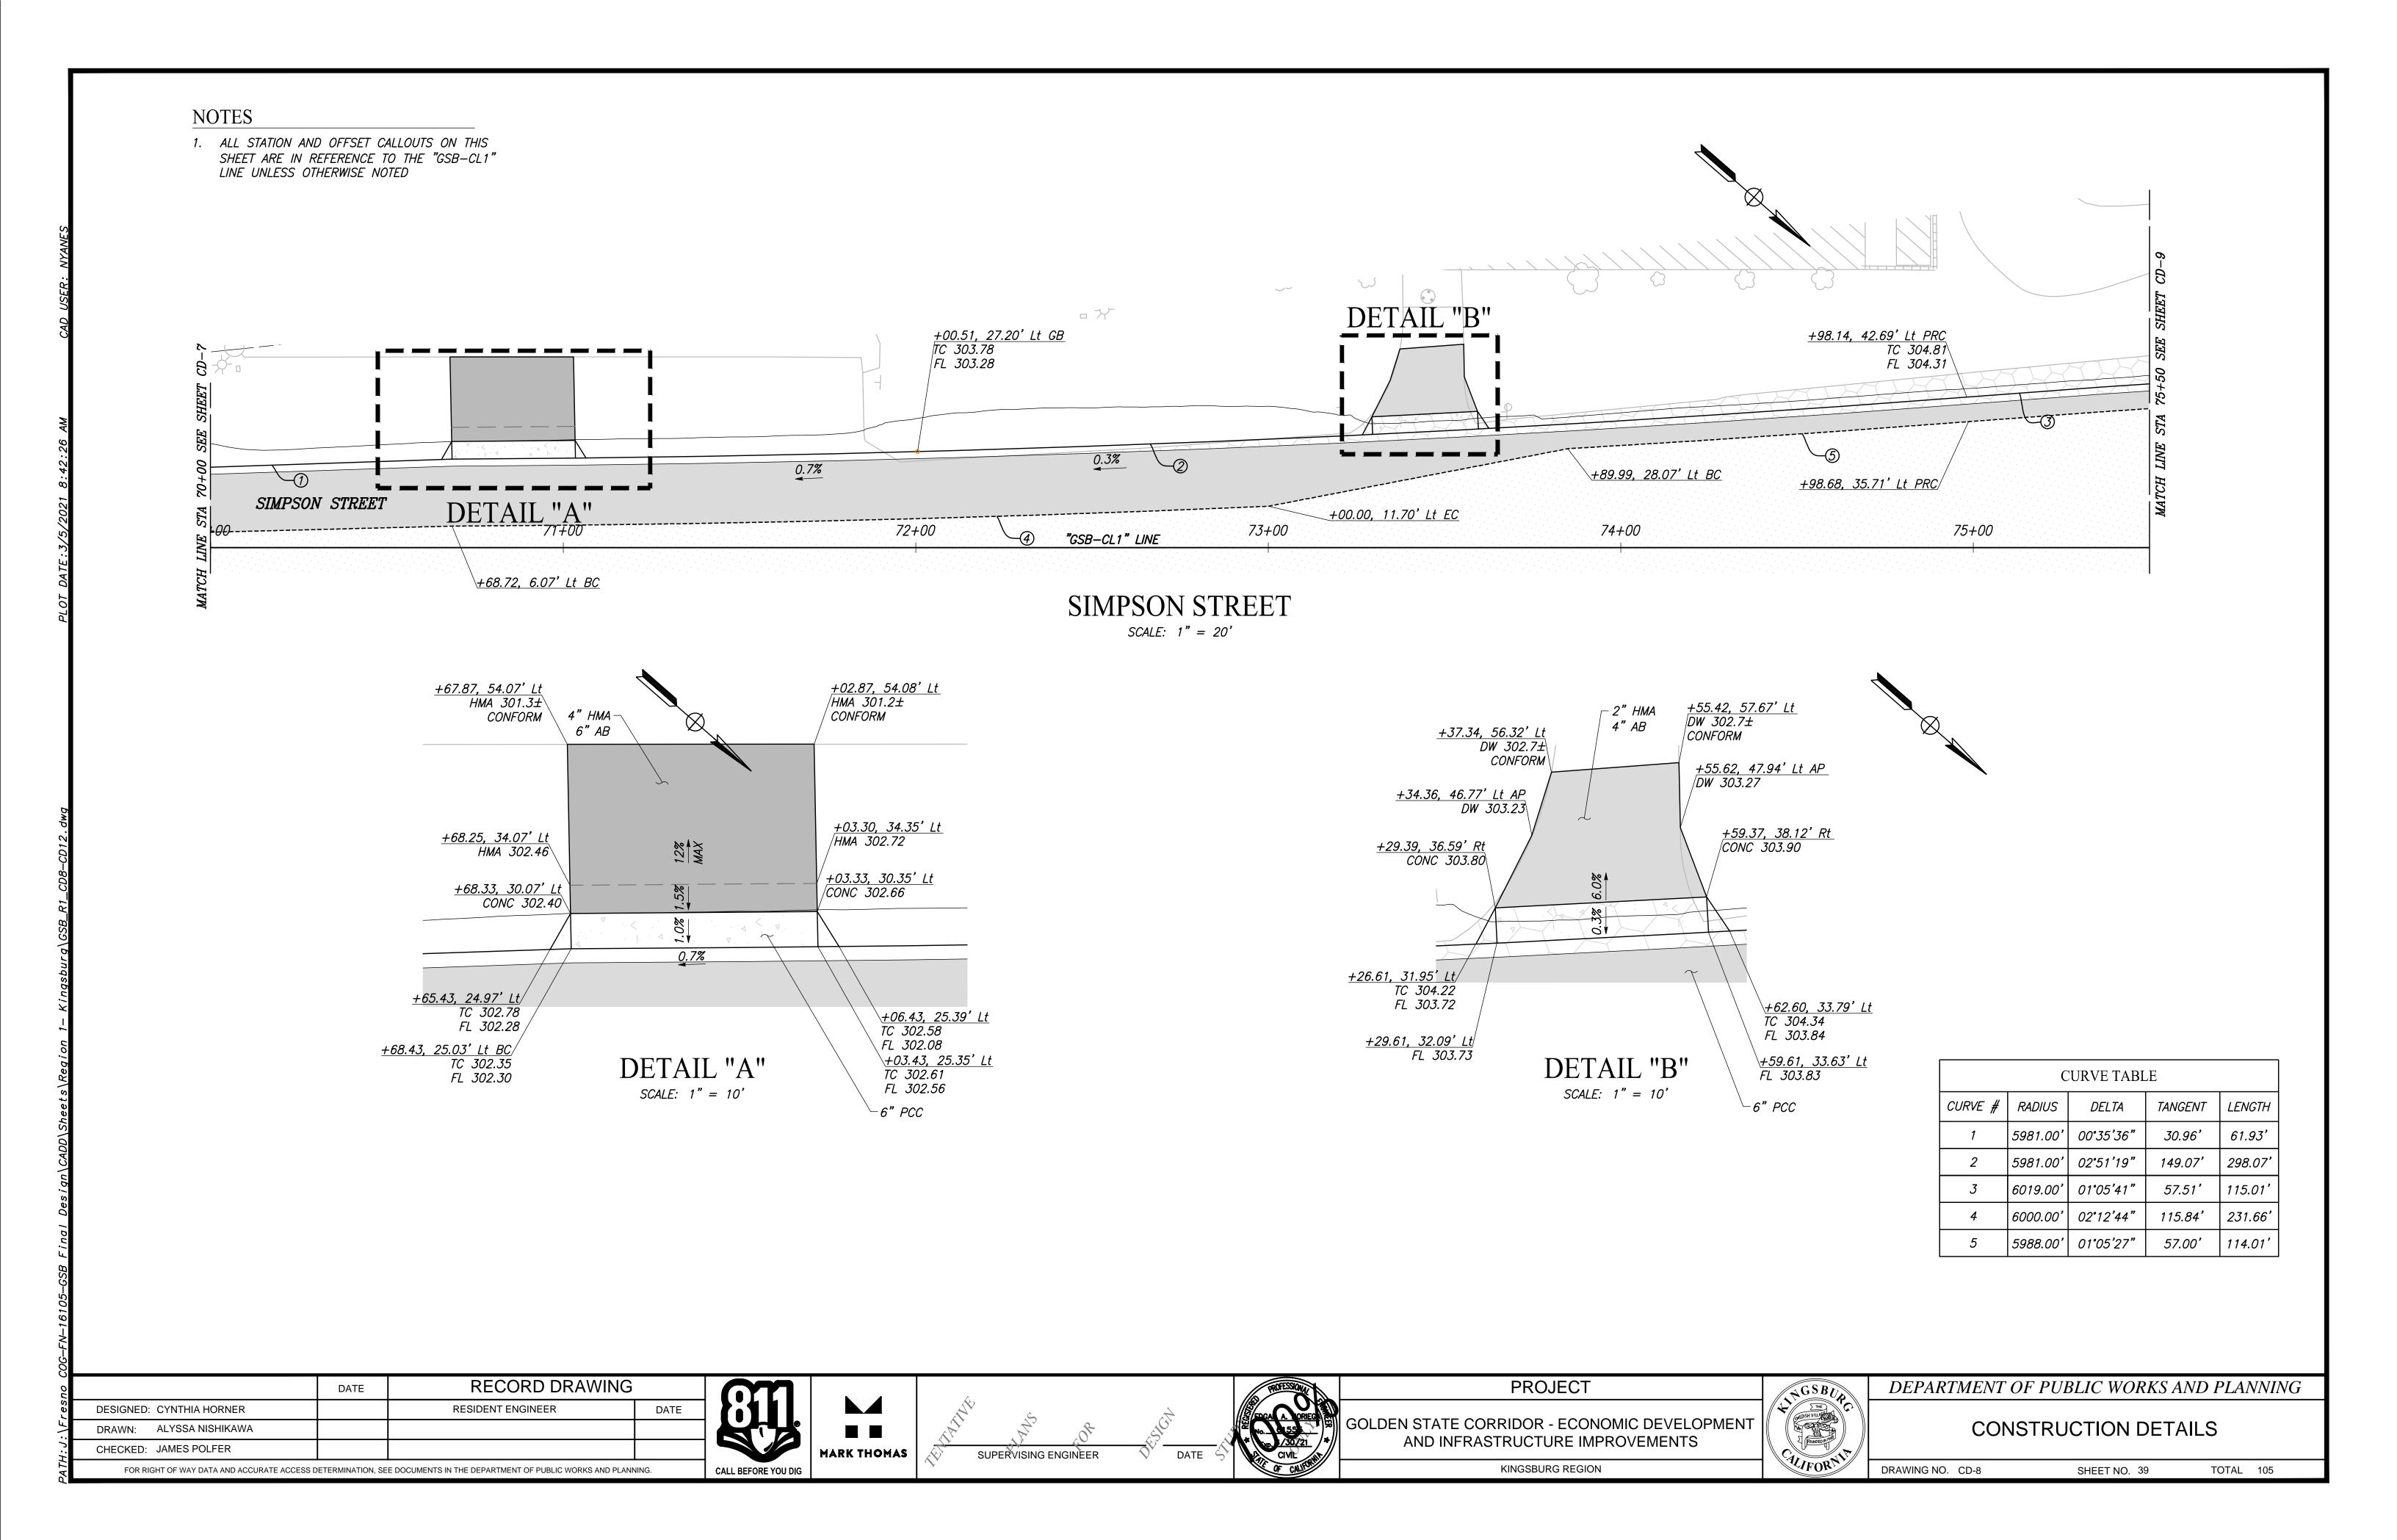


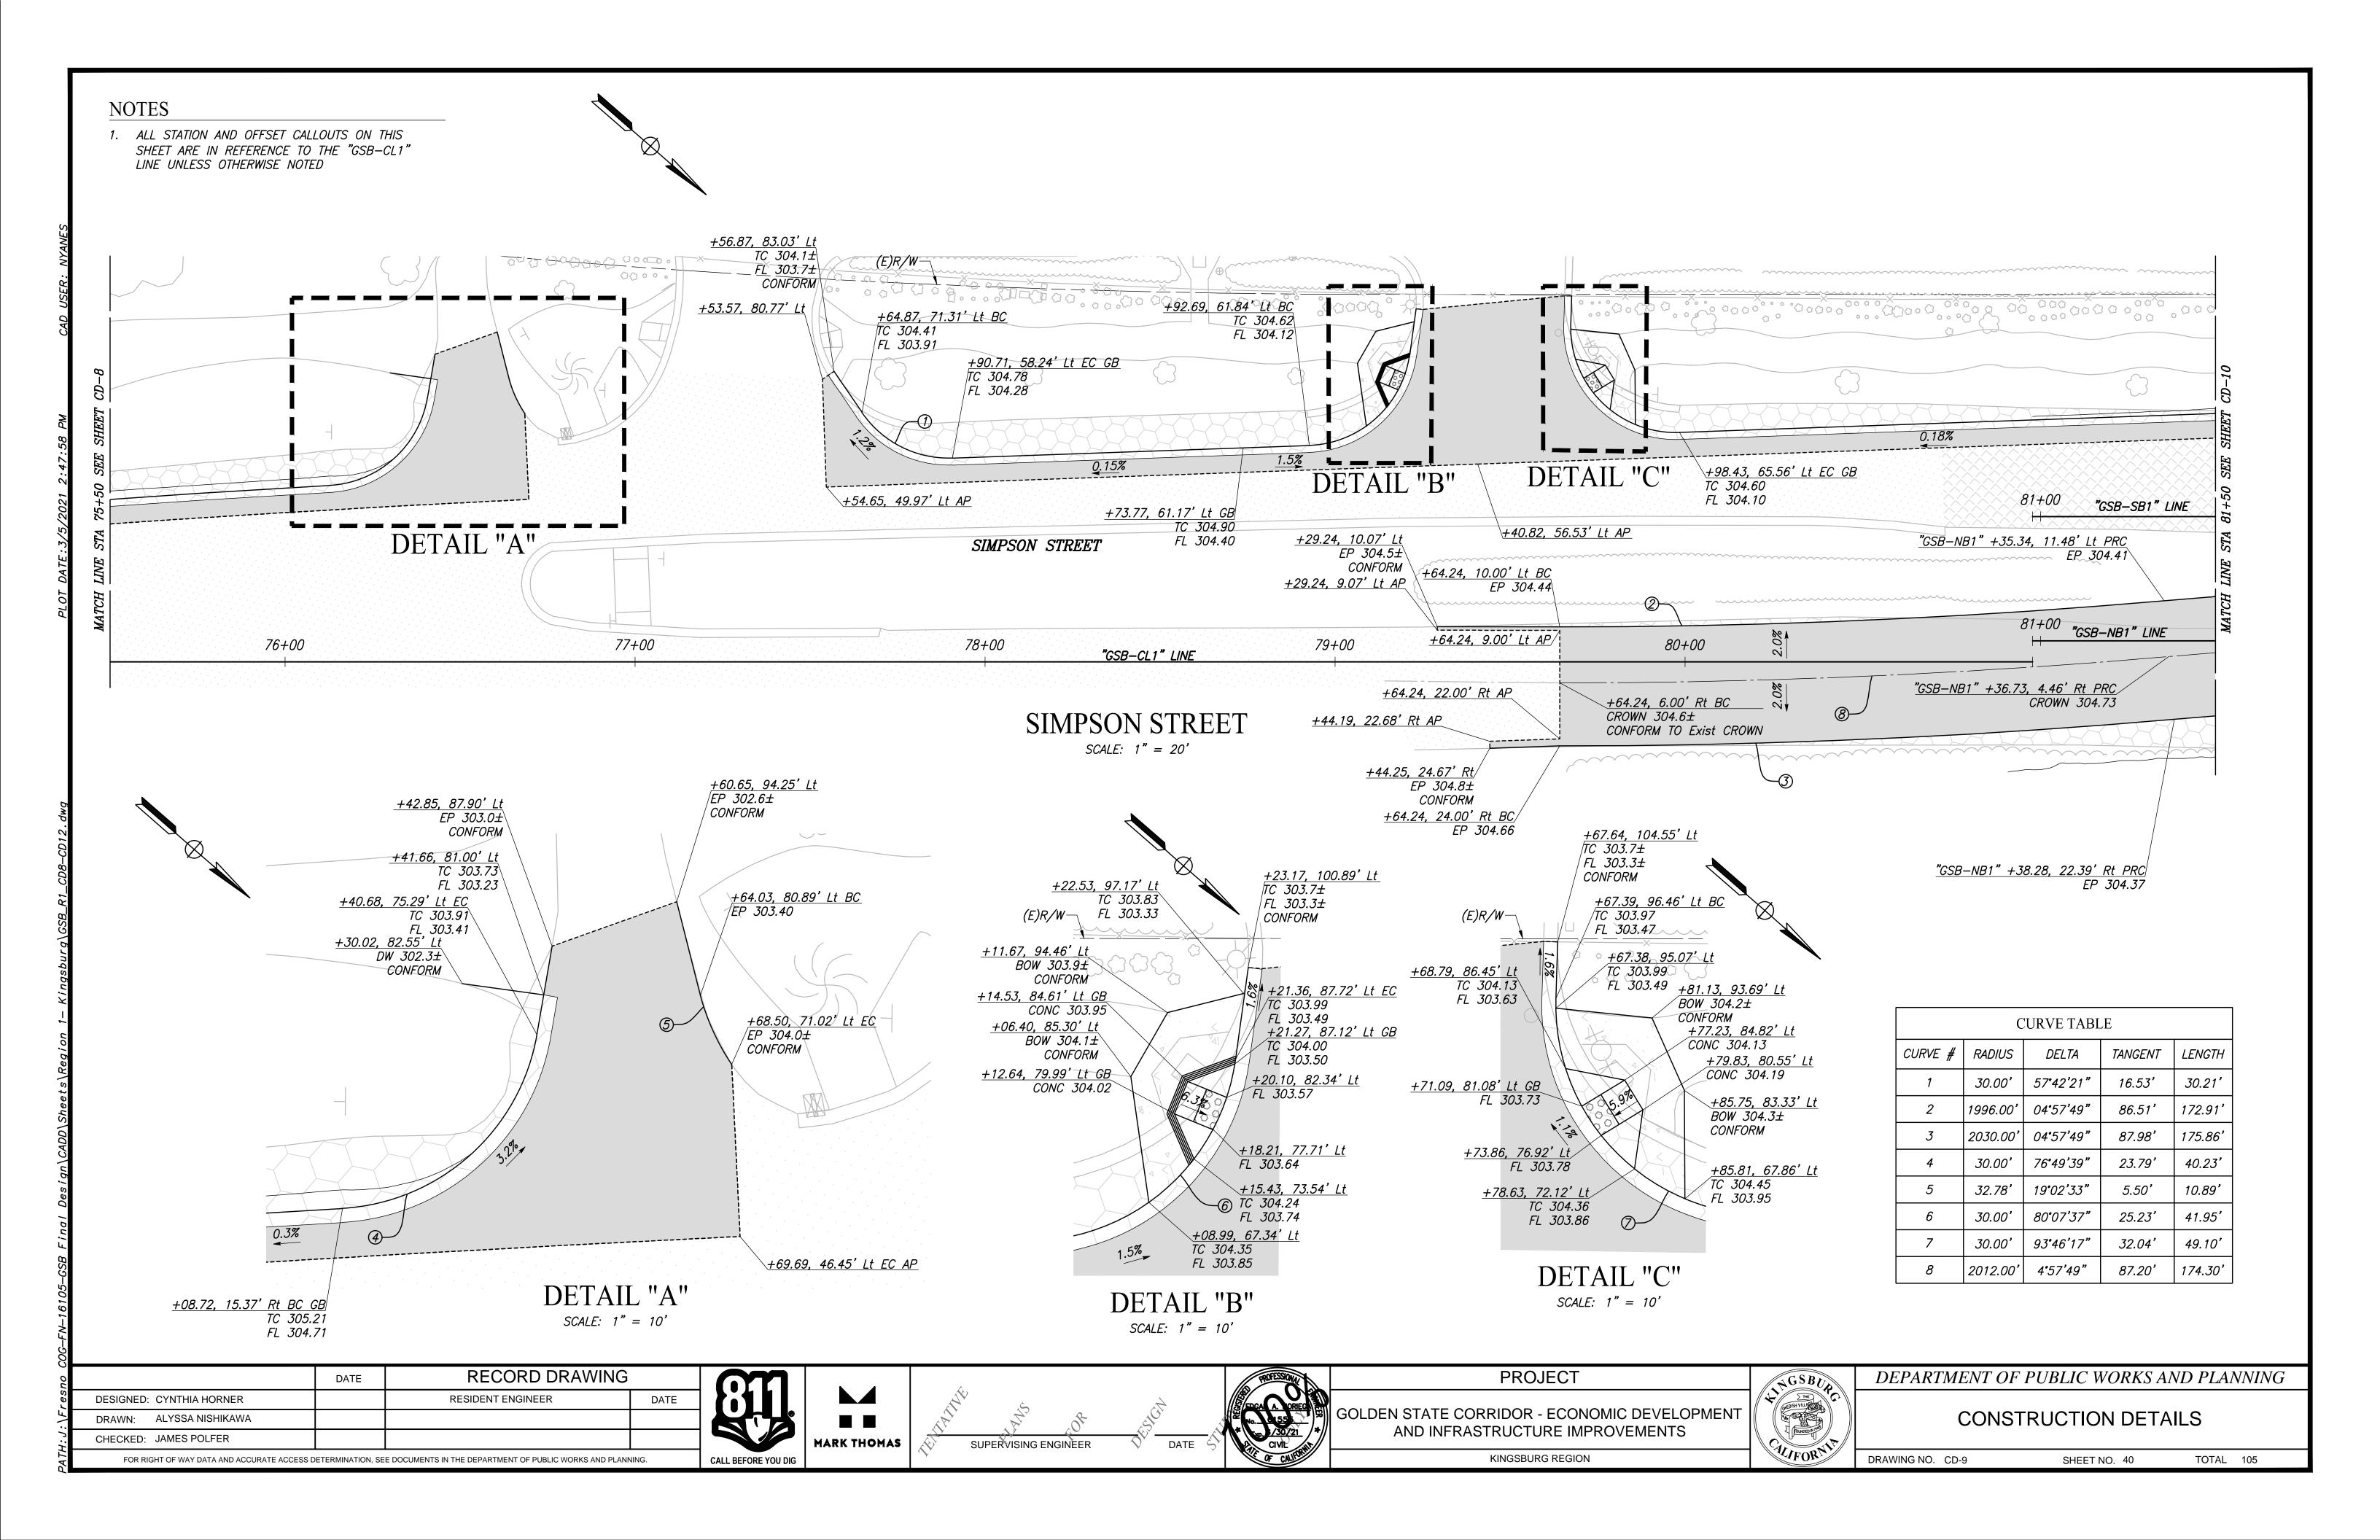


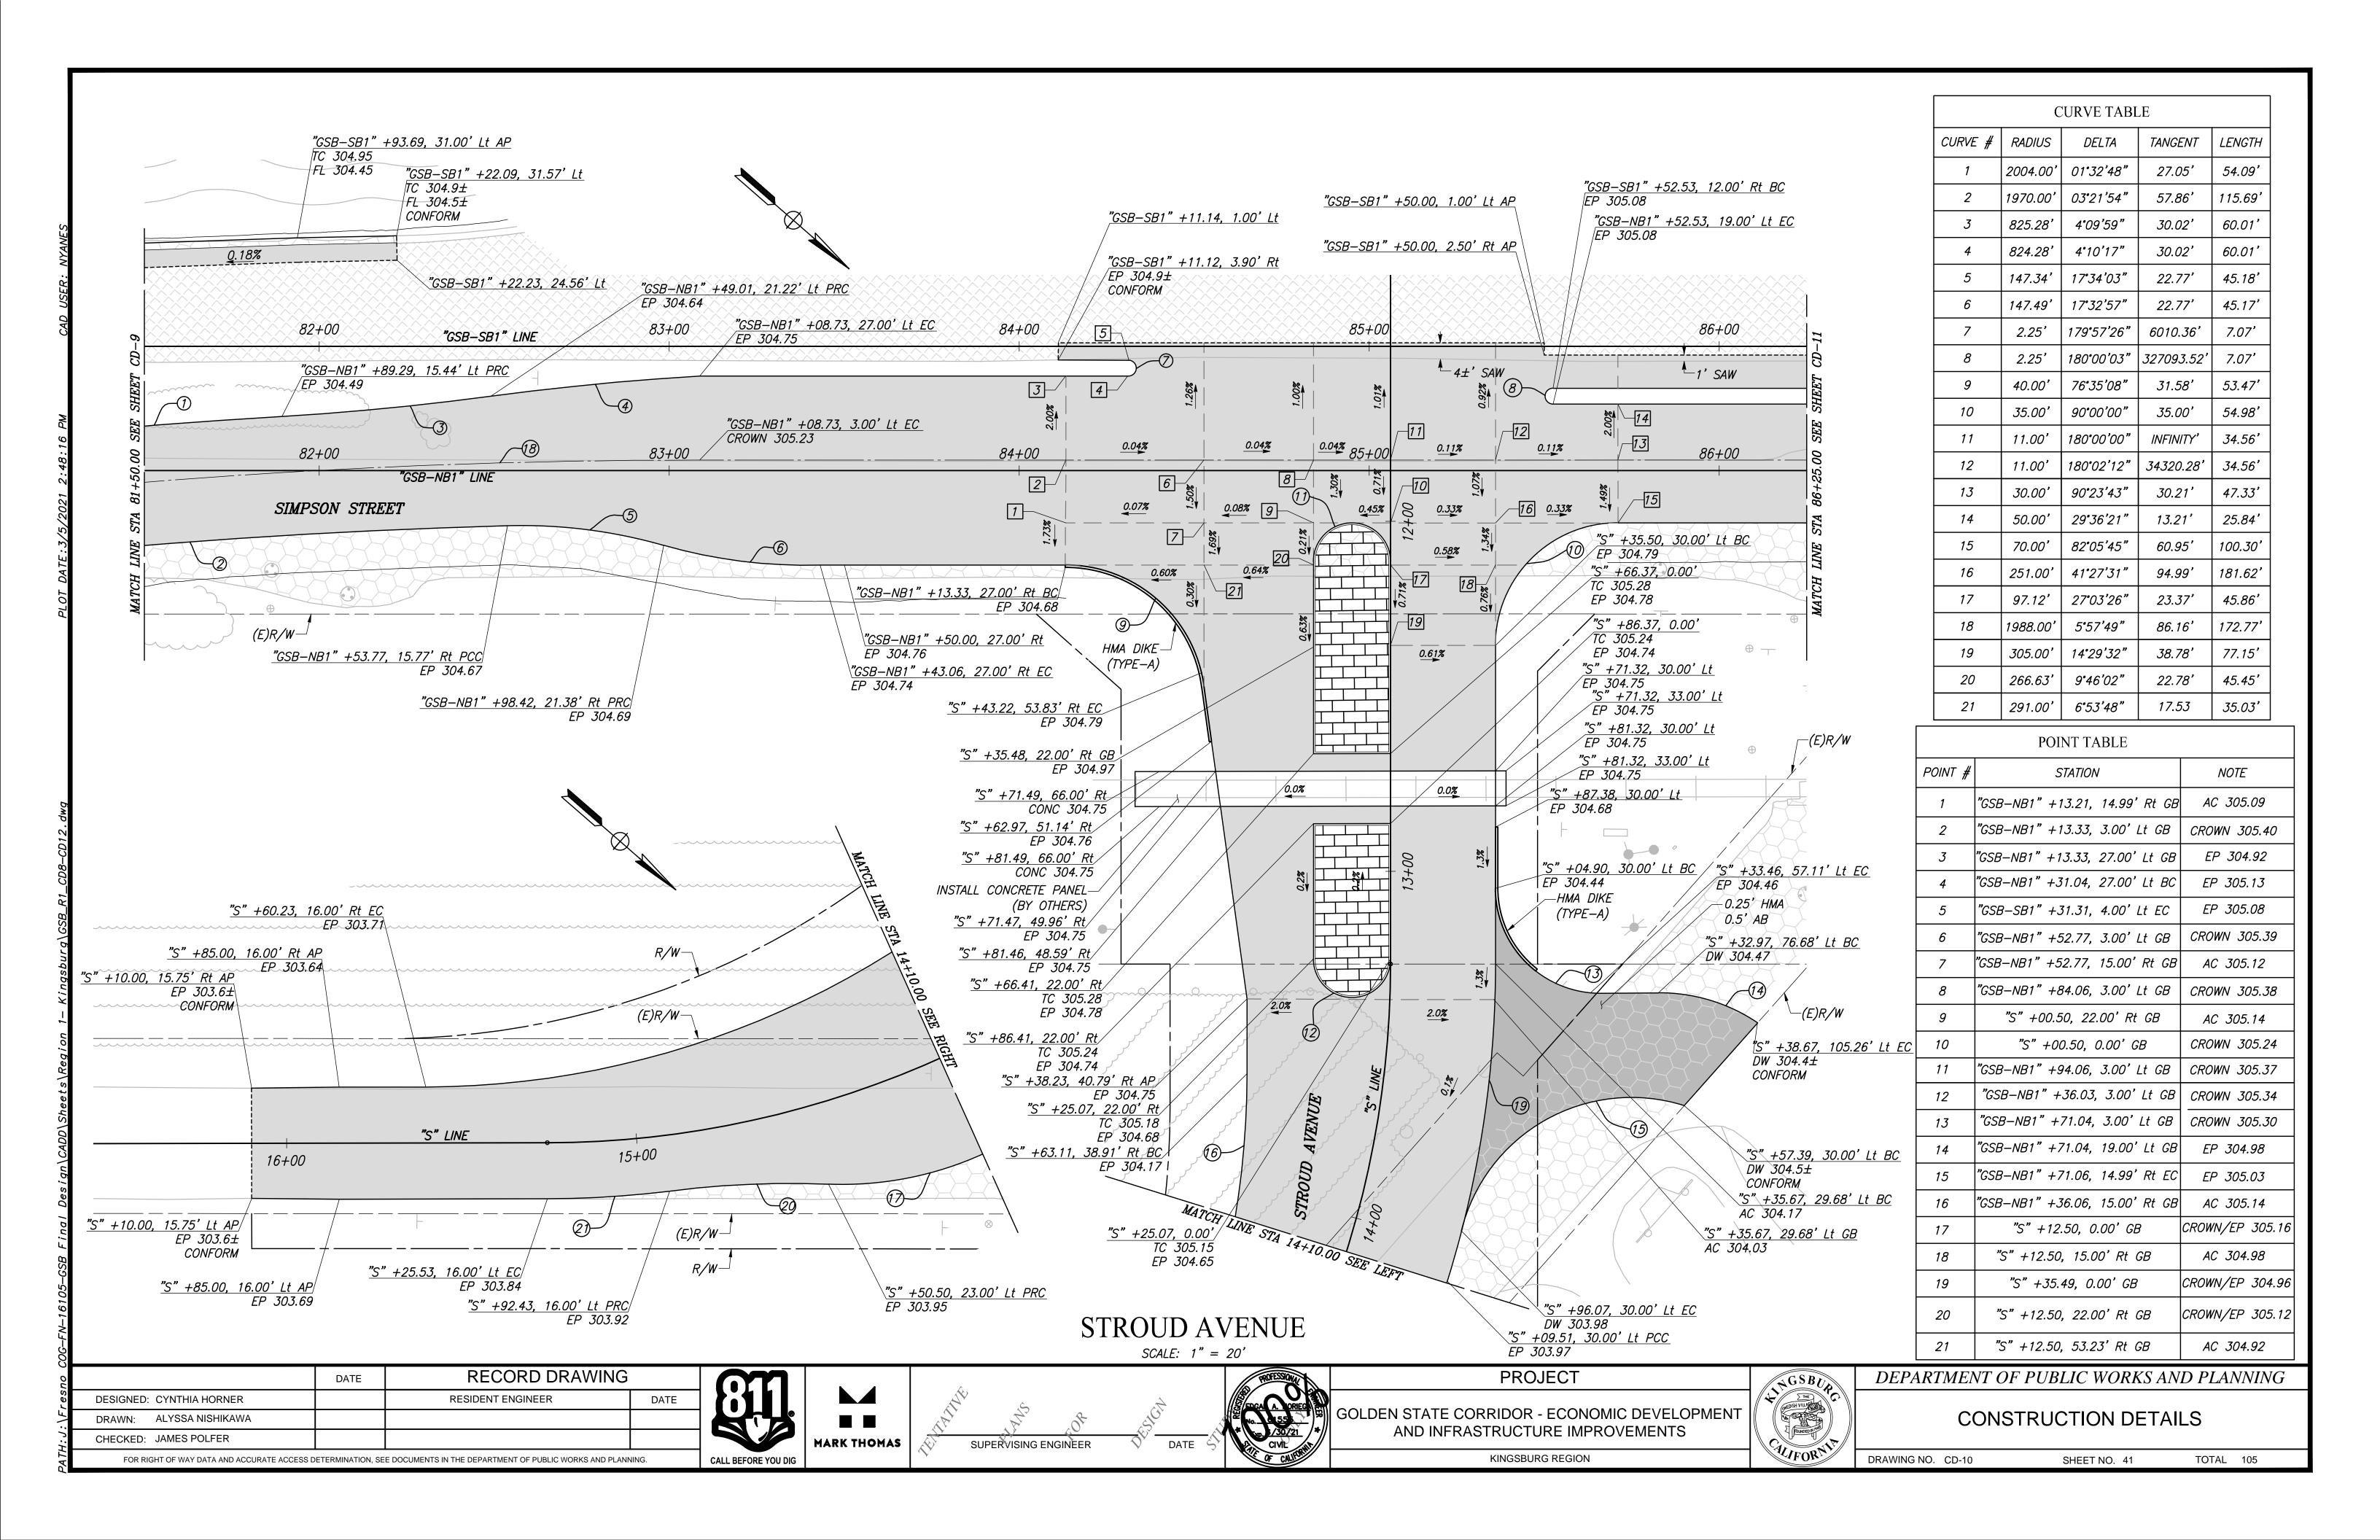


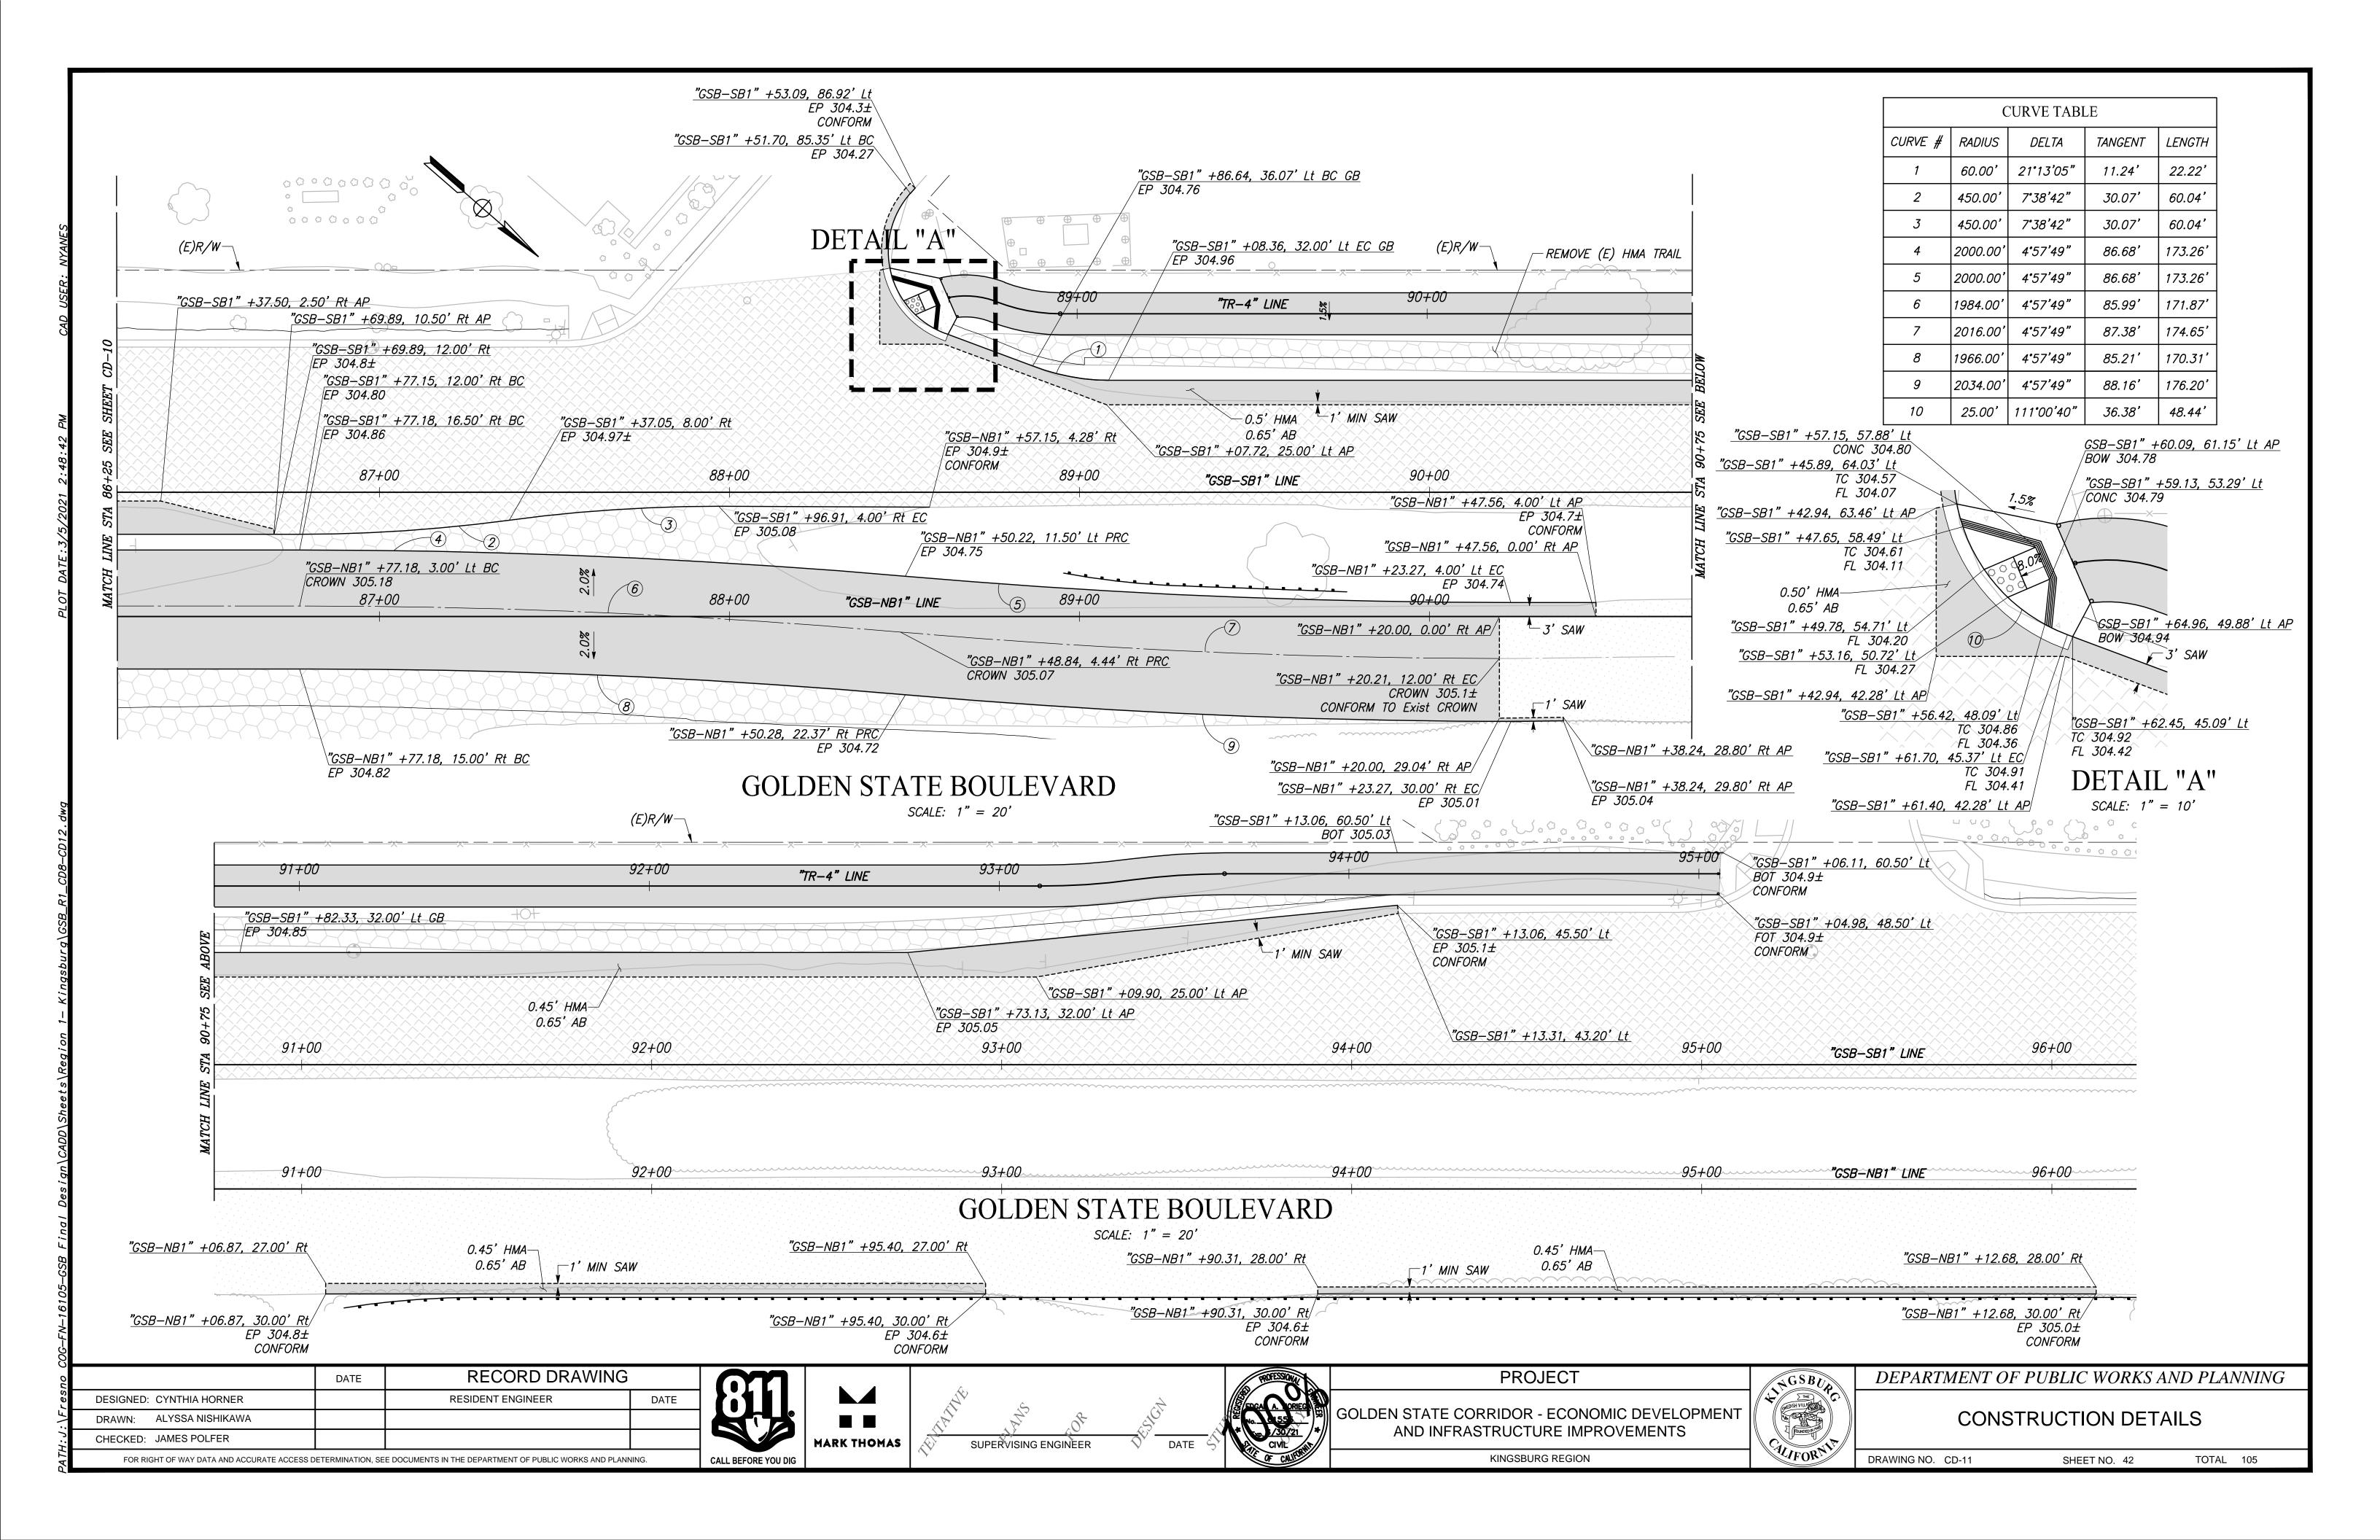


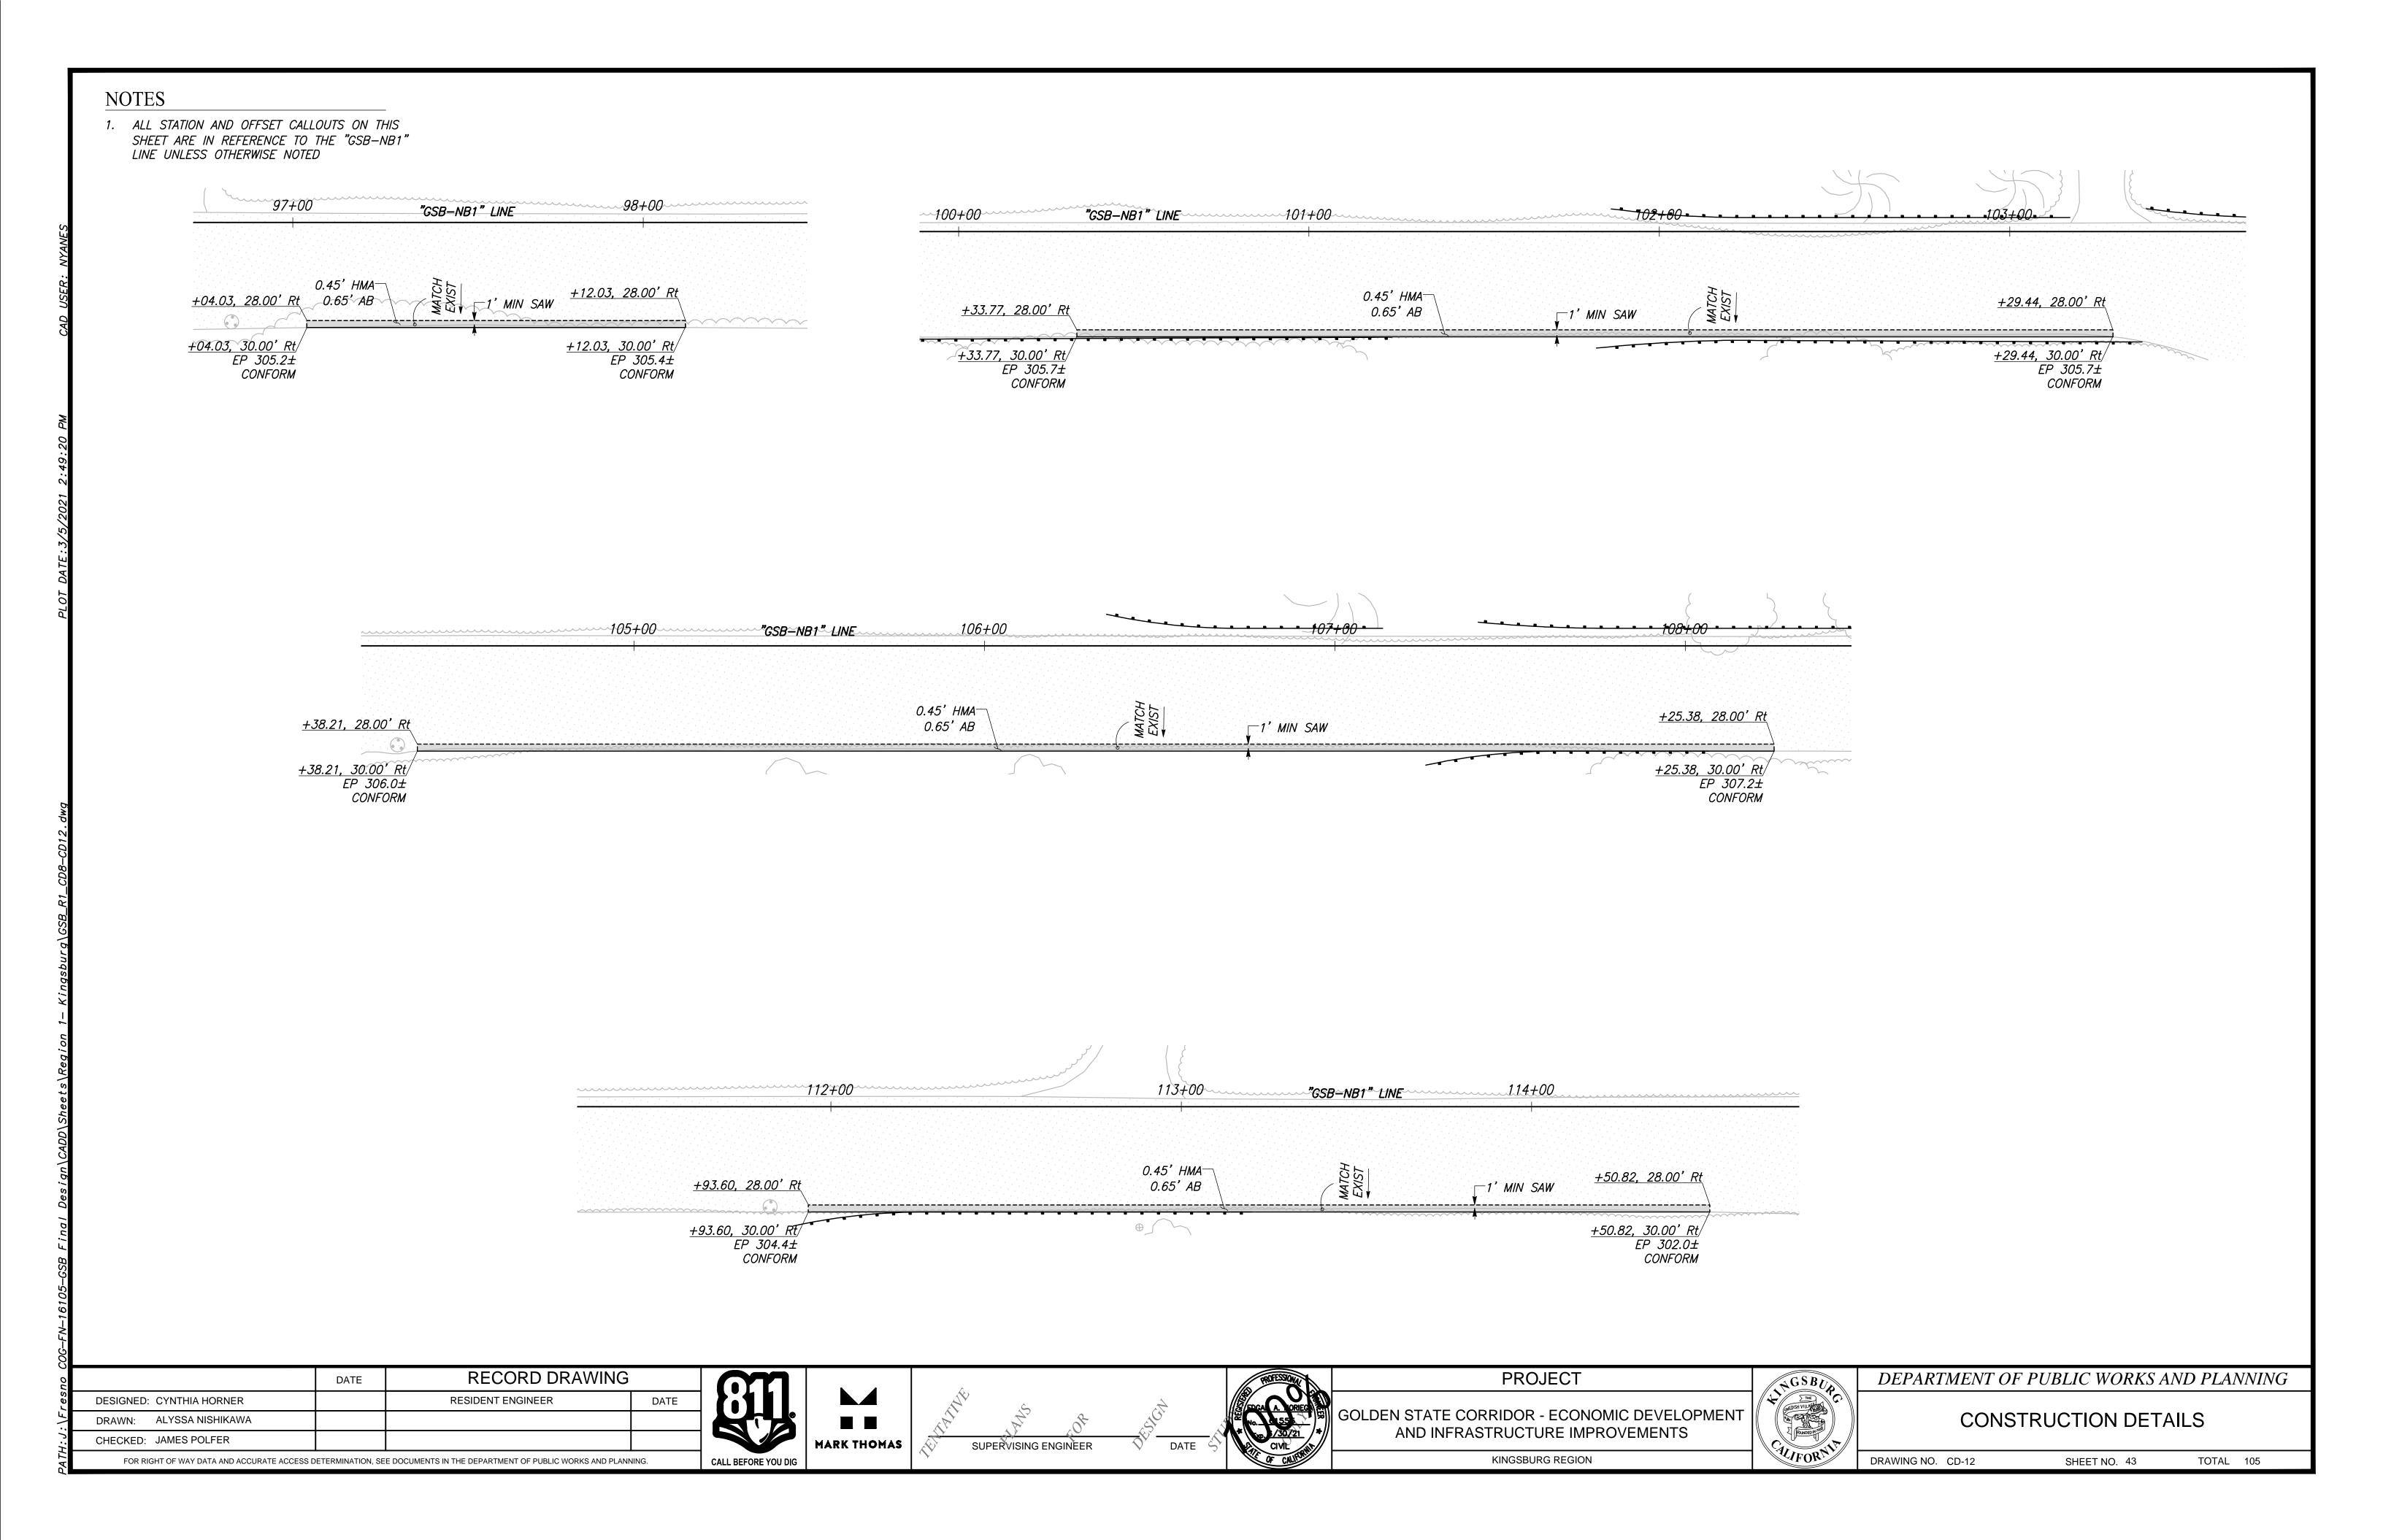


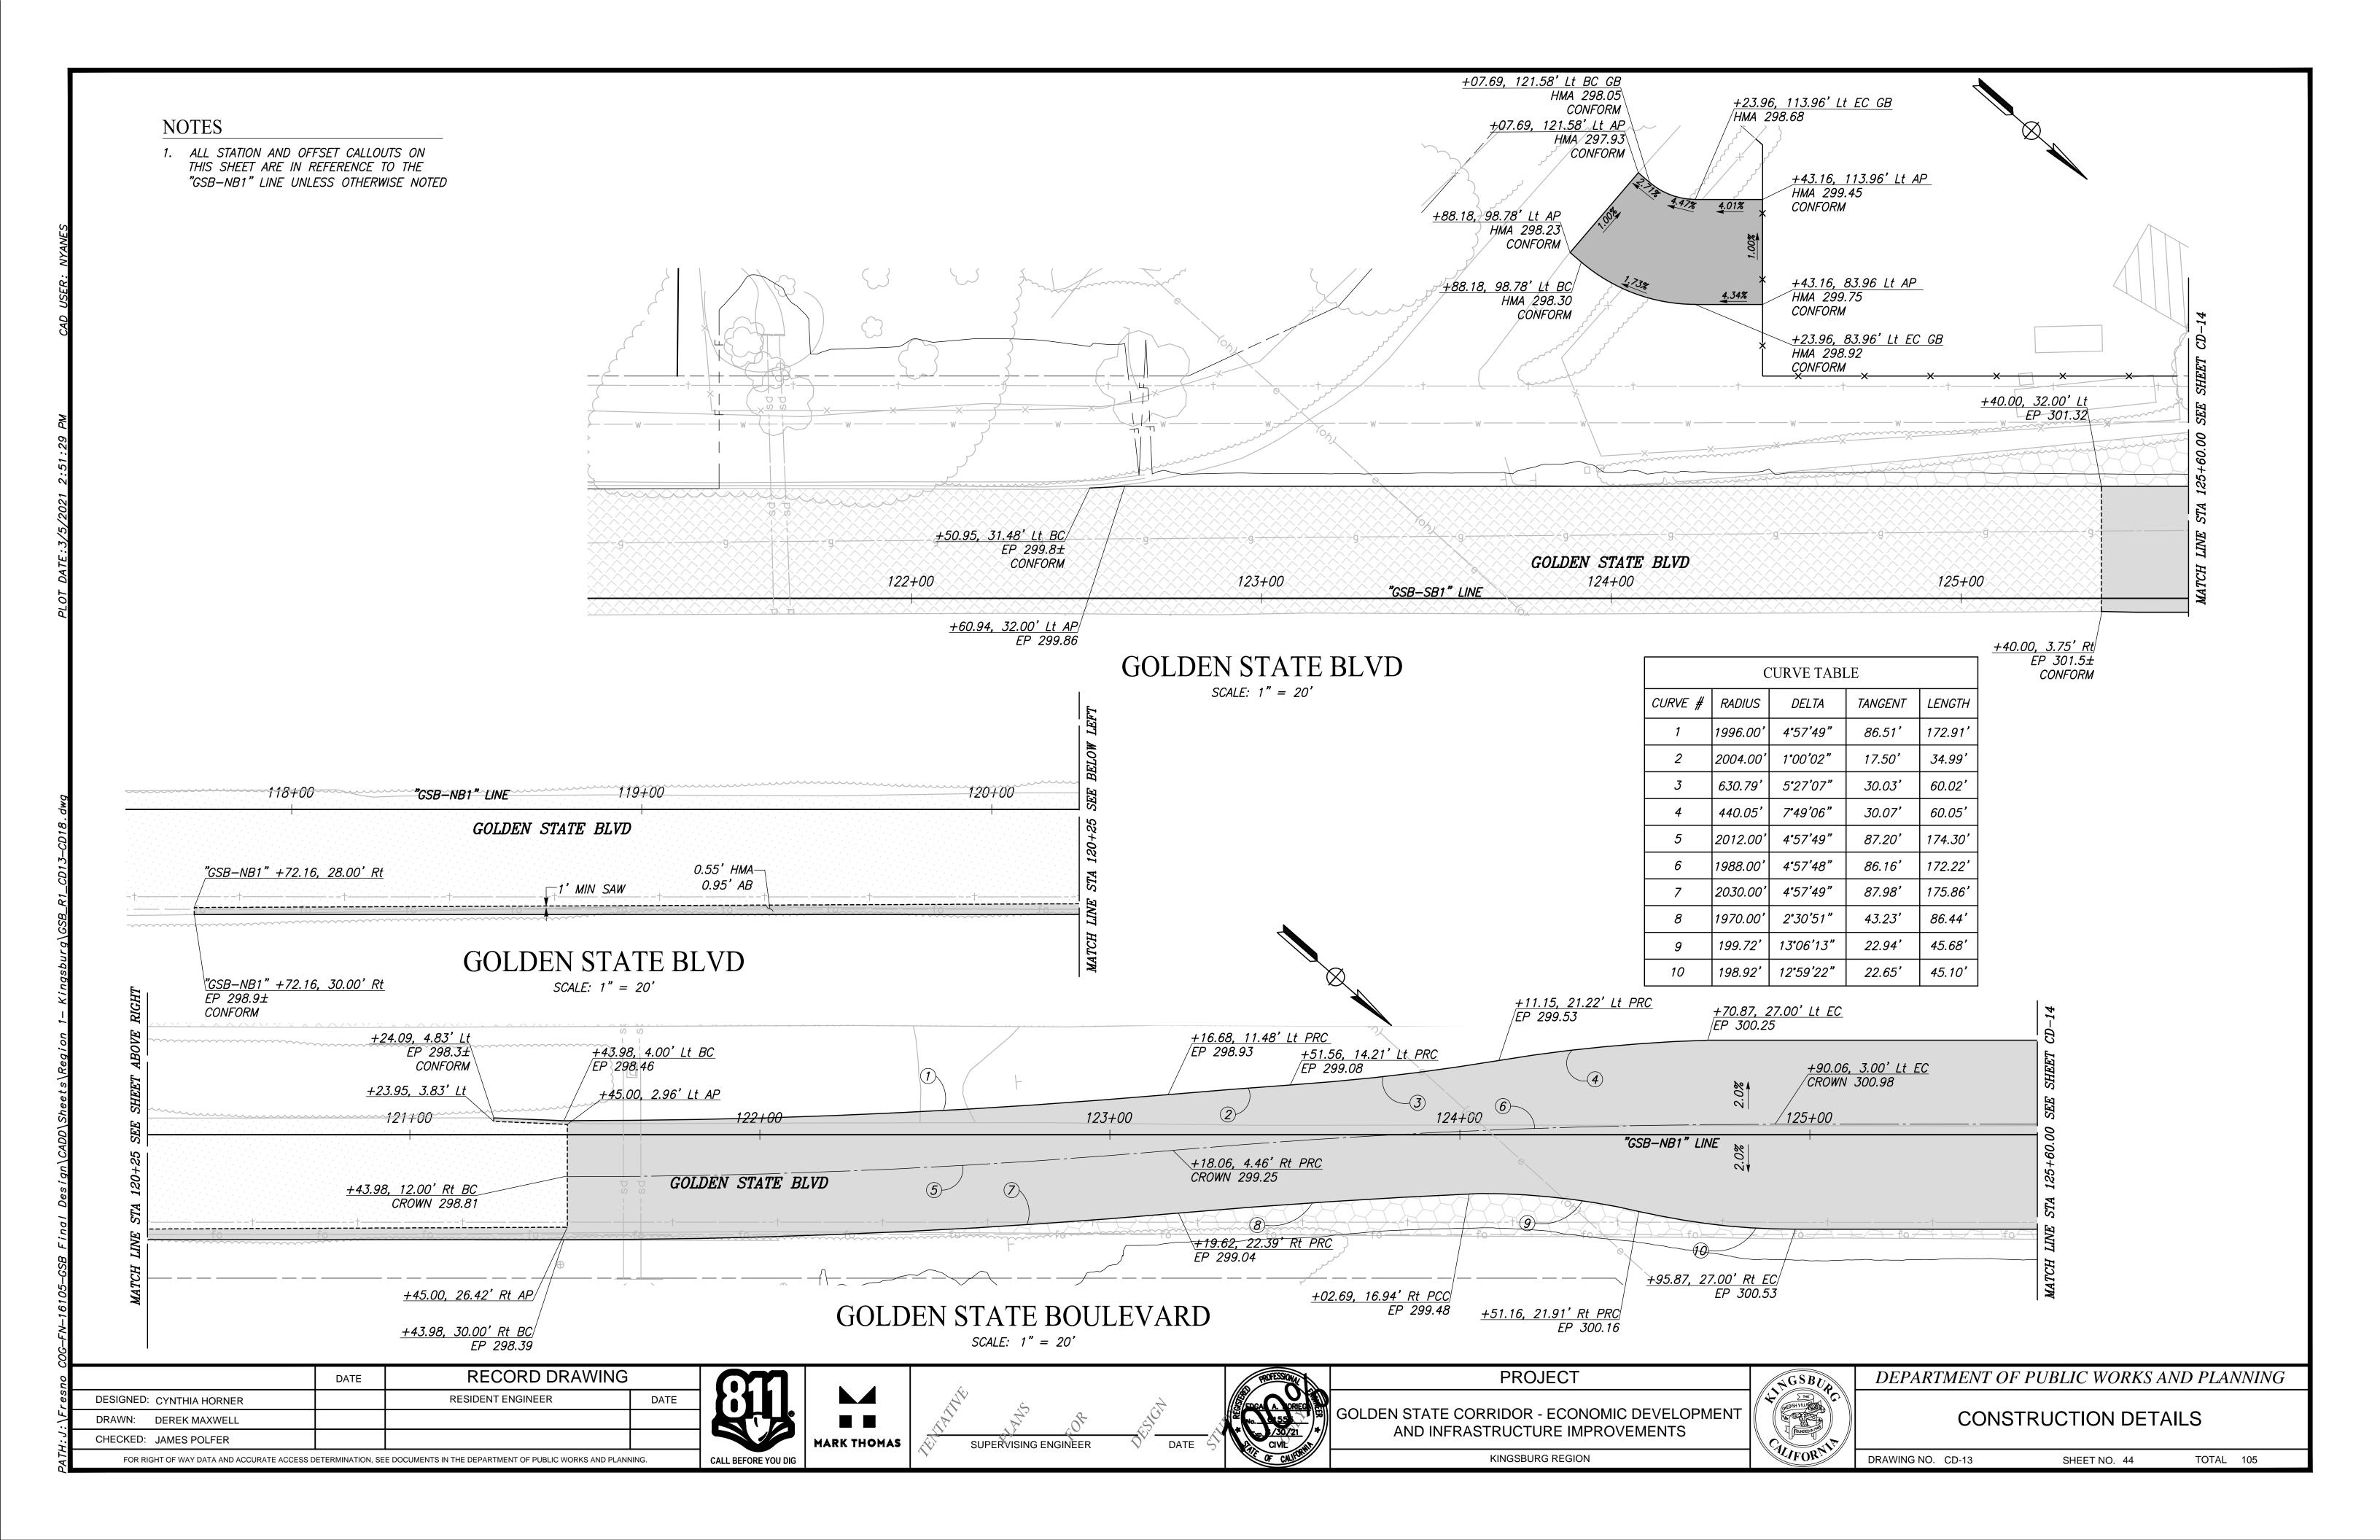


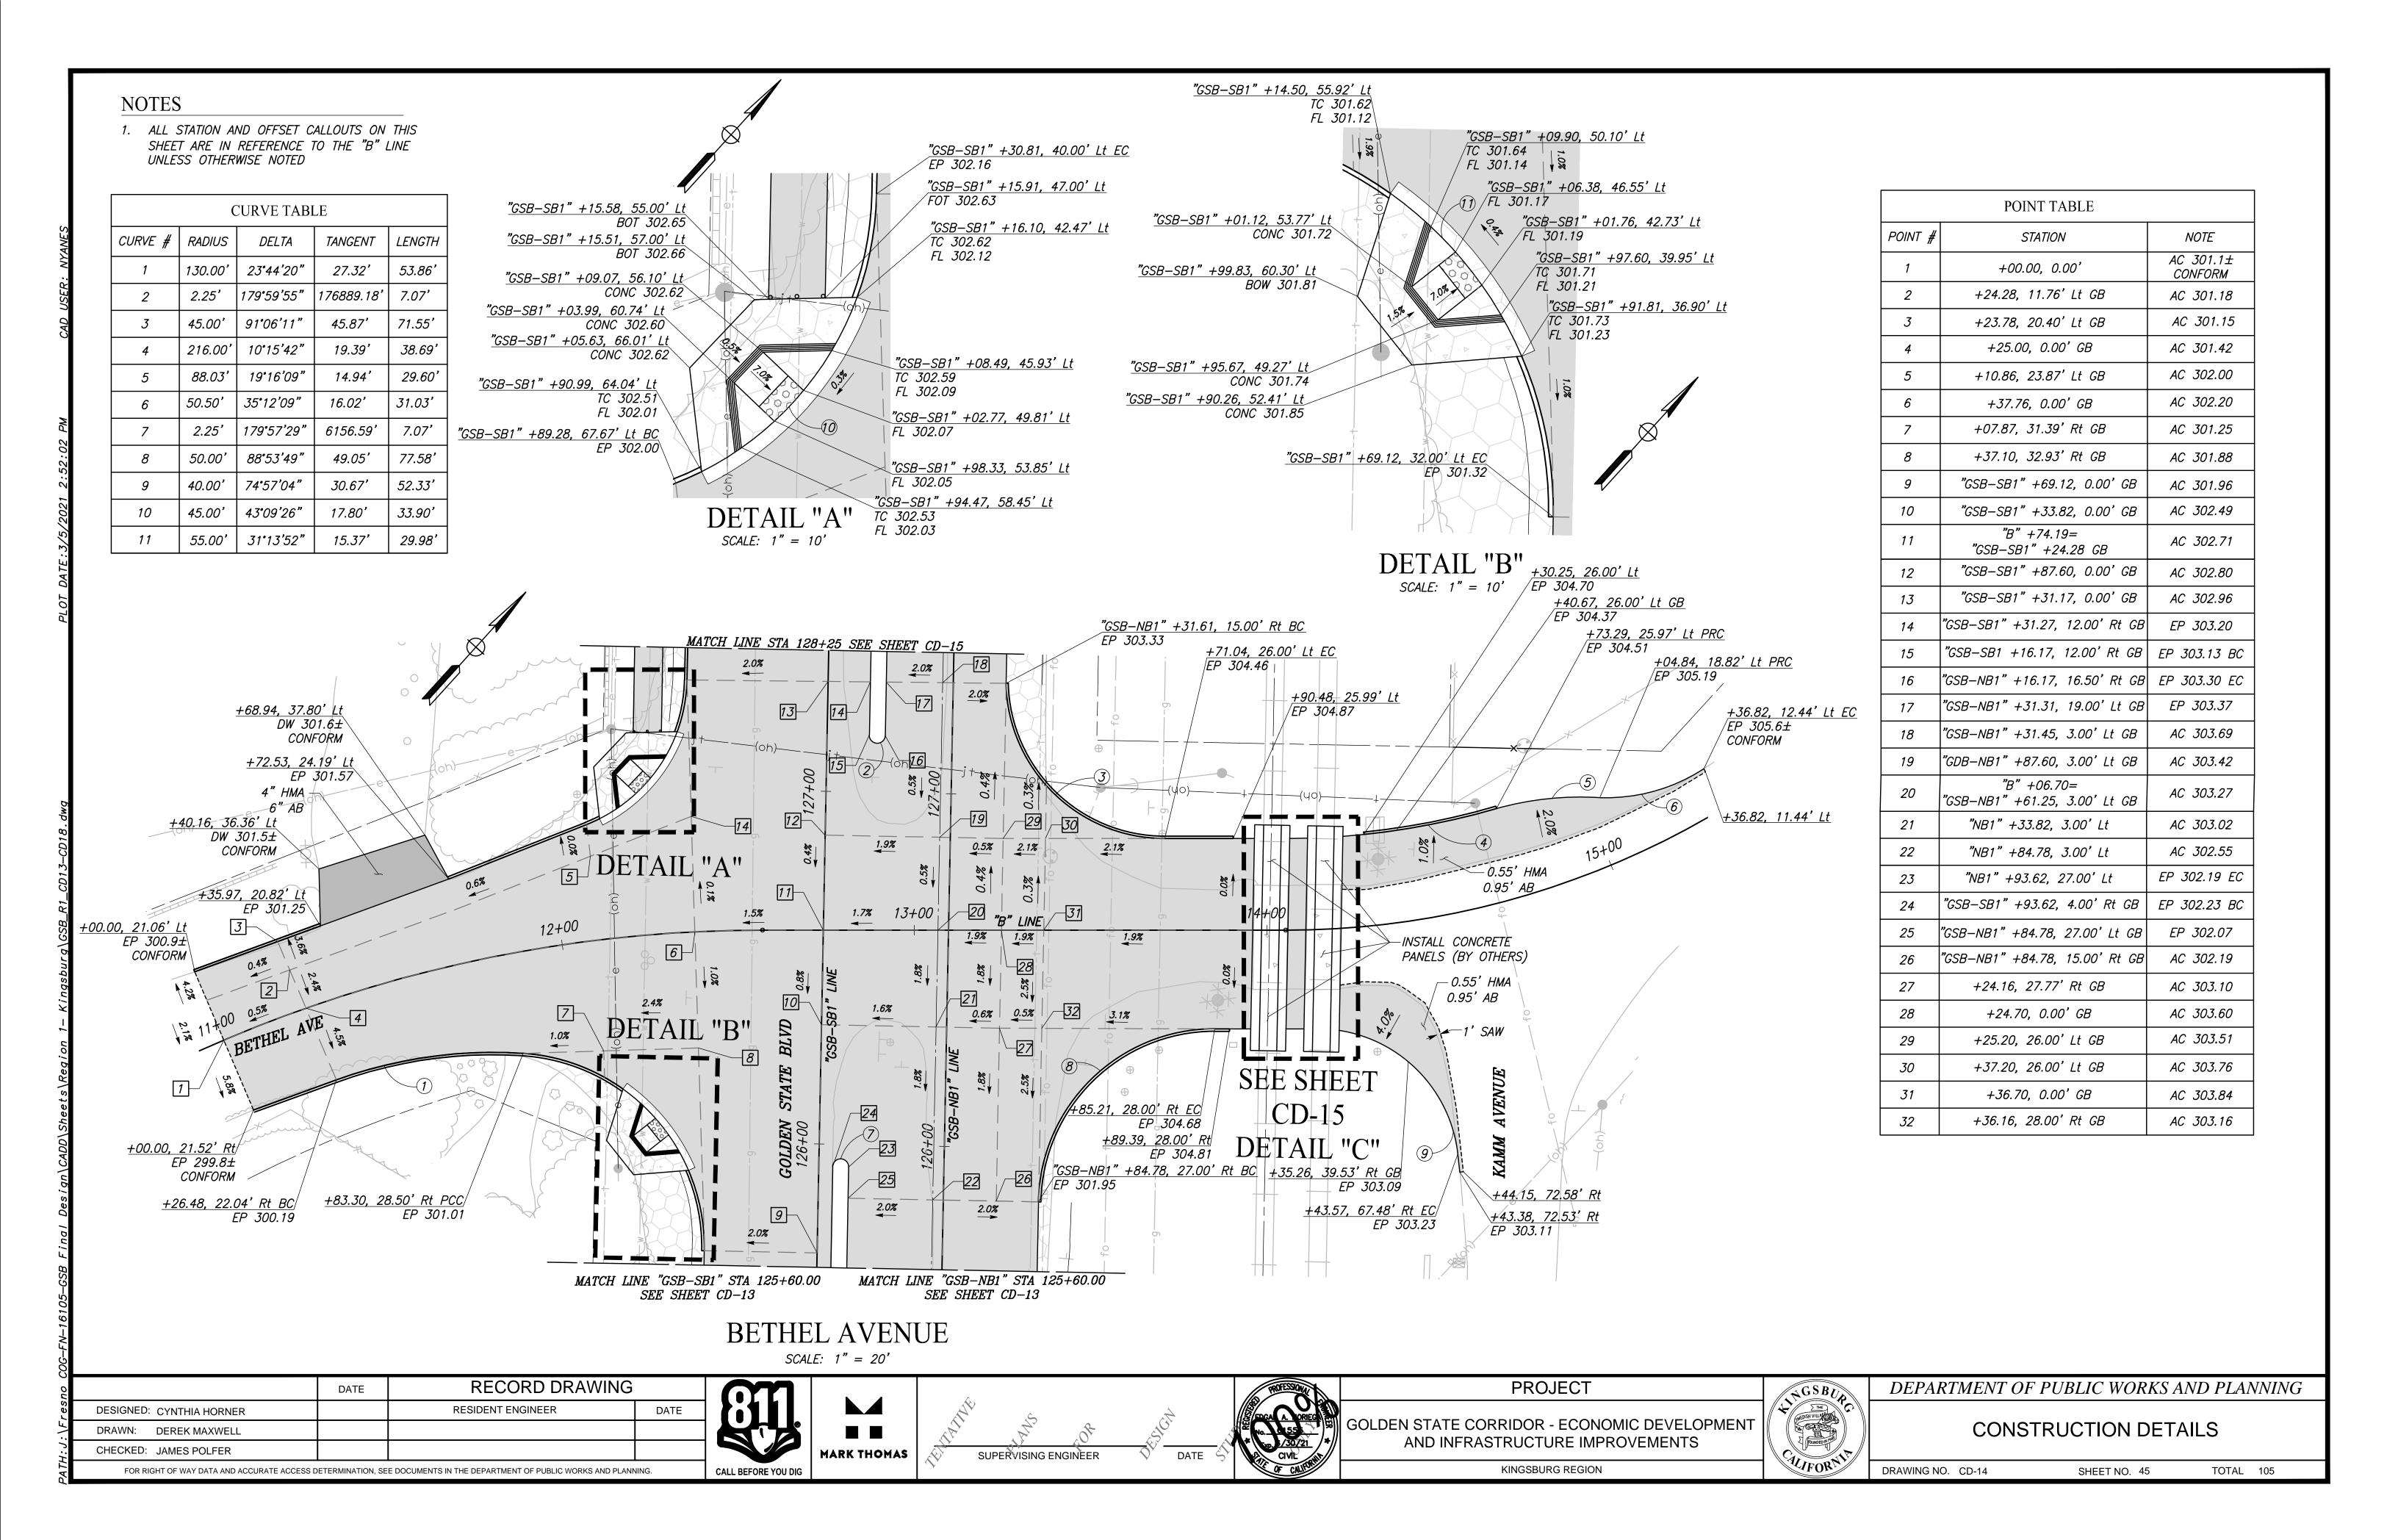

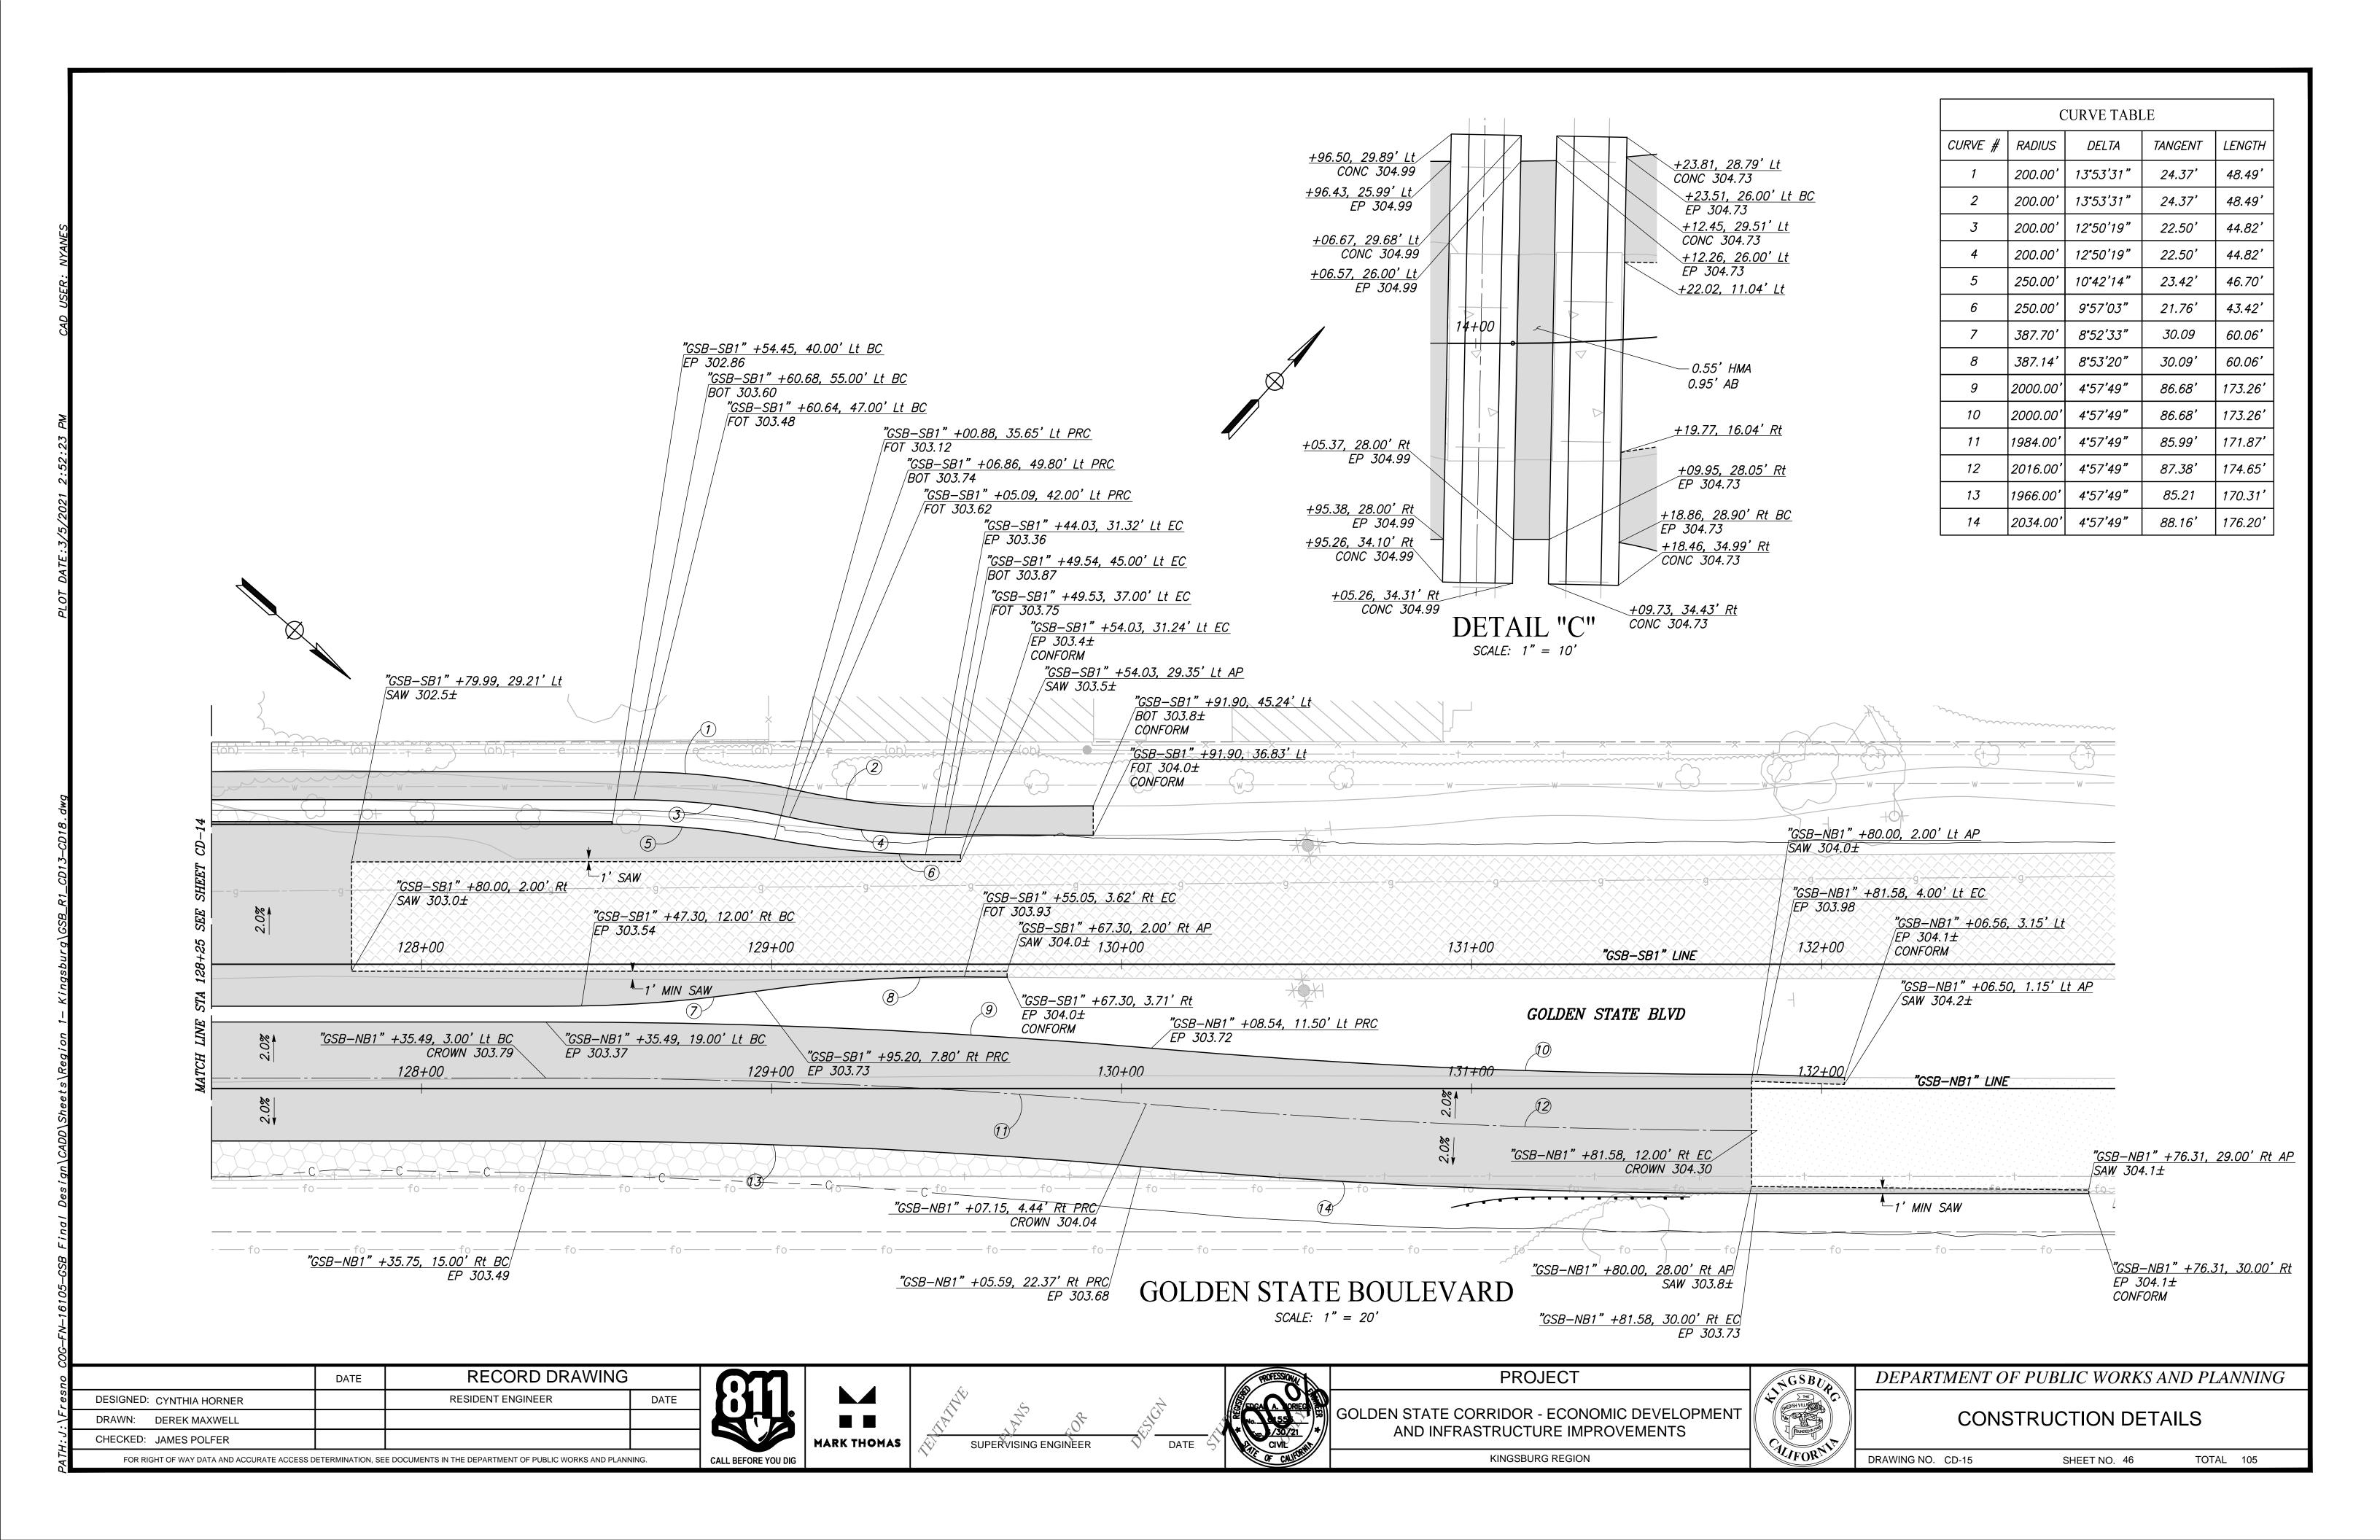

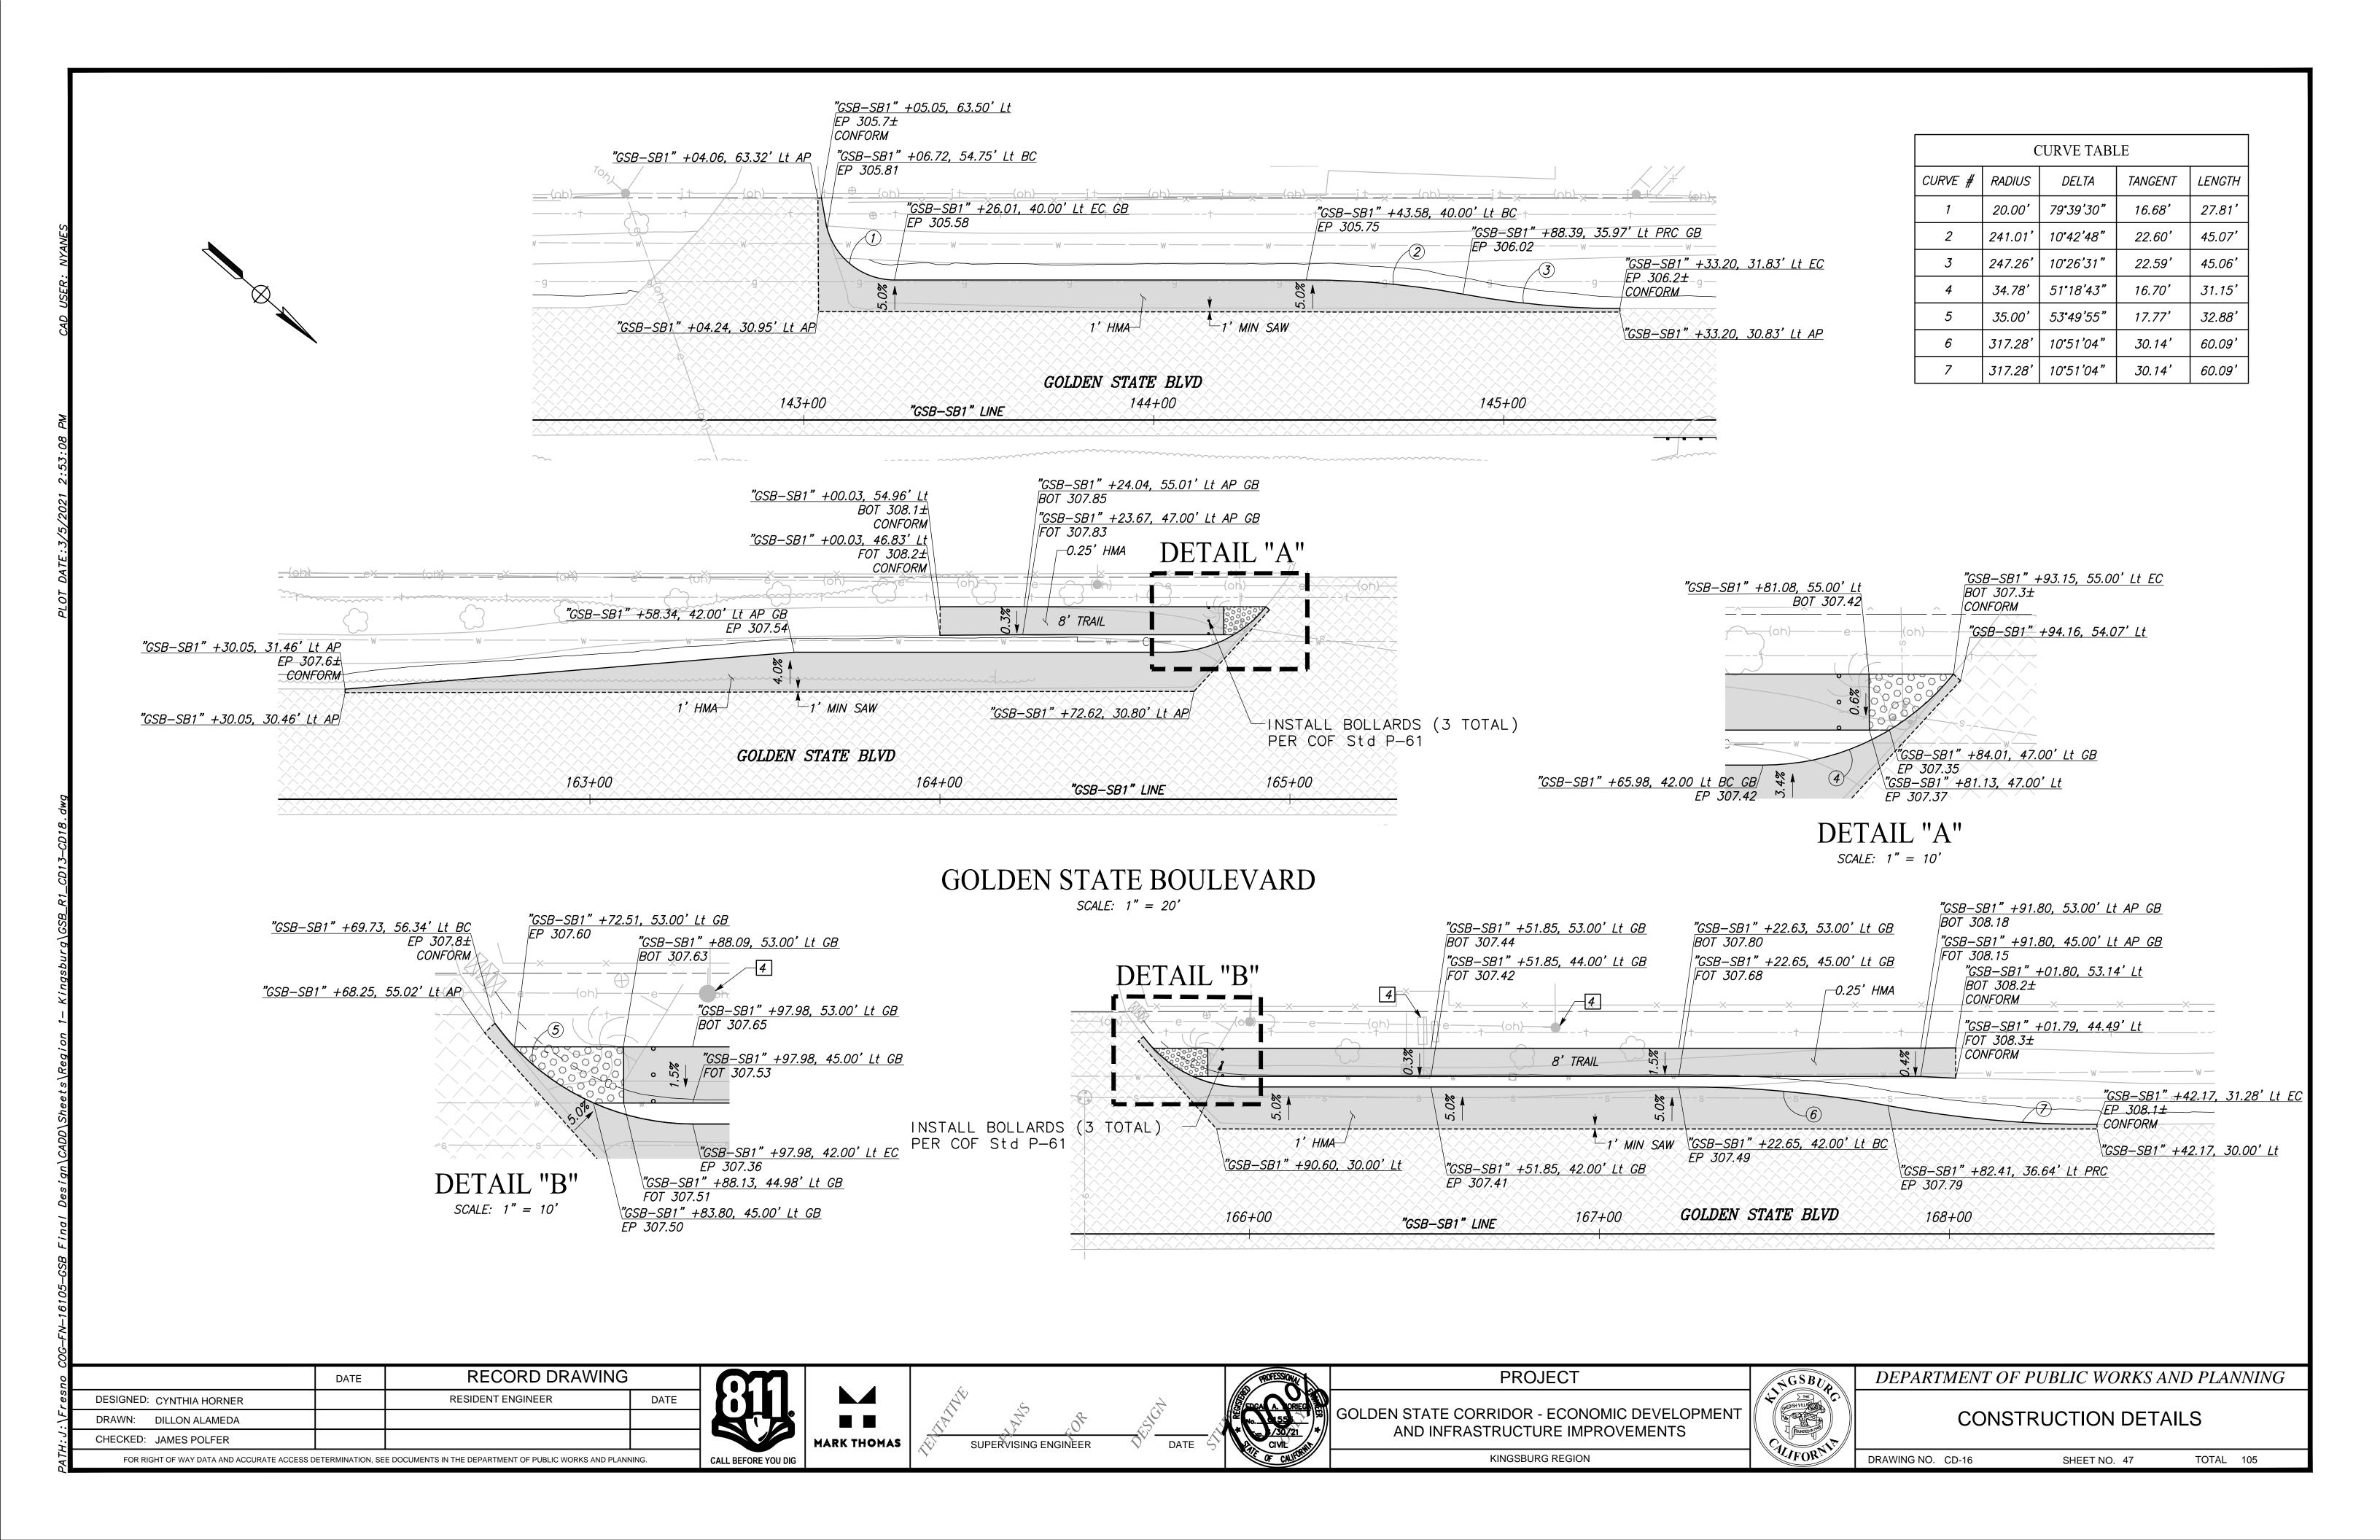


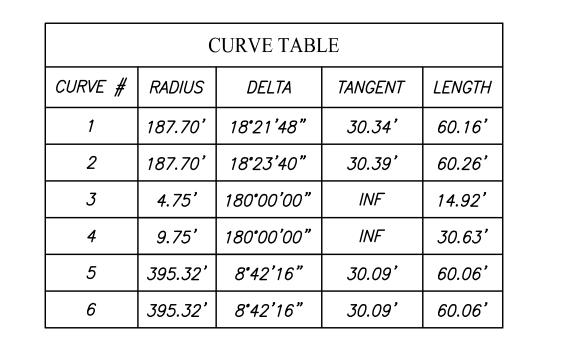

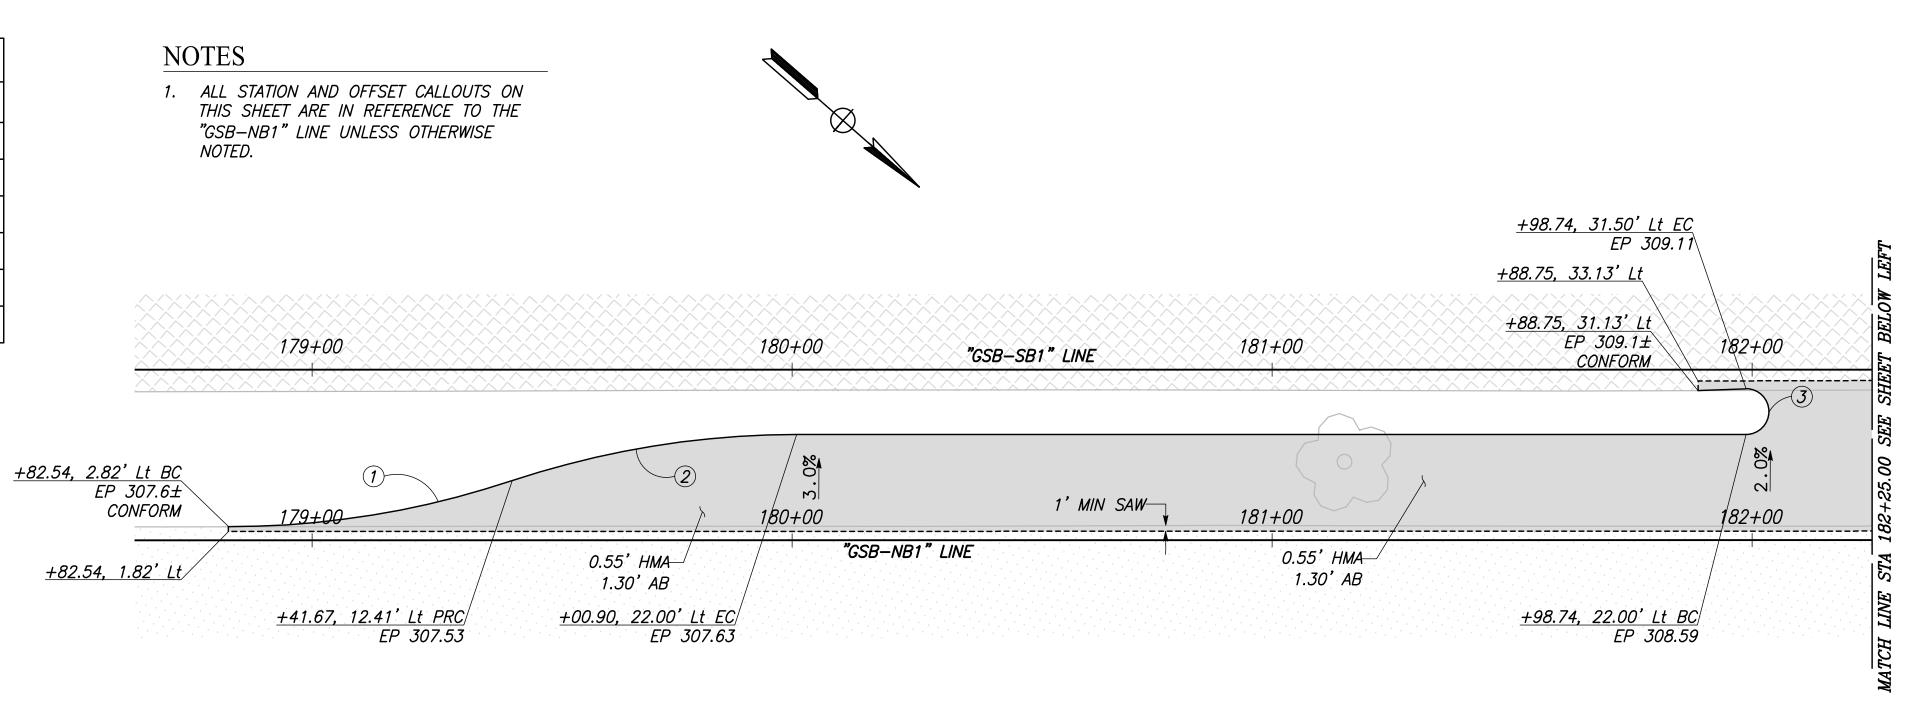

GOLDEN STATE BOULEVARD

SCALE: 1" = 20'

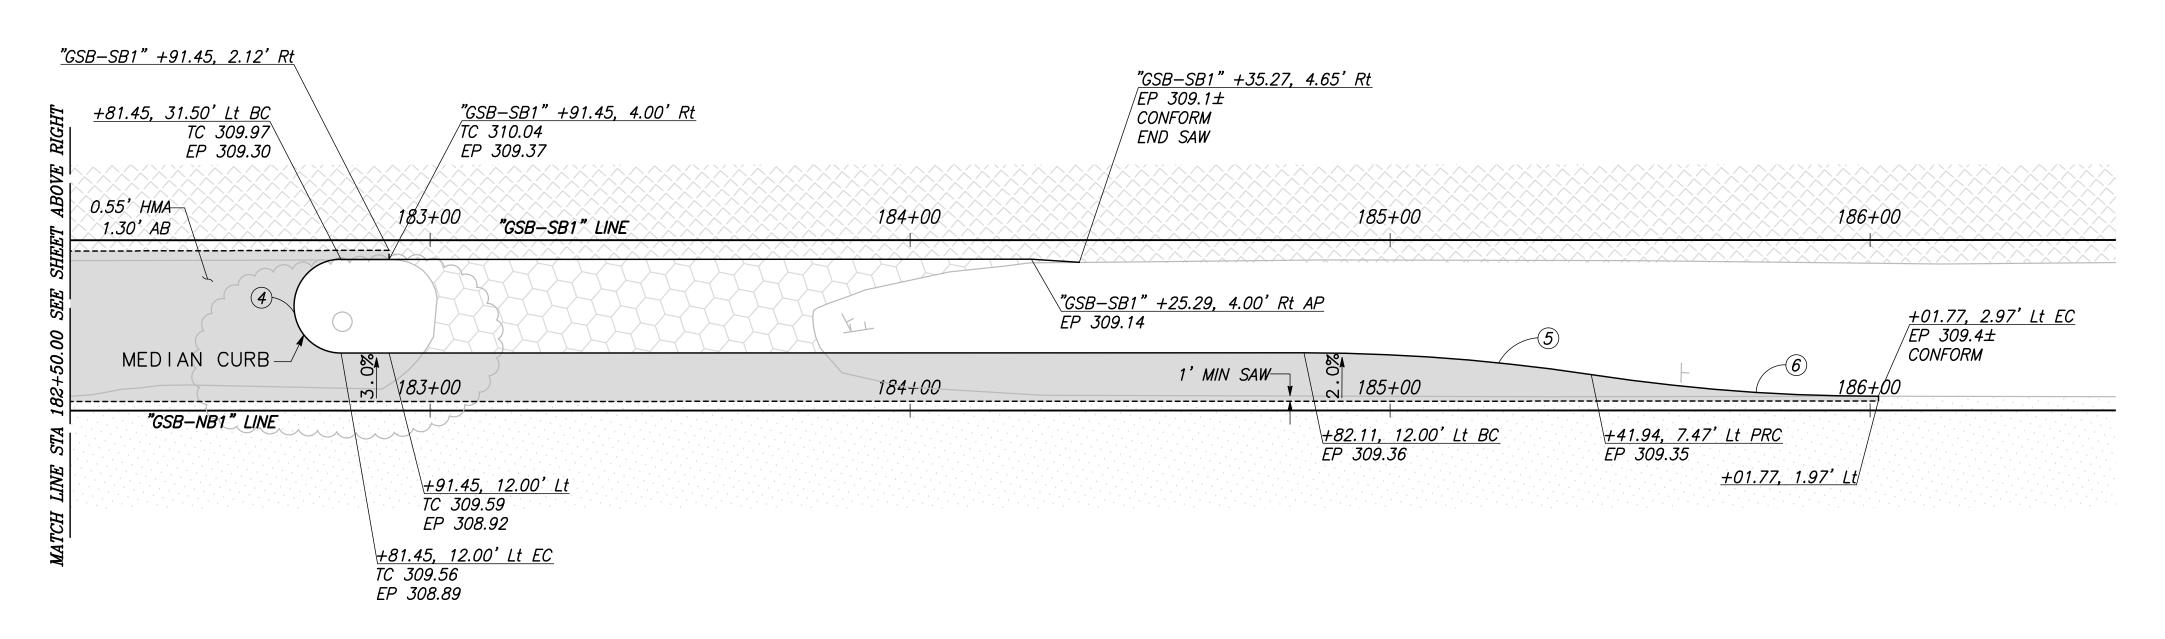



GOLDEN STATE BOULEVARD

SCALE: 1" = 20'

	DATE	RECORD DRAWING		
DESIGNED: CYNTHIA HORNER		RESIDENT ENGINEER	DATE	
DRAWN: DEREK MAXWELL				
CHECKED: JAMES POLFER				
FOR RIGHT OF WAY DATA AND ACCURATE ACCESS DETERMINATION, SEE DOCUMENTS IN THE DEPARTMENT OF PUBLIC WORKS AND PLANNING.				



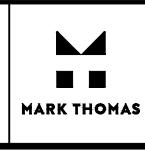

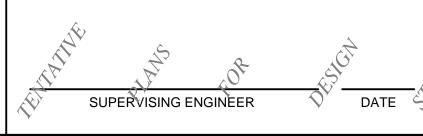



GOLDEN STATE CORRIDOR - ECONOMIC DEVELOPMENT AND INFRASTRUCTURE IMPROVEMENTS				
KINGSBURG REGION				


PROJECT

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DEPARTMENT OF PUBLIC WORKS AND PLANNING

CONSTRUCTION DETAILS

DRAWING NO. CD-17 SHEET NO. 48 TOTAL 105

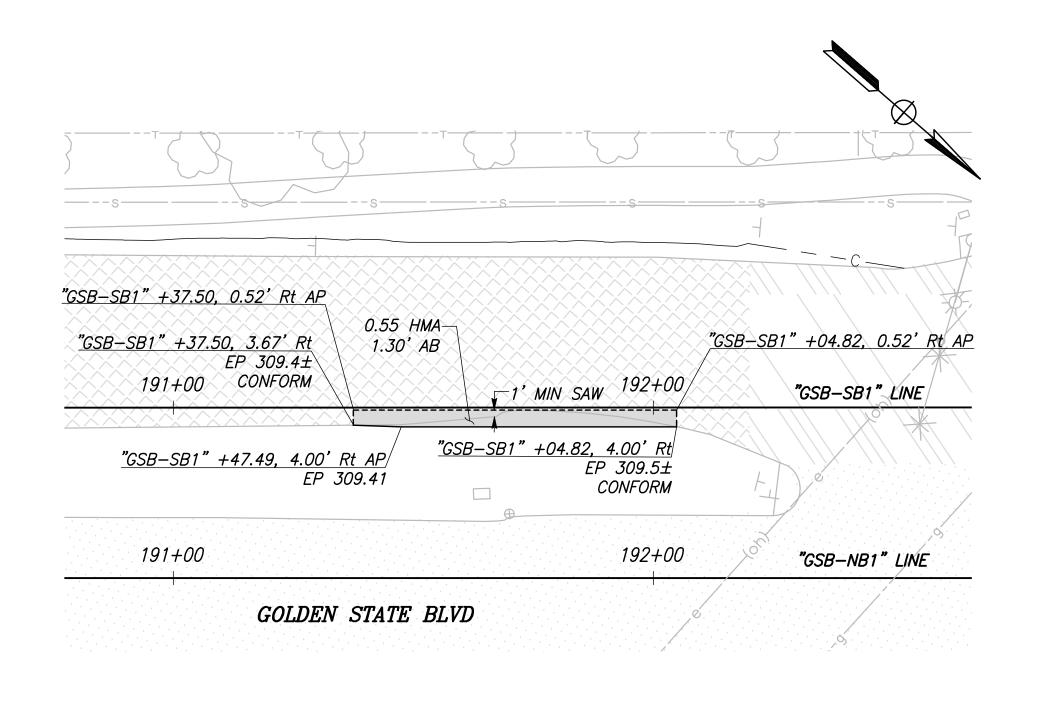


CURVE TABLE CURVE # | RADIUS | TANGENT LENGTH DELTA *21.73*′ *38.18*′ *32.00'* | *68*22'04"* 22.63' *45.08*' | 214.29' | 12**'**03'16" | 227.26' | 11°21'50" 22.61 *45.07*′ 5.00' 155°43'08" 23.24 13.59 135.00' 24°16'52" 29.04 57.21

<u>"GSB-SB2" +51.12, 51.40' Lt</u> FL 308.36 <u>"GSB-SB2" +47.90, 55.91' Lt</u> TC 308.83 FL 308.33 <u>"GSB-SB2" +45.65, 61.19' Lt BC</u> Elev 308.3± <u>"GSB-SB2" +56.45, 56.20' Lt</u> CONFORM CONC 308.88 "GSB-SB2" +59.13, 53.23' Lt CONC 308.90 <u>"GSB-SB2" +45.92, 60.00' Lt</u> TC 308.81 <u>"GSB-SB2" +63.23, 60.00' Lt</u> FL 308.31 /BOW 309.00 "GSB-SB2" +41.97, 59.58' Lt AP <u>"GSB-SB2" +53.93, 48.55' Lt</u> FL 308.37 <u>"GSB-SB2" +58.78, 45.05' Lt</u> TC 308.90 FL 308.40 *"GSB-SB2" +63.23, 42.94' Lt* DETAIL "A" TC 308.92


SCALE: 1" = 10'


GOLDEN STATE BOULEVARD SCALE: 1" = 20'

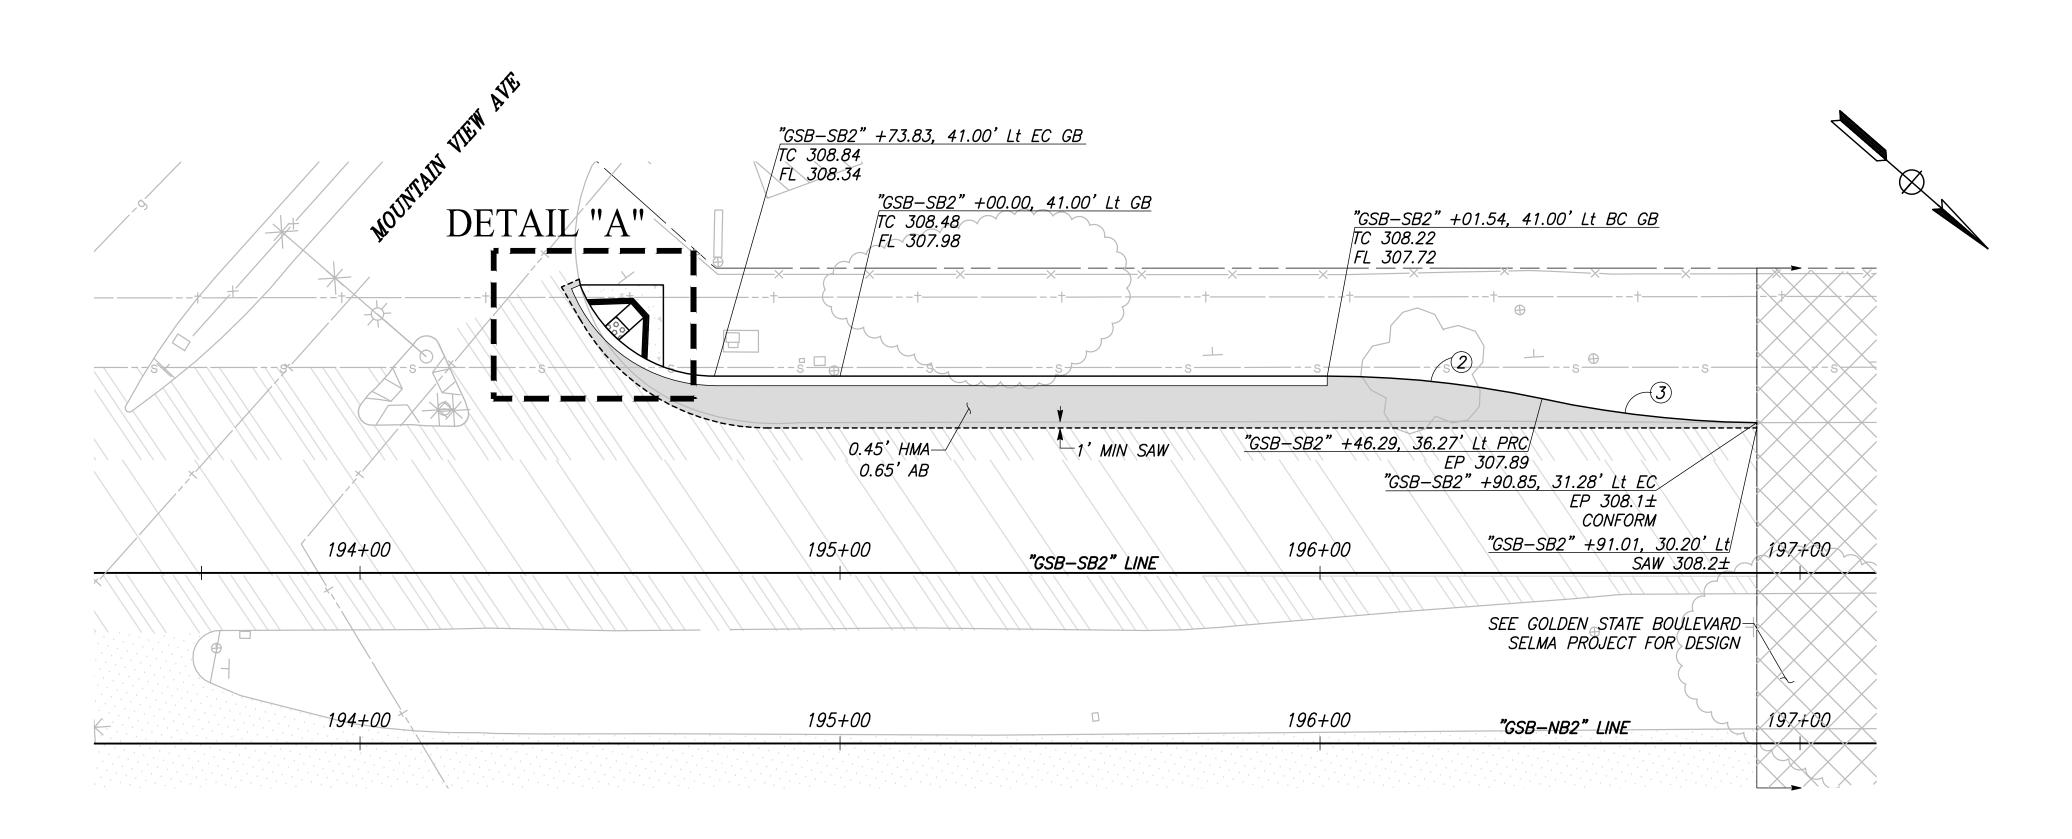

	DATE	RECORD DRAWING	
DESIGNED: CYNTHIA HORNER		RESIDENT ENGINEER	DATE
DRAWN: DEREK MAXWELL			
CHECKED: JAMES POLFER			
FOR RIGHT OF WAY DATA AND ACCURATE ACCESS	DETERMINATION, SE	EE DOCUMENTS IN THE DEPARTMENT OF PUBLIC WORKS AND PLANI	NING.



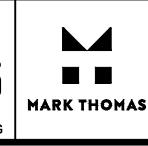

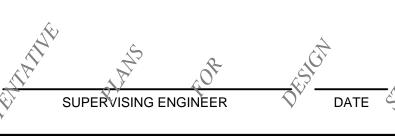



GOLDEN STATE CORRIDOR - ECONOMIC DEVELOPMENT AND INFRASTRUCTURE IMPROVEMENTS KINGSBURG REGION

PROJECT





FL 308.42


DEPARTMENT OF PUBLIC WORKS AND PLANNING

CONSTRUCTION DETAILS

DRAWING NO. CD-18 SHEET NO. 49 TOTAL 105

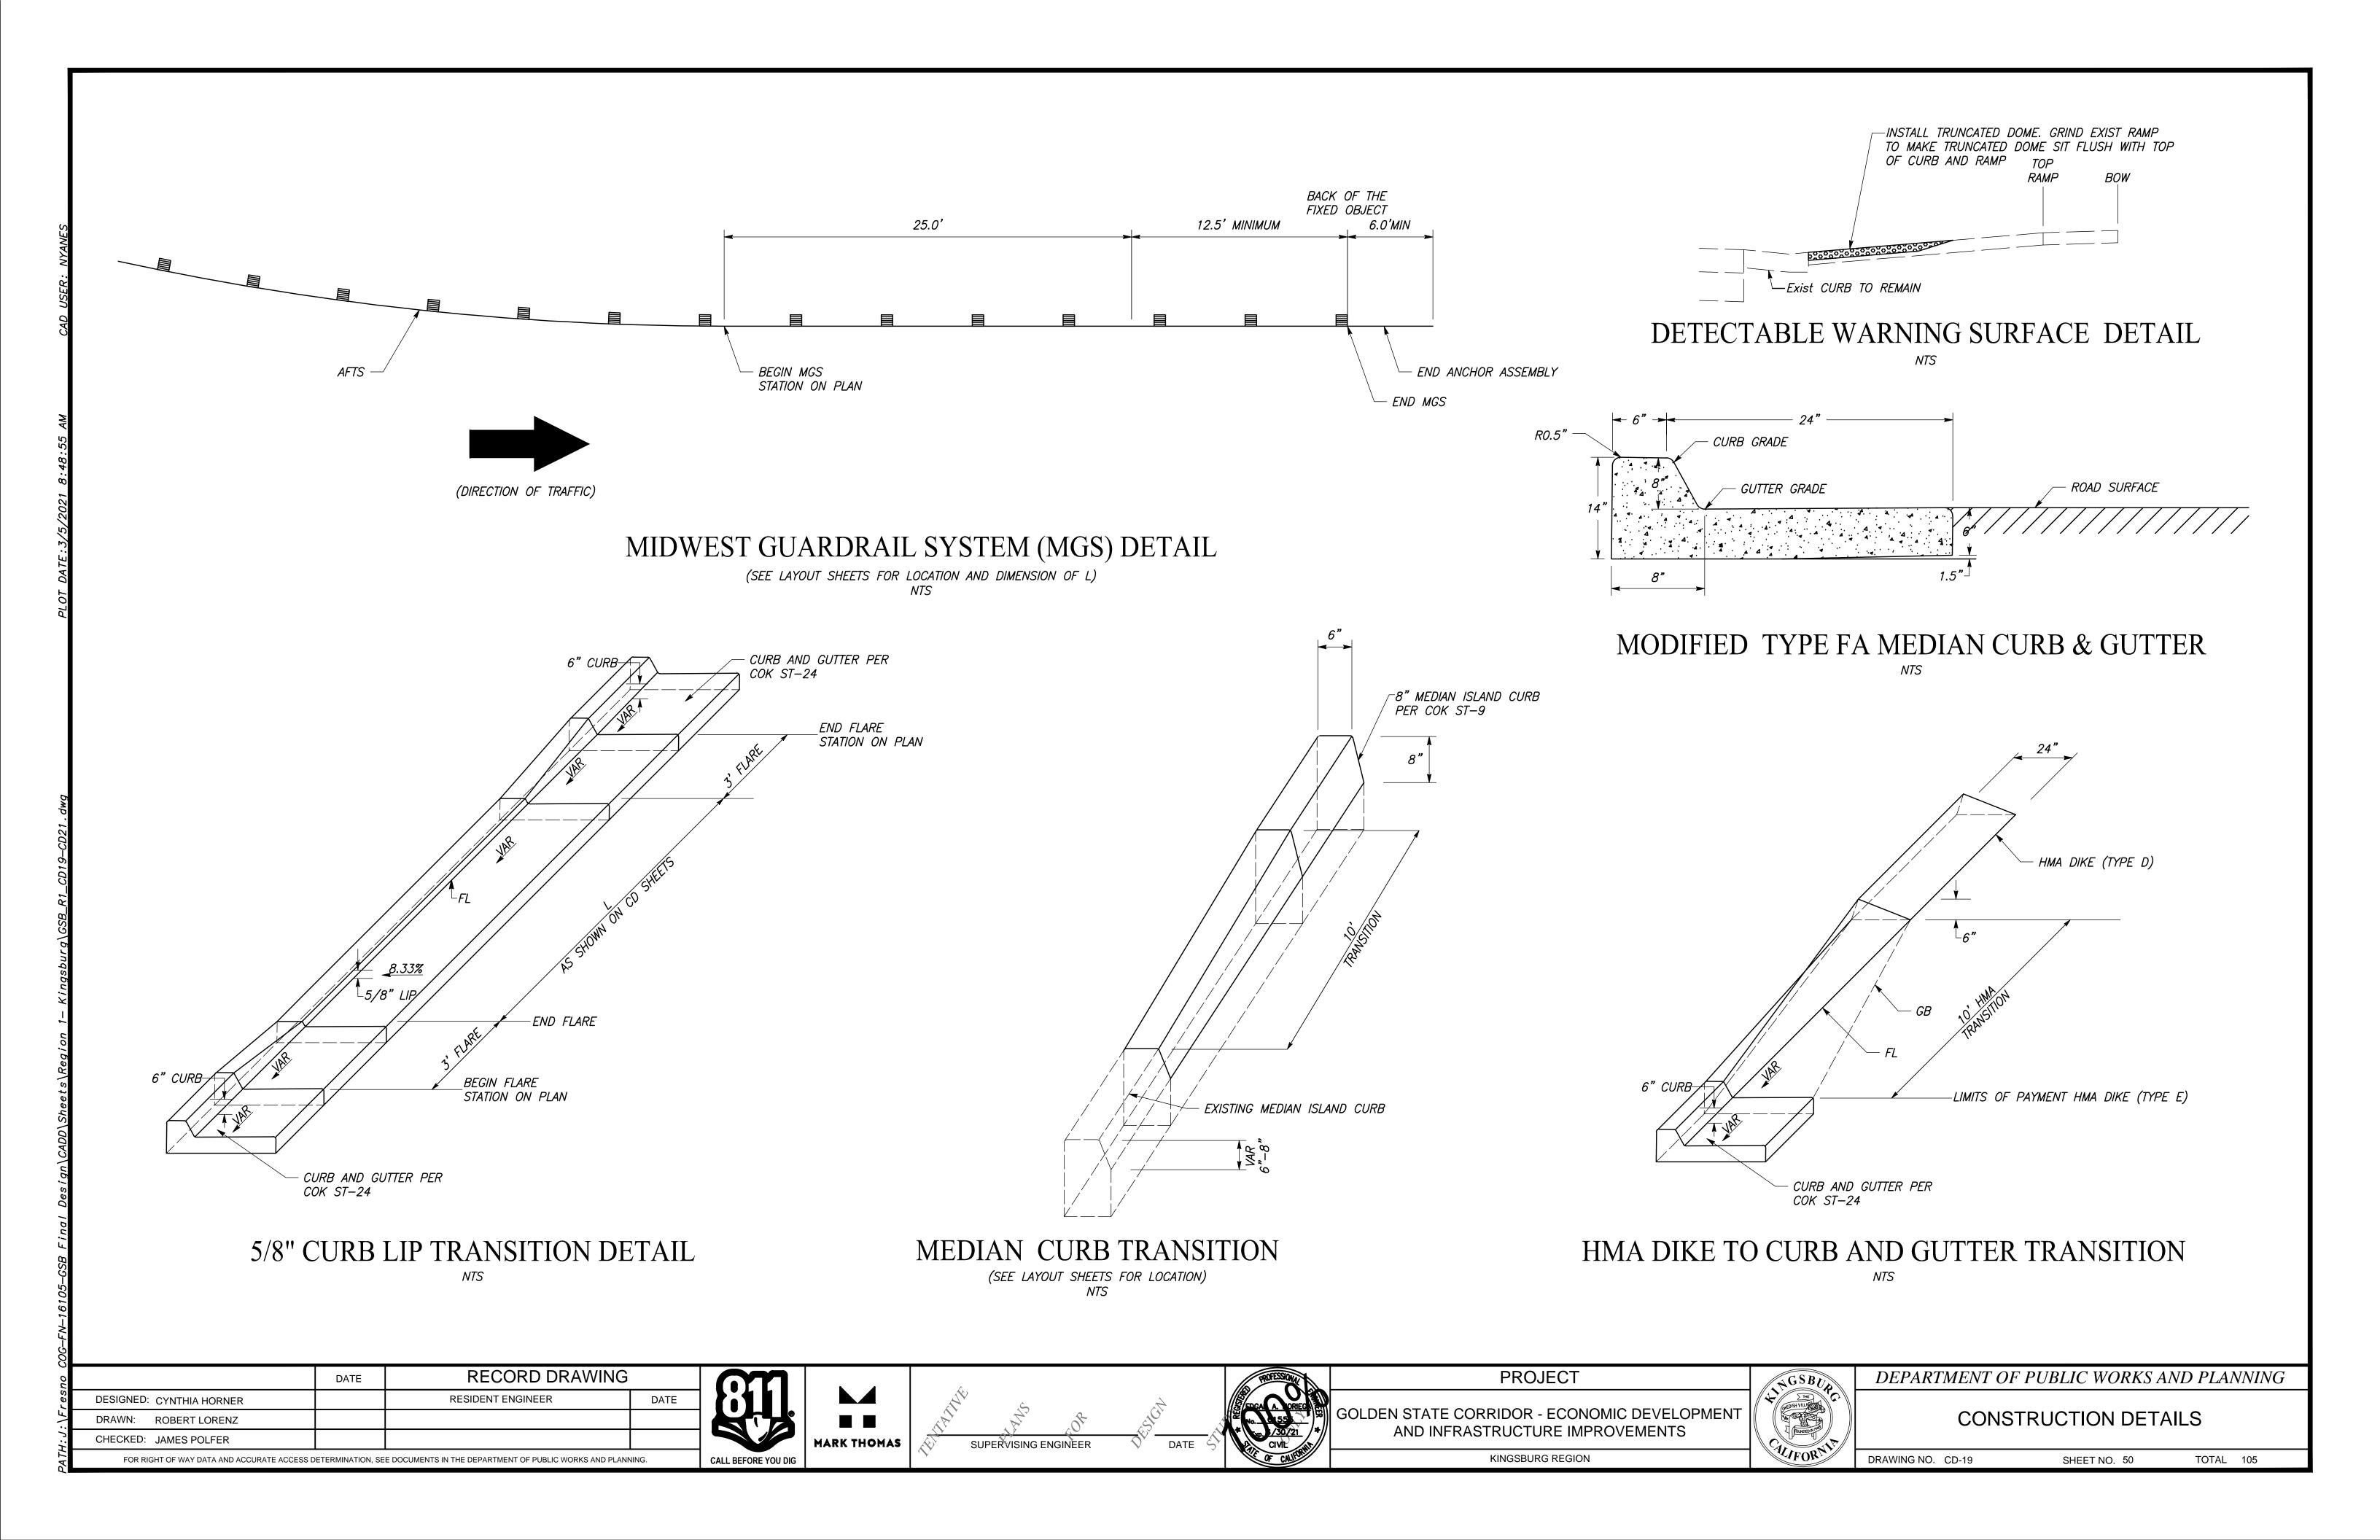


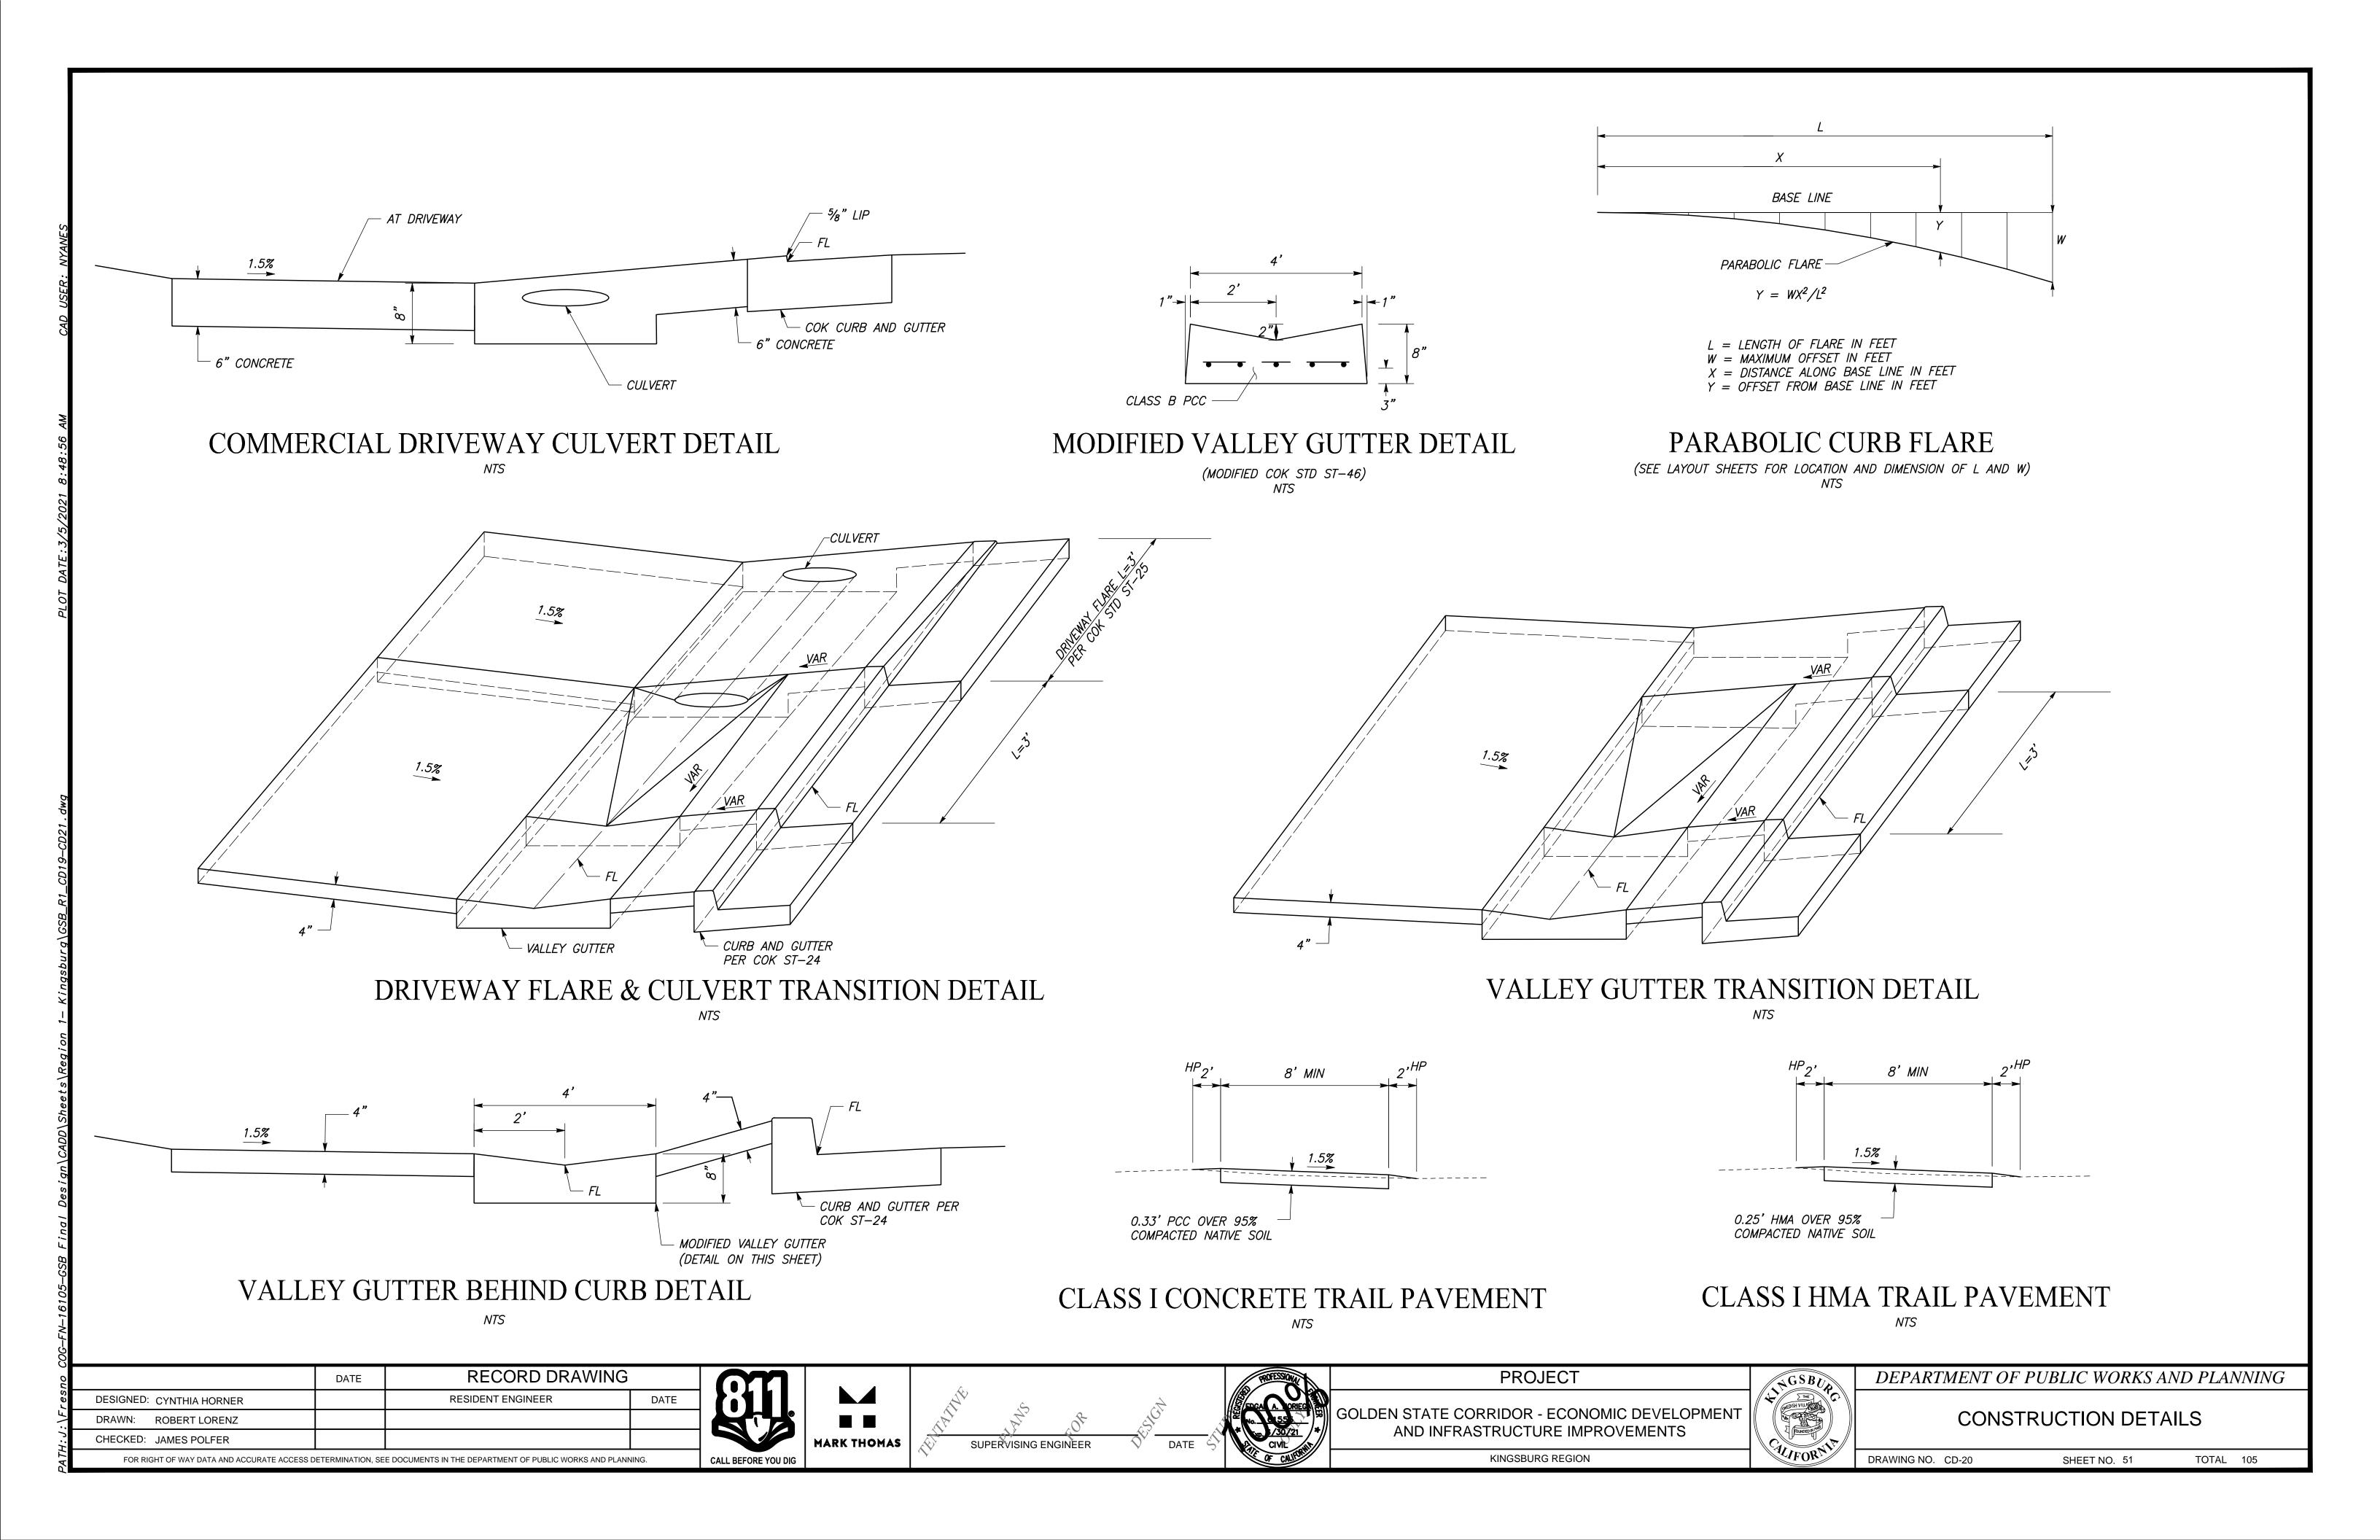

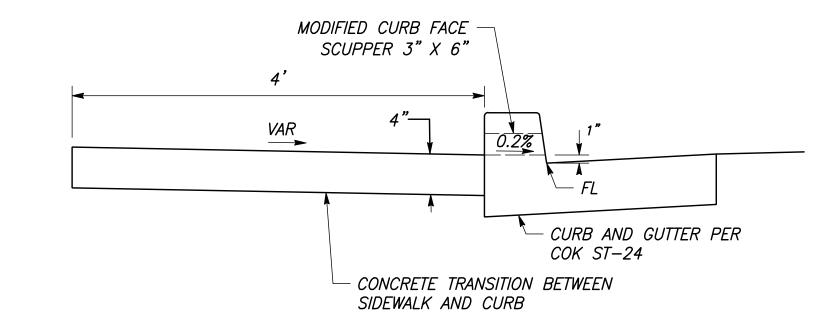



SECTION A

NTS

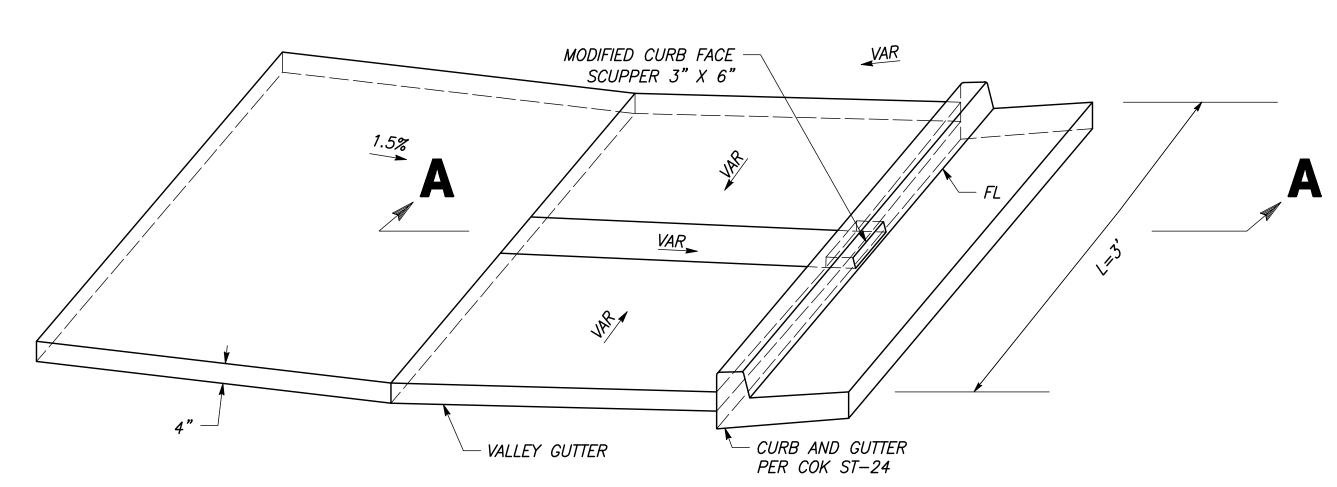

MODIFIED CURB FACE SCUPPER DETAIL

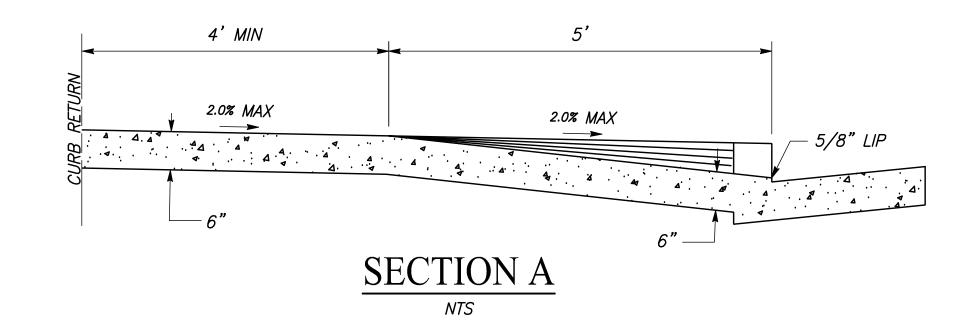


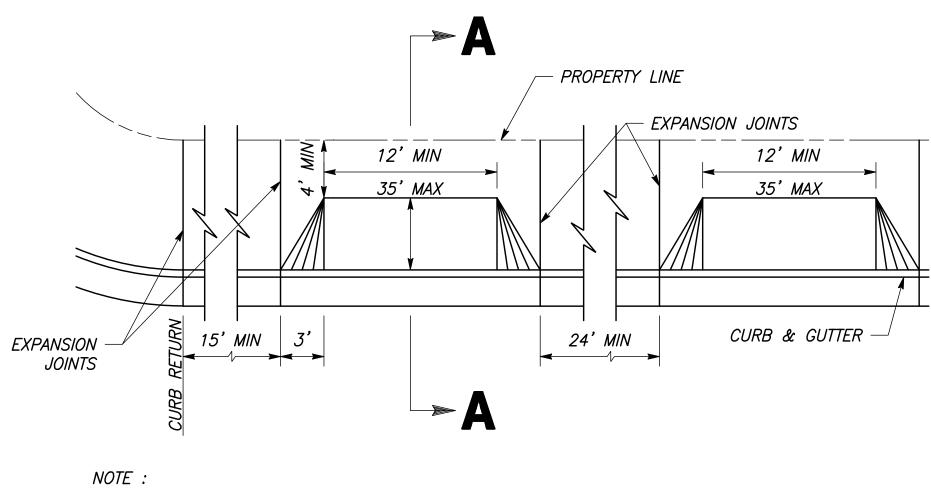



DRIVEWAYS SHALL NOT OCCUPY MORE THAN 40% OF LOT FRONTAGE.

MODIFIED COMMERCIAL DRIVE APPROACH

	DATE	RECORD DRAWING			
DESIGNED: CYNTHIA HORNER		RESIDENT ENGINEER	DATE		
DRAWN: ROBERT LORENZ				1	
CHECKED: JAMES POLFER				'	
FOR RIGHT OF WAY DATA AND ACCURATE ACCESS DETERMINATION. SEE DOCUMENTS IN THE DEPARTMENT OF PUBLIC WORKS AND PLANNING					

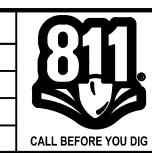

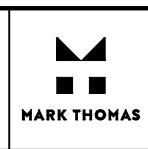

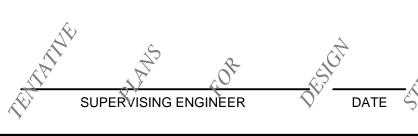



GOLDEN STATE CORRIDOR - ECONOMIC DEVELOPMENT AND INFRASTRUCTURE IMPROVEMENTS

KINGSBURG REGION

PROJECT



DEPARTMENT OF PUBLIC WORKS AND PLANNING

CONSTRUCTION DETAILS

DRAWING NO. CD-21 SHEET NO. 52 TOTAL 105