
PLANS FOR CONSTRUCTION

GOLDEN STATE BOULEVARD - SELMA REGION FROM MOUNTAIN VIEW AVE TO DeWOLF AVE

PROJECT LENGTH 4.71 MI.

INDEX OF SHEETS

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141 TO 152	IP-1 TO IP-12	IRRIGATION PLAN
153	ID-1	IRRIGATION DETAILS
154	ID -2	MWELO DATA

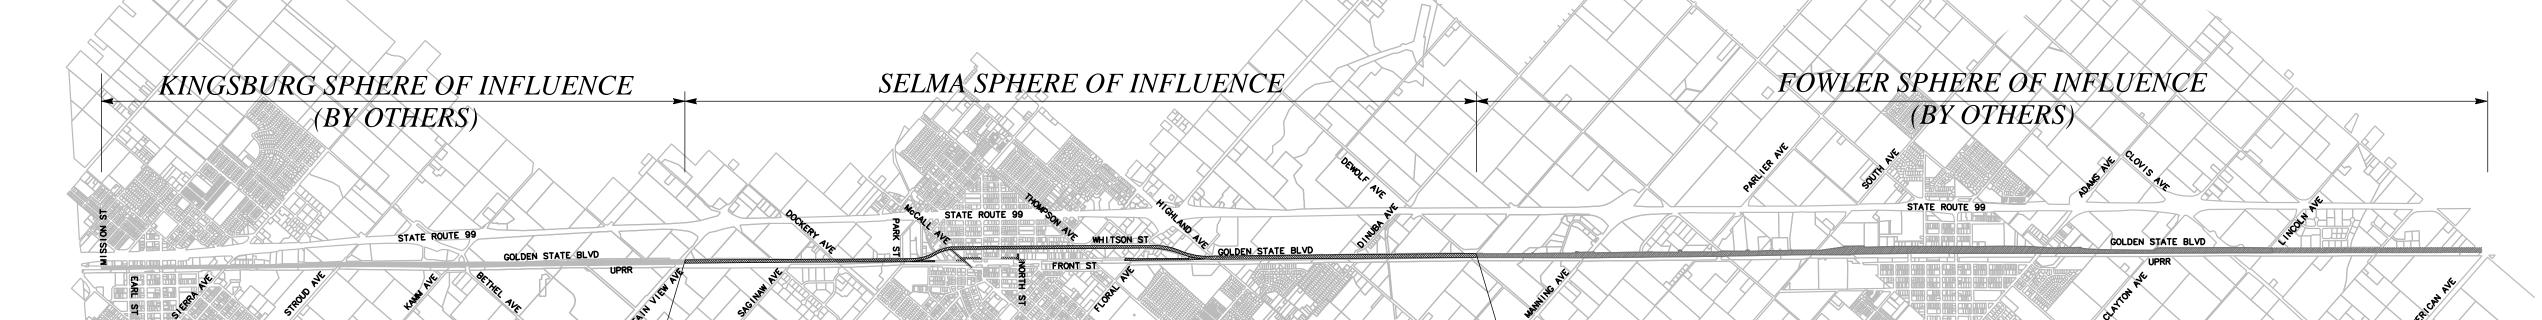

BEG LIMITS OF WORK STA "GSB-NB2" 193+36.75

END LIMITS OF WORK STA "GSB-NB3" 442+00.00 Adopted by the County of Fresno Board of Supervisors

1st District Brian Pacheco Vice Chairman 3rd District Sal Quintero Andreas Borgeas 2nd District **Buddy Mendes** Nathan Magsig

APPROVED_


Steven E. White, Director Department of Public Works, County of Fresno

APPROVED_

Shane Ferrell, Director Department of Public Works, City of Selma

	CONTR	ACTOR'S LICE	NSING REQUIR	EMENT	
	CL	ASS A, GENER	AL ENGINEERI	NG	
	С	-12, EARTHWC	RK AND PAVIN	G	
Drawing No.	Road No.	Bridge No.	Fiscal Yr.	Sheet No.	Total
####	XXXXXX	XXXXX	xxxx	1	144
		Contract	No. ####		
		RECORD	DRAWING		
NAME					
ADDRESS					
CITY STATE ZIP					
PHONE					
DATE AWARDED					
DATE STARTED					
DATE COMPLETED					
		RESIDENT	ENGINEER		
NAME		SIGN	IATURE		
NAME		SIGN	IATURE		

100% SUBMITTAL

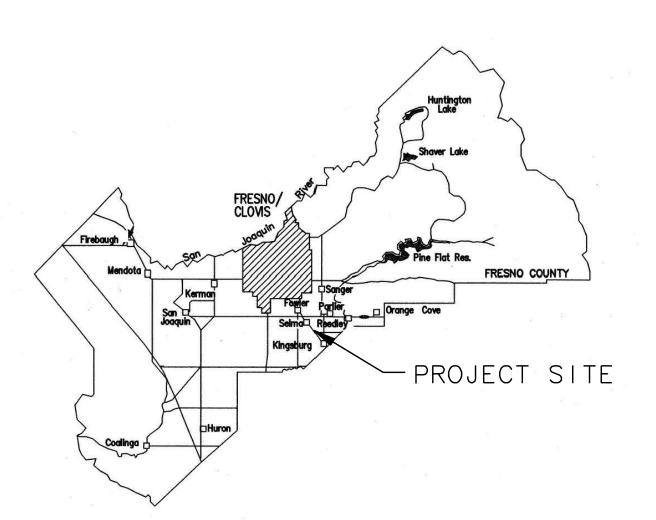

3000 ft 6000 ft

DEPARTMENT OF PUBLIC WORKS AND PLANNING

STANDARD PLANS LIST

APPLICABLE 2015 STATE OF CALIFORNIA CALTRANS STANDARD PLANS:

ABBREVIATIONS, LINES, SYMBOLS, AND LEGEND

ABBREVIATIONS (SHEET 1 OF 3) \Box A3B ABBREVIATIONS (SHEET 2 OF 3)
ABBREVIATIONS (SHEET 3 OF 3)

LEGEND - LINE'S AND SYMBOL'S (SHEET 1 OF 5) □ RSP A10B LEGEND - LINES AND SYMBOLS (SHEET 2 OF 5) LEGEND — LINES AND SYMBOLS (SHEET 3 OF 5) □ *A10D* LEGEND — LINES AND SYMBOLS (SHEET 4 OF 5) LEGEND — LINES AND SYMBOLS (SHEET 5 OF 5)

CONCRETE PIPE - DIRECT DESIGN METHOD

□ *D79* PRECAST REINFORCED CONCRETE PIPE - DIRECT DESIGN METHOD PRECAST REINFORCED CONCRETE PIPE - DIRECT DESIGN METHOD \Box D79A

FLARED END SECTIONS

□ *A10E*

METAL AND PLASTIC END FLARED SECTIONS

TEMPORARY CRASH CUSHIONS, RAILING AND TRAFFIC SCREEN

TEMPORARY CRASH CUSHION, SAND FILLED (UNDIRECTIONAL) \Box T1B TEMPORARY CRASH CUSHION, SAND FILLED (BIDIRECTIONAL) \Box T2 TEMPORARY CRASH CUSHION, SAND FILLED (SHOULDER INSTALLATIONS) \Box T3A

TEMPORARY RAILING (TYPE K) \Box T3B TEMPORARY RAILING (TYPE K)

ROADSIDE SIGNS

□ *ST*−*9*

 \square ST-14

□ *RS1* ROADSIDE SIGNS - TYPICAL INSTALLATION DETAILS NO. 1 □ *RS2* ROADSIDE SIGNS — WOOD POST — TYPICAL INSTALLATION DETAILS NO 2. ROADSIDE SIGNS - TYPICAL INSTALLATION DETAIL NO. 4 \square RS4

APPLICABLE 2016 COUNTY OF FRESNO STANDARD PLANS:

□ *ST45* 30° PARKING LAYOUT

APPLICABLE 2015 CITY OF SELMA STANDARD PLANS:

CONSTRUCTION DETAILS FOR CONCRETE SIDEWALK \Box ST-2 CONCRETE CONSTRUCTION DETAILS □ *ST*−*3* CURB RAMP (TYPE 1) □ *ST*−4 CURB RAMP (TYPE 2) □ *ST*−*5* CURB RAMP (TYPE 3) □ *ST*−*6* DRIVEWAY APPROACH 5' SIDEWALK PATTERN □ *ST*−*7* COMMERCIAL DRIVEWAY APPROACH 10' CURB PATTERN

CENTER ISLAND TURNOUT FOR ONE WAY LEFT TURNS

CONCRETE VALLEY GUTTER

ACCESSIBLE FACILITIES DETAIL

GENERAL NOTES

- THE WORK EMBRACED HEREIN SHALL BE DONE IN ACCORDANCE WITH THE APPROPRIATE PROVISIONS OF THE SPECIFICATIONS ENTITLED COUNTY OF FRESNO, STANDARD SPECIFICATIONS, LATEST EDITION, INSOFAR AS THE SAME MAY APPLY, WHICH SPECIFICATIONS HEREINAFTER ARE REFERRED TO AS THE STANDARD SPECIFICATION.
- TWO WORKING DAYS PRIOR TO COMMENCING EXCAVATION, THE CONTRACTOR SHALL NOTIFY UNDERGROUND SERVICES ALERT. TOLL FREE. AT 1-800-227-2600 OR 811.
- CONTRACTOR SHALL PROVIDE THE ENGINEER WITH A COPY OF AN OWNER'S WRITTEN AUTHORIZATION AND/OR SIGNED USE AGREEMENT PRIOR TO THE START OF WORK FOR ANY TEMPORARY WORK AREA, STANDING AREA, OR EQUIPMENT STORAGE FACILITIES TO BE USED FOR THIS PROJECT. AT THE COMPLETION OF WORK, THE CONTRACTOR SHALL PROVIDE THE ENGINEER WITH A COPY OF A WRITTEN RELEASE LETTER STATING THAT ALL TEMPORARY USES FACILITIES HAVE BEEN RESTORED BACK TO THE OWNER'S SATISFACTION.
- CONTRACTOR SHALL DETERMINE THE EXACT LOCATION OF ALL UNDERGROUND FACILITIES AND PROVIDE PROTECTION PRIOR TO AND DURING CONSTRUCTION.
- IN THE EVENT OVERHEAD ELECTRICAL LINES EXIST WITHIN THE LIMITS OF CONSTRUCTION, MAINTAIN PROPER CLEARANCE. CONTACT PG&E TO VERIFY WIRE LOCATION.
- THE SANITARY SEWER SYSTEM AND HOUSE CONNECTIONS, TOGETHER WITH WATER MAIN, GAS MAINS, AND THEIR RESPECTIVE SERVICE CONNECTIONS SHALL BE COMPLETE IN THE STREET BEFORE INSTALLATION OF THE STREET SURFACING.
- INSTALL SIDEWALKS, CURBS, AND GUTTERS AS PER CITY OF SELMA STANDARD DRAWINGS ST-1 AND ST-2 AND IN ACCORDANCE WITH DETAILS ON THESE DRAWINGS. CURBS AND GUTTERS SHALL BE CONSTRUCTED BEFORE PLACING THE STREET SURFACING AND BASE COURSE.
- PERMITS MUST BE OBTAINED AND FEES PAID IN ACCORDANCE WITH ORDINANCES OF THE CITY OF SELMA.
- THE TYPICAL CROSS SECTION SHOWN SHALL BE USED ONLY FOR THE PAVEMENT STRUCTURAL SECTION, OVERLAY THICKNESS AND SIDE SLOPES. SEE PLAN AND PROFILE SHEETS FOR HORIZONTAL LIMITS AND LOCATIONS OF CURB AND GUTTER, MEDIAN ISLANDS, SAWCUTTING, GRINDING, OVERLAYS, SIDEWALKS, FENCES, R/W LINES. EXISTING FEATURES. AND ANY OTHER PROPOSED IMPROVEMENTS. THE TYPICAL CROSS SECTION SHOULD NOT BE USED FOR TAKING OF PROPOSED IMPROVEMENTS.
- 10. ALL STREETS SHALL BE SURFACED IN ACCORDANCE WITH THIS PLAN AND THE FOLLOWING SPECIFICATIONS:
 - A. 6-INCH SUBGRADE AND ALL FILLS IN EXCESS OF 6 INCHES WILL BE COMPACTED IN ACCORDANCE WITH THE STATE OF CALIFORNIA, DEPARTMENT OF TRANSPORTATION, SECTION 19 OF THE STANDARD SPECIFICATIONS, AUGUST 2015.
 - B. AGGREGATE BASE SHALL CONFORM TO AND BE PLACED IN ACCORDANCE WITH SECTION 11 OF THE CITY STANDARDS SPECIFICATIONS, USING CLASS 2 AGGREGATE BASE, AND AGGREGATE SUB-BASE SHALL UTILIZE CLASS 3 AGGREGATE SUB-BASE MATERIAL (MINIMUM 50 R-VALUE).
 - C. PAINT BINDER WILL BE AS SPECIFIED BY THE CITY ENGINEER AND SHALL CONFORM TO AND BE APPLIED IN ACCORDANCE WITH SECTION 11 OF THE CITY STANDARD SPECIFICATIONS.
 - D. ASPHALT CONCRETE SURFACING SHALL BE TYPE A USING PG 64-10 PENETRATION ASPHALT, CONFORMING TO AND PLACED IN ACCORDANCE WITH SECTION 11 OF THE CITY SPECIFICATIONS.
- ALL BOUNDARY STREETS SHALL BE CONSTRUCTED IN ACCORDANCE WITH THIS PLAN.
 - A. THE TRANSITION BETWEEN THE EDGE AND END OF THE REQUIRED STREET SURFACING AND THE EXISTING SURFACING OR GROUND SHALL NOT HAVE A SLOPE STEEPER THAN 5 PERCENT.
- INSTALL STREET LIGHTING SYSTEM IN ACCORDANCE WITH RESOLUTION No. 78-522 AND 88-229. LOCATION OF LIGHTS TO BE DETERMINED AND APPROVED BY THE TRAFFIC ENGINEER, SERVICE LOCATION TO BE DETERMINED BY PG&E. THE STREETLIGHTS SHALL BE INSTALLED IN ACCORDANCE WITH PUBLIC WORKS STANDARD E-1 THROUGH E-28, OR AS MODIFIED BY THESE PLANS. STREET LIGHTS ON BRIDGE WILL BE BARRIER MOUNTED PER CALTRANS STANDARD PLANS.
- 14. TRAFFIC REQUIREMENTS:
 - A. ALL SIGNING, DETOURING, AND BARRICADING SHALL CONFORM TO THE CALIFORNIA SUPPLEMENT TO THE MANUAL OF UNIFORM TRAFFIC CONTROL DEVICES DATED 2014, ISSUED BY THE STATE OF CALIFORNIA. DEPARTMENT OF TRANSPORTATION.
 - B. ALL SIGNS SHALL BE RETROFLECTIVE PER CHAPTER 2A.08 OF THE 2014 MUTCD.
 - C. HIGH LEVEL WARNING DEVICES SHALL BE USED ON ALL APPROACHES TO THE CONSTRUCTION AREA.
 - D. ONE (1) 12-FOOT DRIVING LANE MUST BE MAINTAINED IN EACH DIRECTION AT ALL TIMES.
 - E. NO PUBLIC STREET SHALL BE CLOSED WITHOUT PRIOR APPROVAL FROM THE CITY TRAFFIC ENGINEER.

- 15. EXISTING PAVEMENT SHALL NOT BE REMOVED UNTIL SUCH A TIME AS ALL UTILITIES ARE COMPLETED AND PAVING CONTRACTOR IS READY TO REPAIR WITHIN 5 DAYS.
- 16. ALL STORM DRAINAGE FACILITIES ARE TO BE COMPLETED PRIOR TO START OF STREET WORK AND IN ACCORDANCE WITH CITY OF SELMA 2015, CITY STANDARDS.
- CONSTRUCT WHEELCHAIR RAMPS AND FINISH RAMP SURFACES AS DIRECTED BY ENGINEER.
- 18. ALL SEWER MANHOLES AFFECTED BY THIS PROJECT SHALL BE ADJUSTED TO GRADE AS NECESSARY AND INCLUDED IN THIS WORK.
- 19. ALL EXISTING WATER MAIN VALVES (CAP AND LID) SHALL BE ADJUSTED TO GRADE AS NECESSARY AND INCLUDED IN THIS WORK.
- 20. ALL EXISTING GAS VALVES (CAP AND LID) SHALL BE ADJUSTED TO GRADE AS NECESSARY AND INCLUDED IN THIS WORK.
- 21. INITIAL COMPACTION TESTS SHALL BE PAID FOR BY THE ENGINEER, ANY REQUIRED RETESTS SHALL BE PAID FOR BY THE CONTRACTOR.

UTILITY CONTACT TABLE


UTILITY	COMPANY	REPRESENTATIVE	PHONE NUMBER/EMAIL
STORM DRAIN	CITY OF SELMA	JOEY DAGGETT	559-320-0344
ELECTRIC	PG&E	GARLAND TEANEY	559-263-5690
GAS	PG&E		delineationmaprequestis@pge.com
GAS	KINDER MORGAN	KARLY PAYNE	714-560-4604
COMMUNICATION	COMCAST	MICHAEL CORRAL	559-307-2446
COMMUNICATION	SPRINT	RICHARD WOLF	925-380-2534
COMMUNICATION	AT&T	TIM ANDREAS	559-269-2578
COMMUNICATION	AT&T CALIFORNIA	DAWN SIBLEY	559-454-3367
WATER	CALWATER	STEPHEN JOHNSON	559-896-3417
SEWER	SKF	VERONICA CAZARES	559-897-6500


AGENCY CONTACT TABLE

AGENCY	CONTACT PERSON	ADDRESS	PHONE NUMBER
CITY OF SELMA	JOEY DAGGETT	405 PARK CREEK DRIVE CLOVIS, CA 93611	559-320-0344
COUNTY OF FRESNO	MOHAMMAD ALIMI	2200 TULARE ST. 7TH FLOOR FRESNO, CA 93721	559-600-4109

	DATE	DATE RECORD DRAWING		
DESIGNED:	3/12/2021	RESIDENT ENGINEER	DATE	
DRAWN:	3/12/2021			
CHECKED:	3/12/2021			
FOR RIGHT OF WAY DATA AND ACCURATE ACCESS I	DETERMINATION, SE	E DOCUMENTS IN THE DEPARTMENT OF PUBLIC WORKS AND PLANN	NING.	



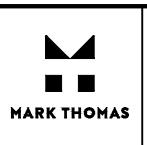

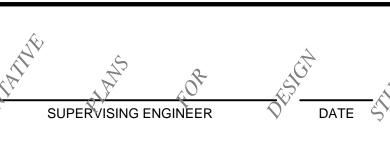





PROJECT

SELMA REGION

AND INFRASTRUCTURE IMPROVEMENTS





DEPARTMENT OF PUBLIC WORKS AND PLANNING

GENERAL NOTES

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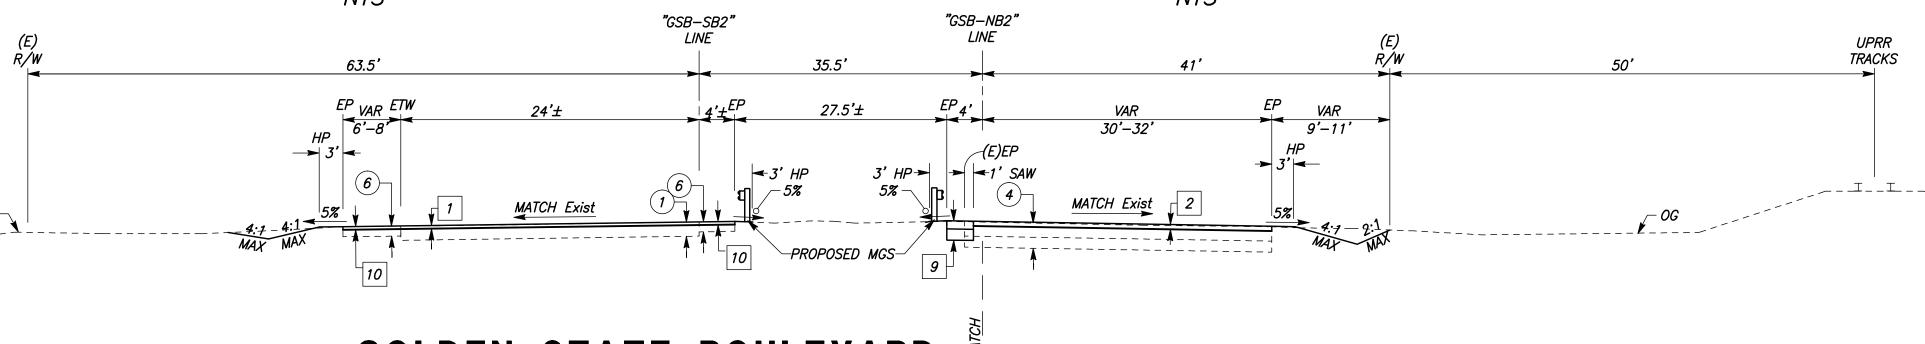
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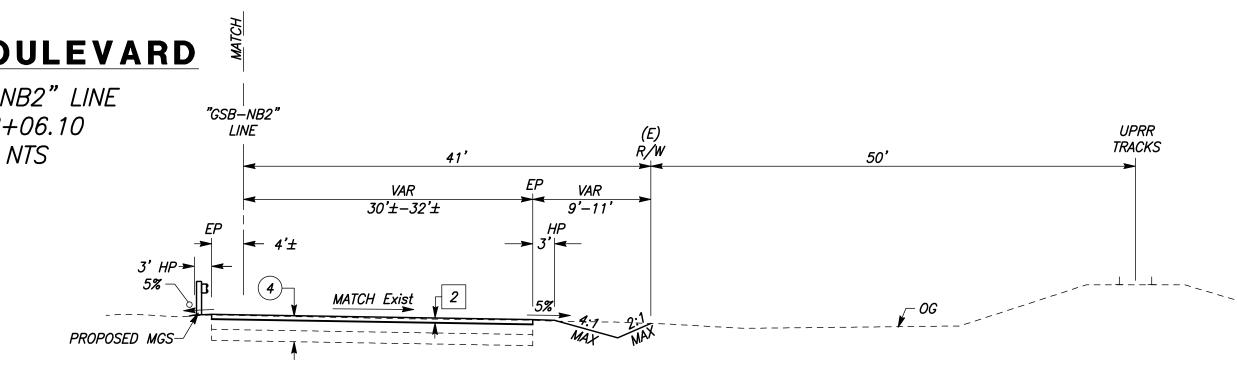


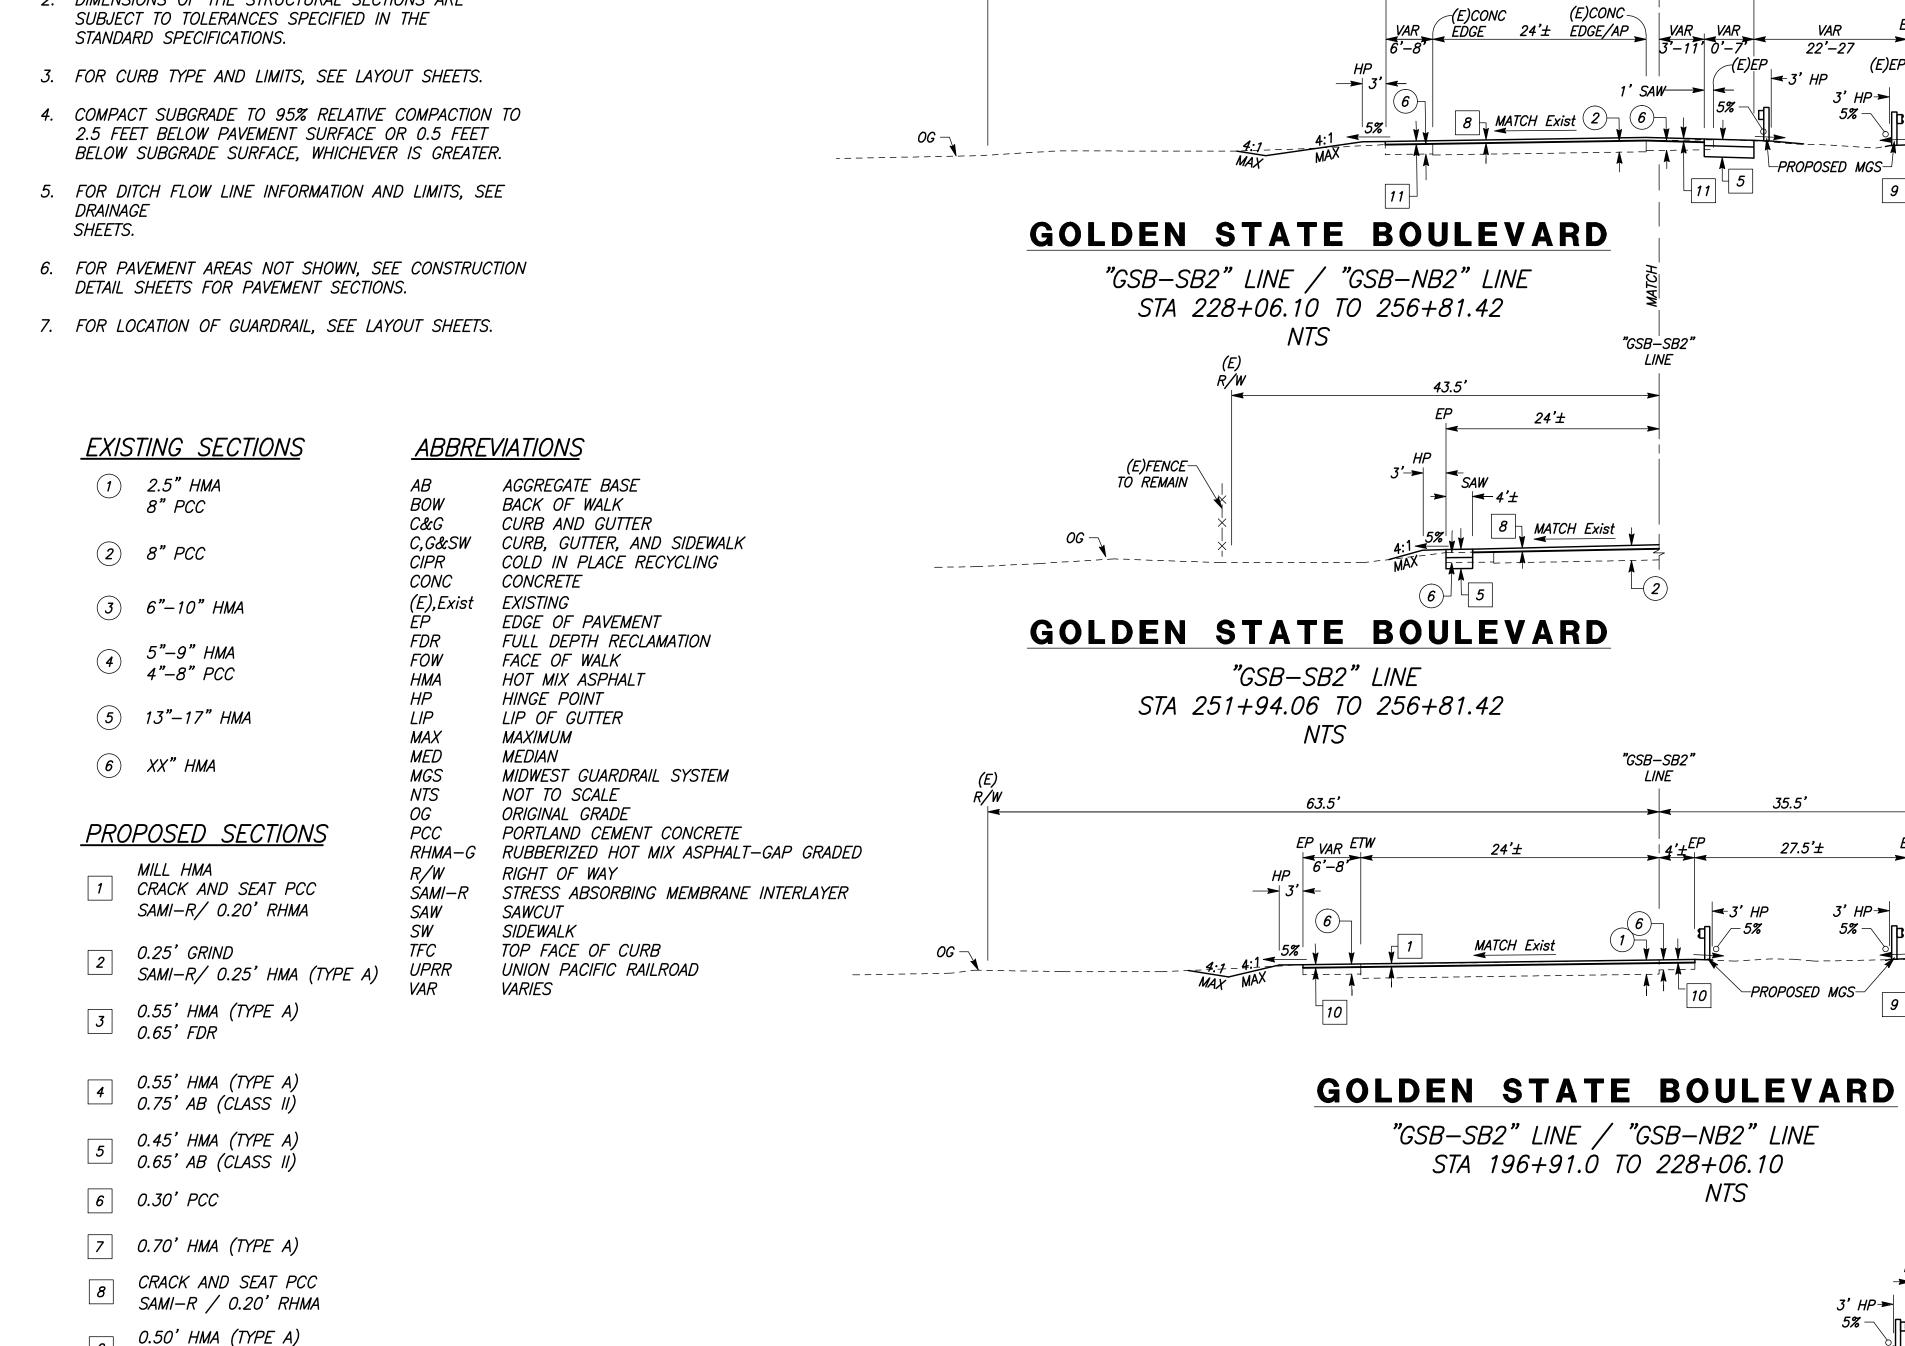

GOLDEN STATE BOULEVARD

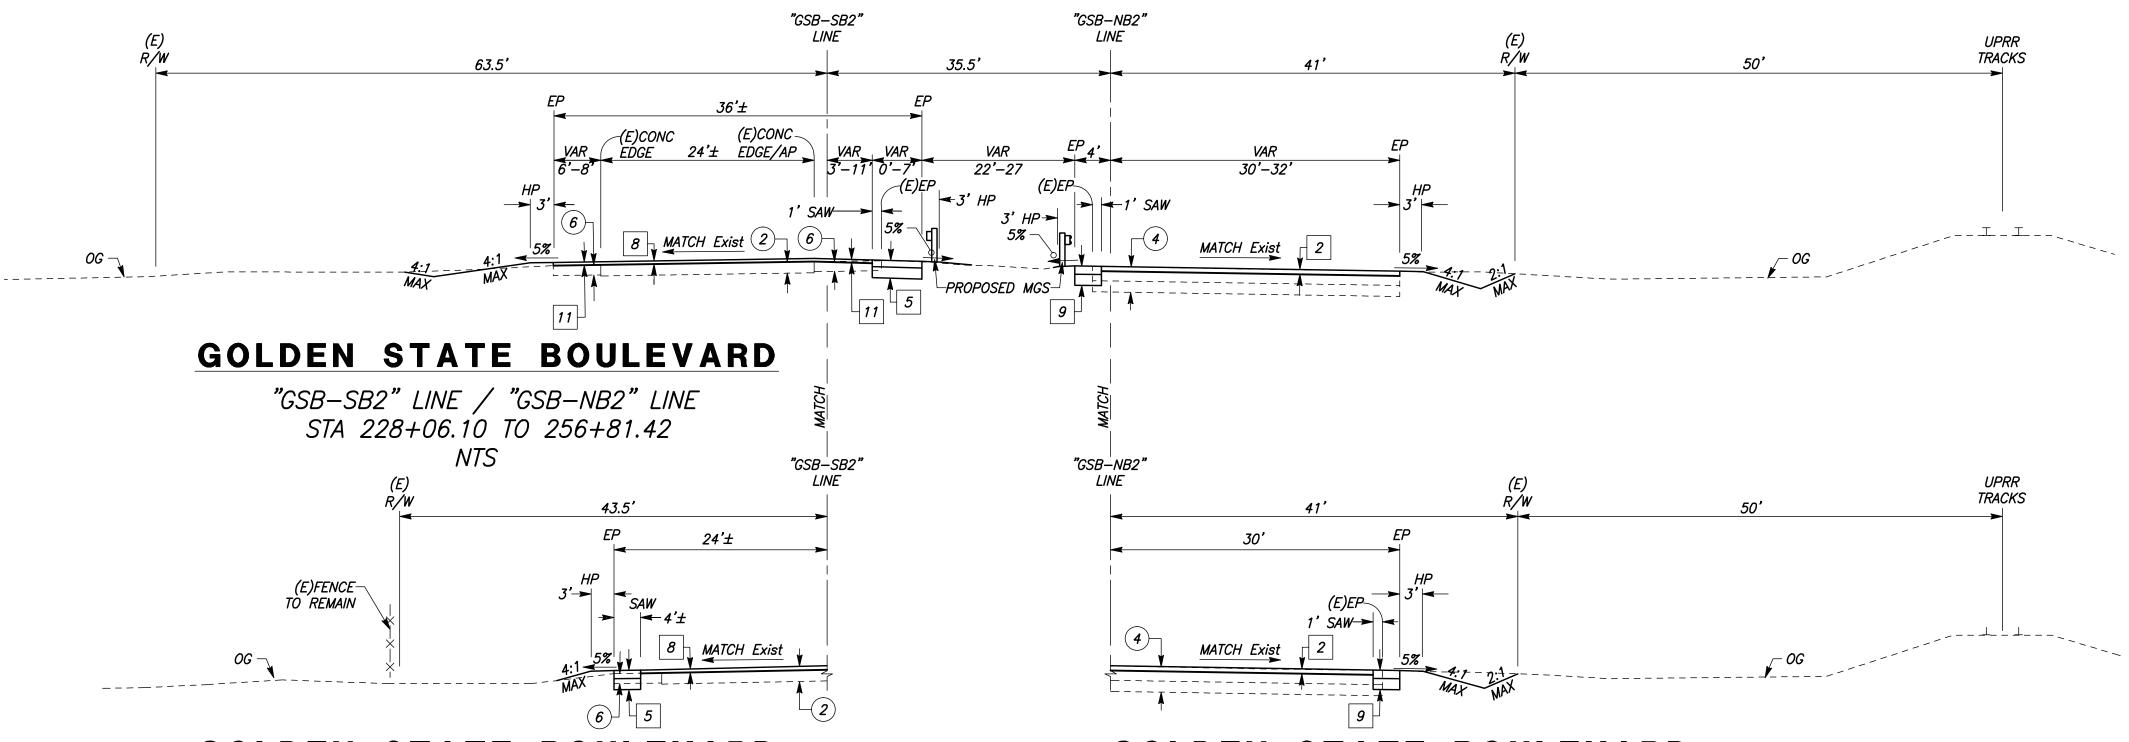"GSB-NB2" LINE STA 248+73.81 TO 256+81.42 NTS





GOLDEN STATE BOULEVARD

"GSB-NB2" LINE STA 196+91.00 TO 218+98.76 NTS

	DATE	RECORD DRAWING		
DESIGNED: CYNTHIA HORNER	3/12/2021	RESIDENT ENGINEER	DATE	
DRAWN: CYNTHIA HORNER	3/12/2021			
CHECKED: JAMES POLFER	3/12/2021			
FOR RIGHT OF WAY DATA AND ACCURATE ACCESS DETERMINATION, SEE DOCUMENTS IN THE DEDARTMENT OF RURL IC WORKS AND READINING				

0.65' AB (CLASS II)

SAMI-R/0.20' RHMA


SAMI-R/0.20' RHMA


SAMI-R/ 0.30' HMA (TYPE A)


0.20' GRIND

0.30' GRIND



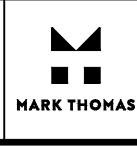

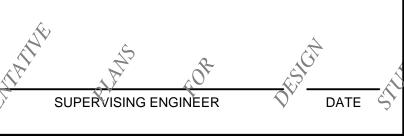

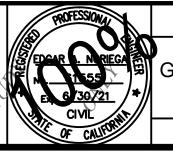

GOLDEN STATE CORRIDOR - ECONOMIC DEVELOPMENT AND INFRASTRUCTURE IMPROVEMENTS **SELMA REGION**


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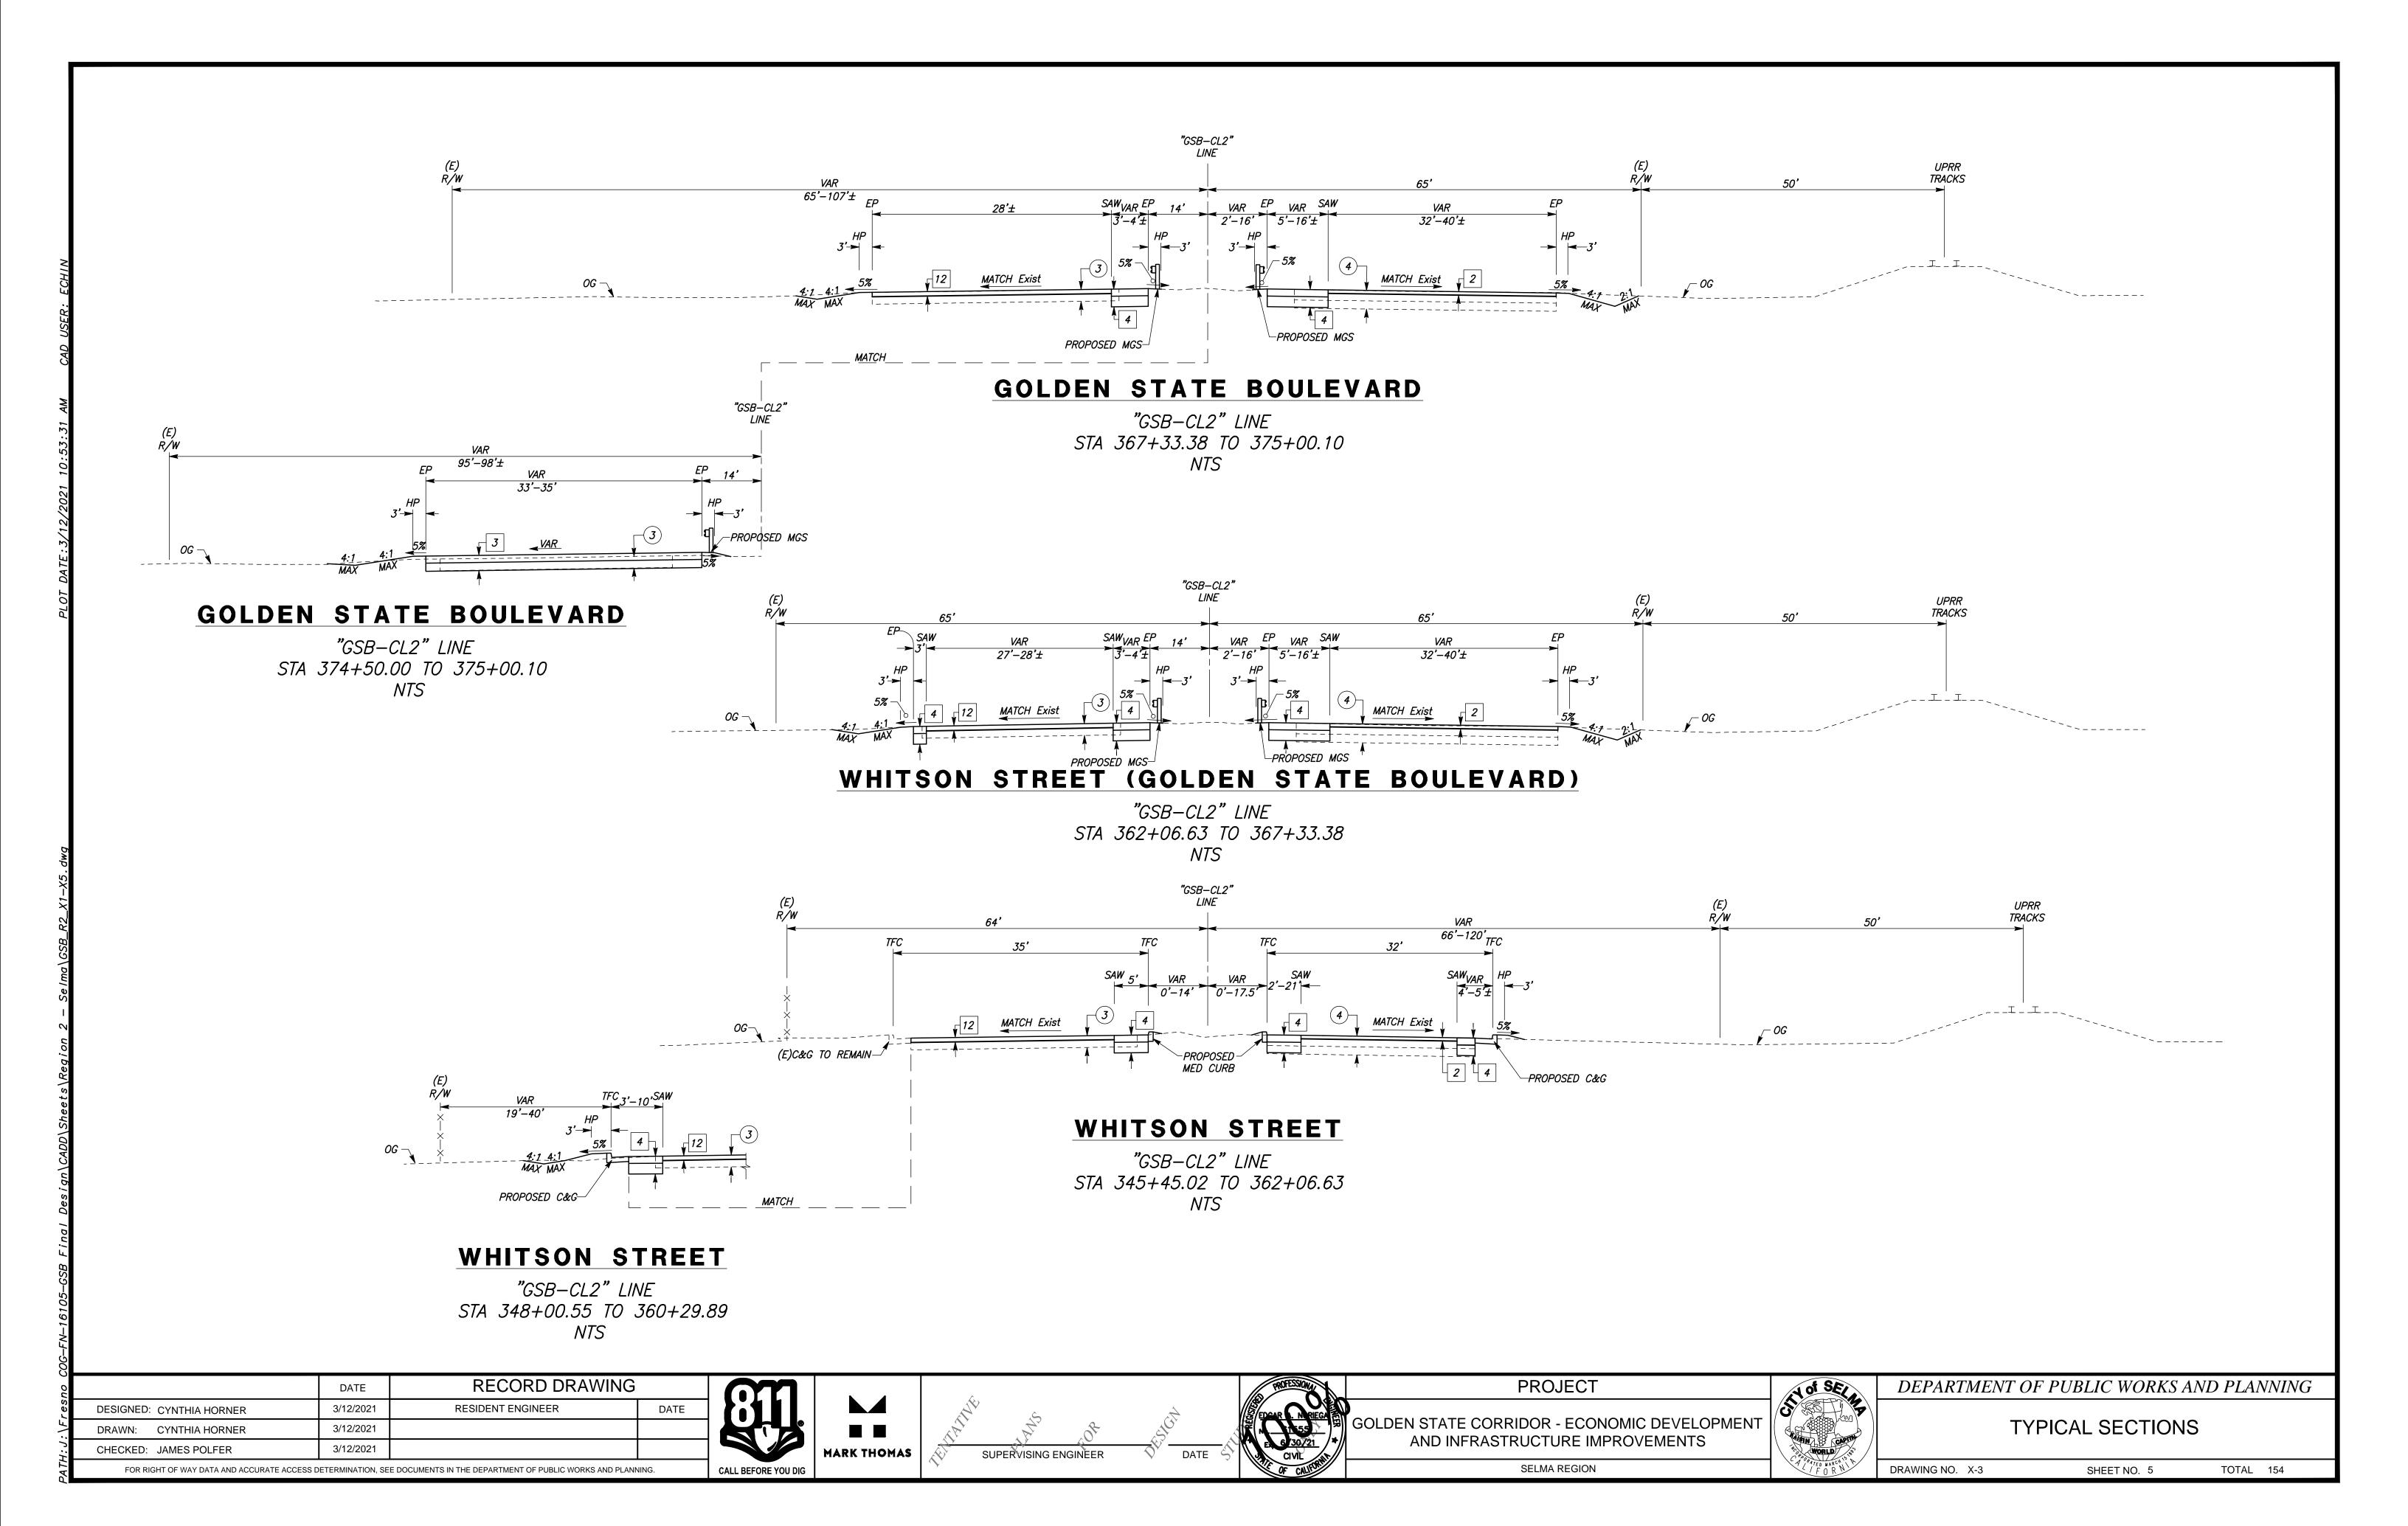



DEPARTMENT	OF PUBLIC	WORKS AND	<i>PLANNING</i>


TYPICAL SECTIONS	

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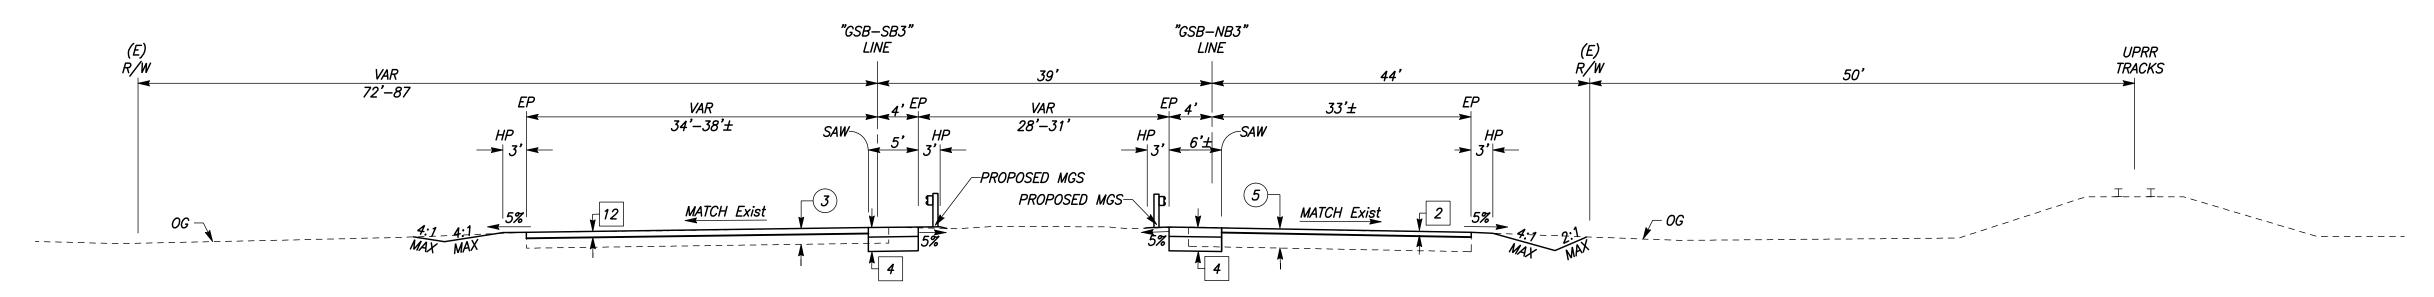


GOLDEN STATE BOULEVARD

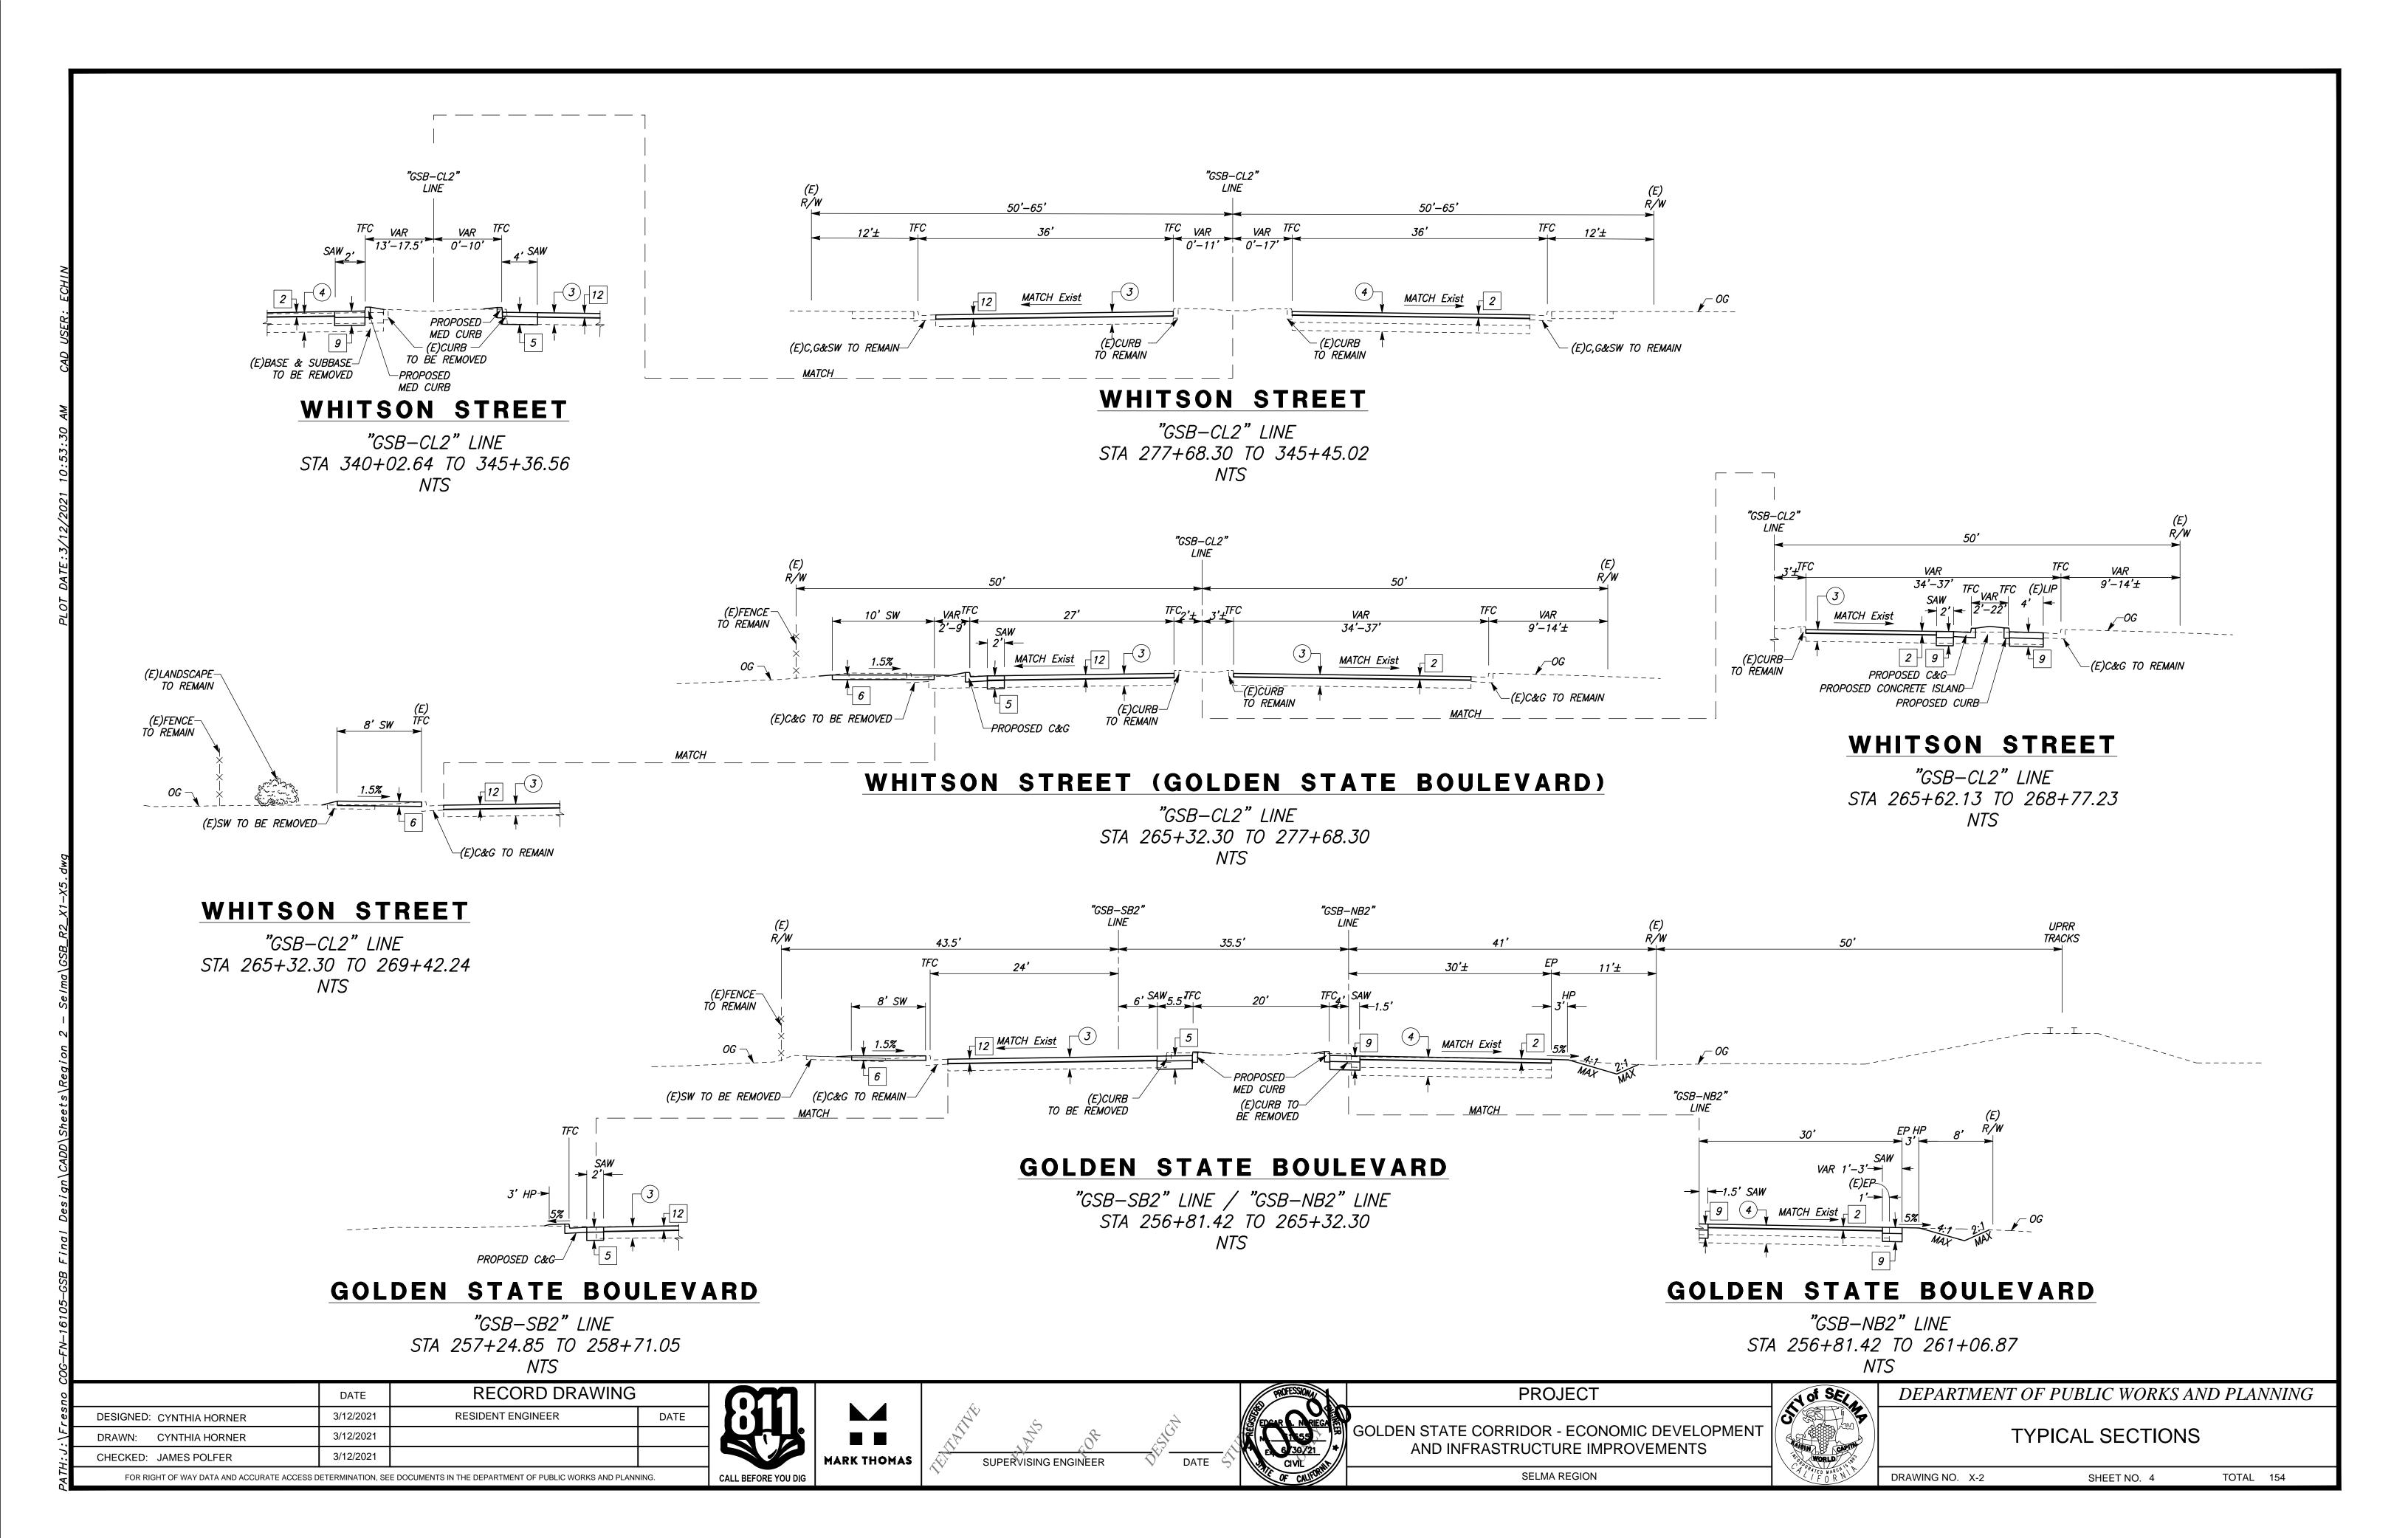"GSB-SB3" LINE / "GSB-SB4" LINE "GSB-NB3" LINE / "GSB-NB4" LINE STA 405+33.27 TO 413+82.94 STA 418+23.89 TO 443+50.00 NTS

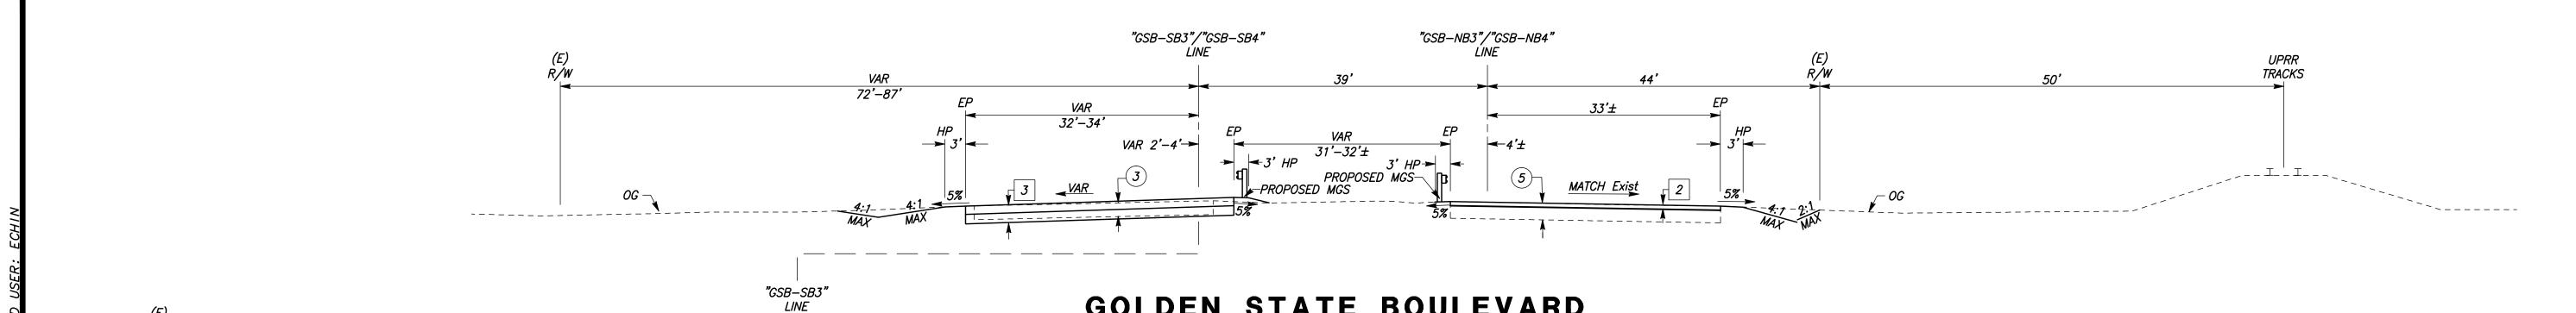
GOLDEN STATE BOULEVARD

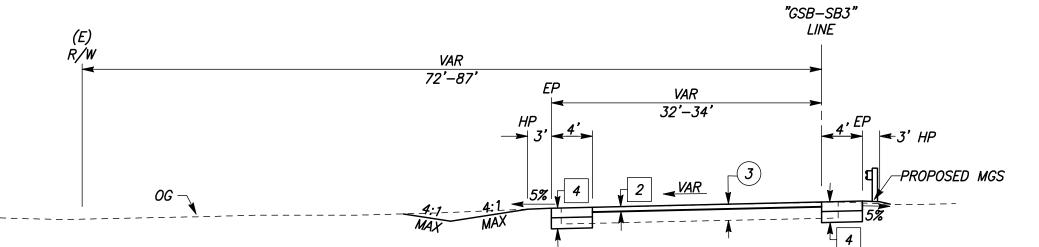"GSB-SB3" LINE STA 413+82.94 TO 418+23.67



GOLDEN STATE BOULEVARD

"GSB-SB3" LINE / "GSB-NB3" LINE STA 390+50.00 TO 405+33.27

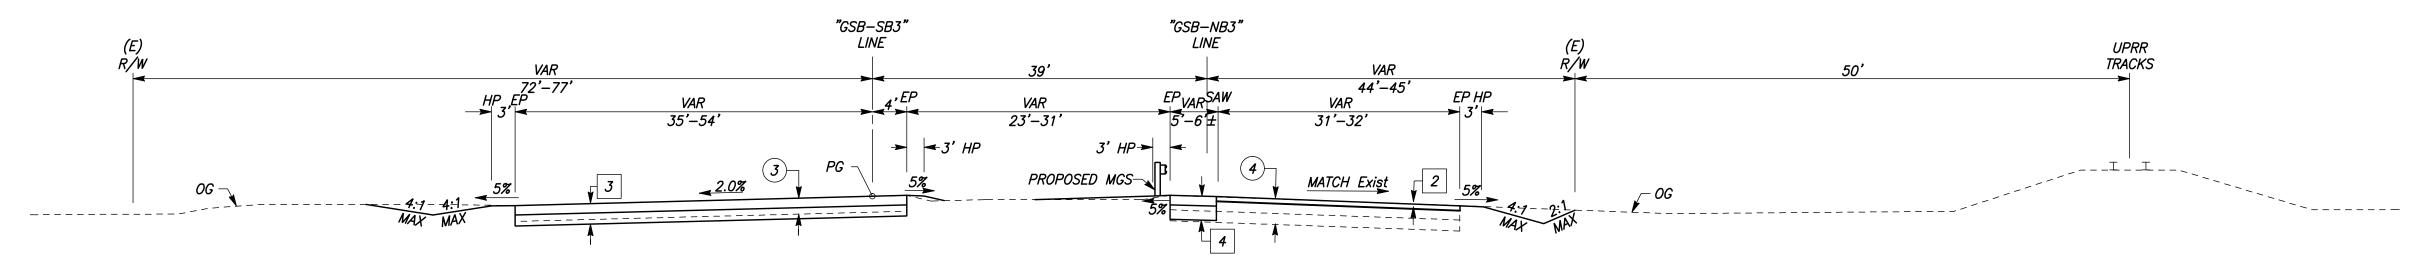



GOLDEN STATE BOULEVARD

"GSB-SB3" LINE / "GSB-NB3" LINE STA 375+00.10 TO 390+50.00

	DATE	RECORD DRAWING			
DESIGNED: CYNTHIA HORNER	3/12/2021	RESIDENT ENGINEER	DATE		
DRAWN: CYNTHIA HORNER	3/12/2021				
CHECKED: JAMES POLFER	3/12/2021				
FOR RIGHT OF WAY DATA AND ACCURATE ACCESS DETERMINATION, SEE DOCUMENTS IN THE DEPARTMENT OF PUBLIC WORKS AND PLANNING.					



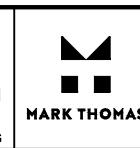

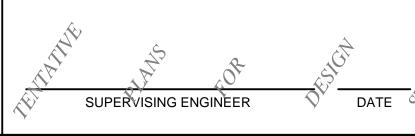



SOLDEN STATE CORRIDOR - ECONOMIC DEVELOPMENT AND INFRASTRUCTURE IMPROVEMENTS SELMA REGION


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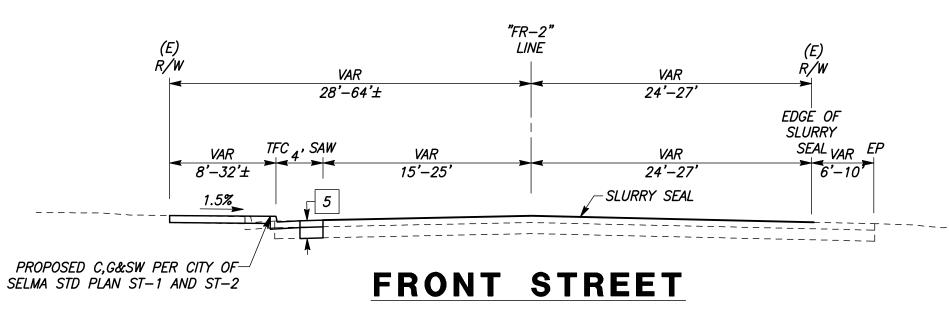


DEPARTMENT OF PUBLIC WORKS AND PLANNING


TYPICAL SECTIONS

DRAWING NO. X-4 SHEET NO. 6 TOTAL 154



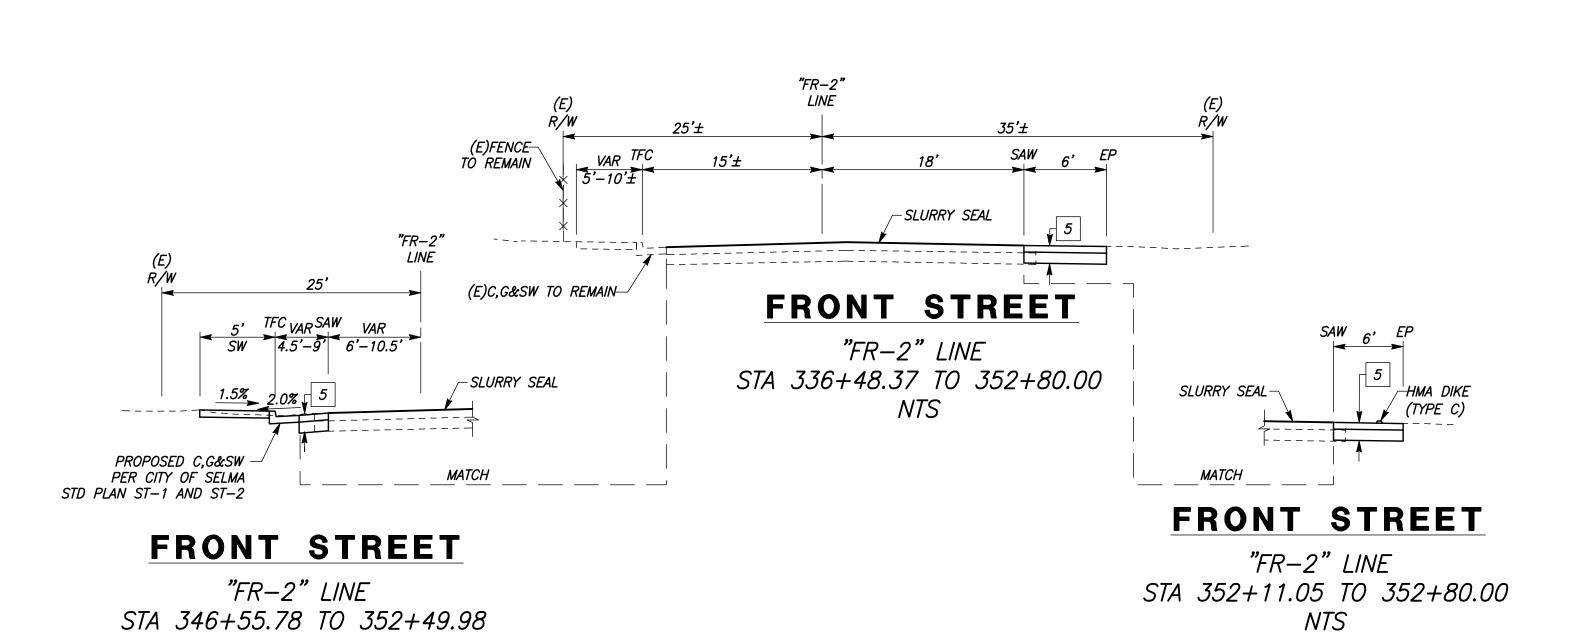



"FR-2" LINE STA 298+12.38 TO 300+87.62

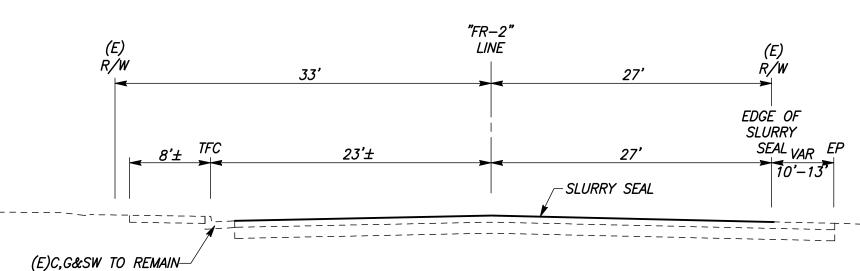


FRONT STREET

"FR-2" LINE STA 282+44.98 TO 284+83.55 STA 297+69.50 TO 298+12.38 NTS

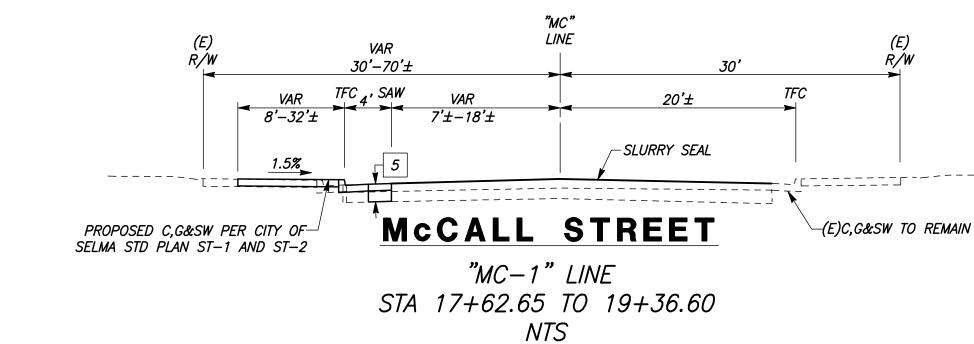


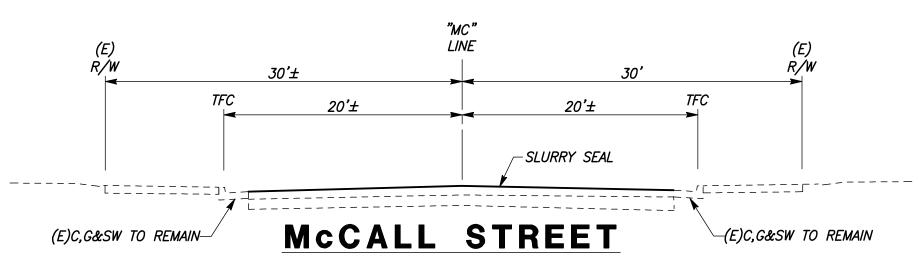

"MC-1" LINE STA 12+31.93 TO 17+62.65 NTS

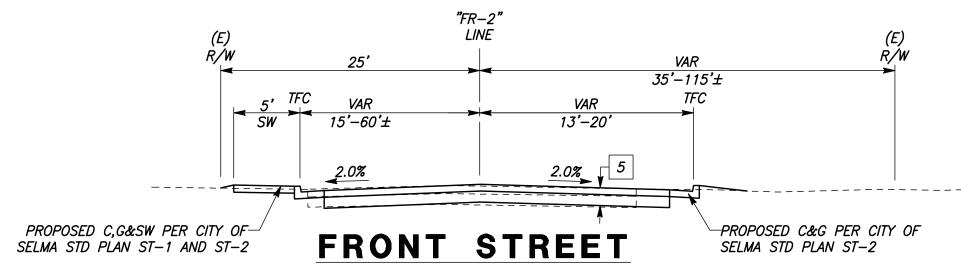

"FR-2" LINE STA 353+47.48 TO 354+32.44

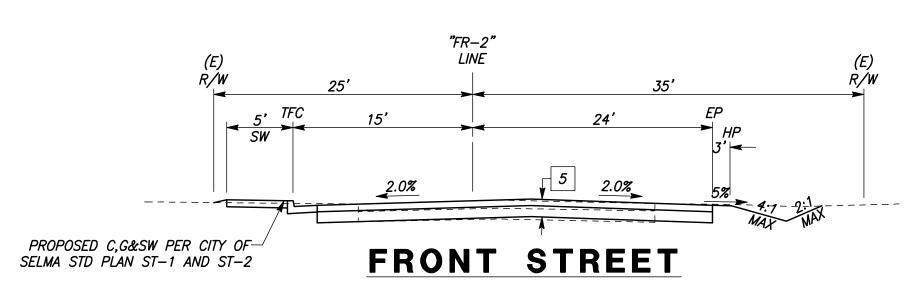



"FR-2" LINE STA 352+80.00 TO 353+47.48 NTS

	DATE	RECORD DRAWING			
DESIGNED: CYNTHIA HORNER	3/12/2021	RESIDENT ENGINEER	DATE		
DRAWN: CYNTHIA HORNER	3/12/2021			1	
CHECKED: JAMES POLFER	3/12/2021			'	
FOR RIGHT OF WAY DATA AND ACCURATE ACCESS DETERMINATION, SEE DOCUMENTS IN THE DEPARTMENT OF PUBLIC WORKS AND PLANNING.					

NTS



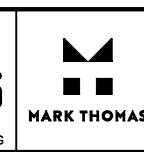

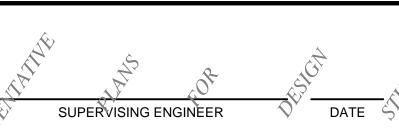




SOLDEN STATE CORRIDOR - ECONOMIC DEVELOPMENT AND INFRASTRUCTURE IMPROVEMENTS

PROJECT


SELMA REGION

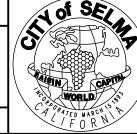



DEPARTMENT OF PUBLIC WORKS AND PLANNING


TYPICAL SECTIONS

DRAWING NO. X-5 SHEET NO. 7 TOTAL 154

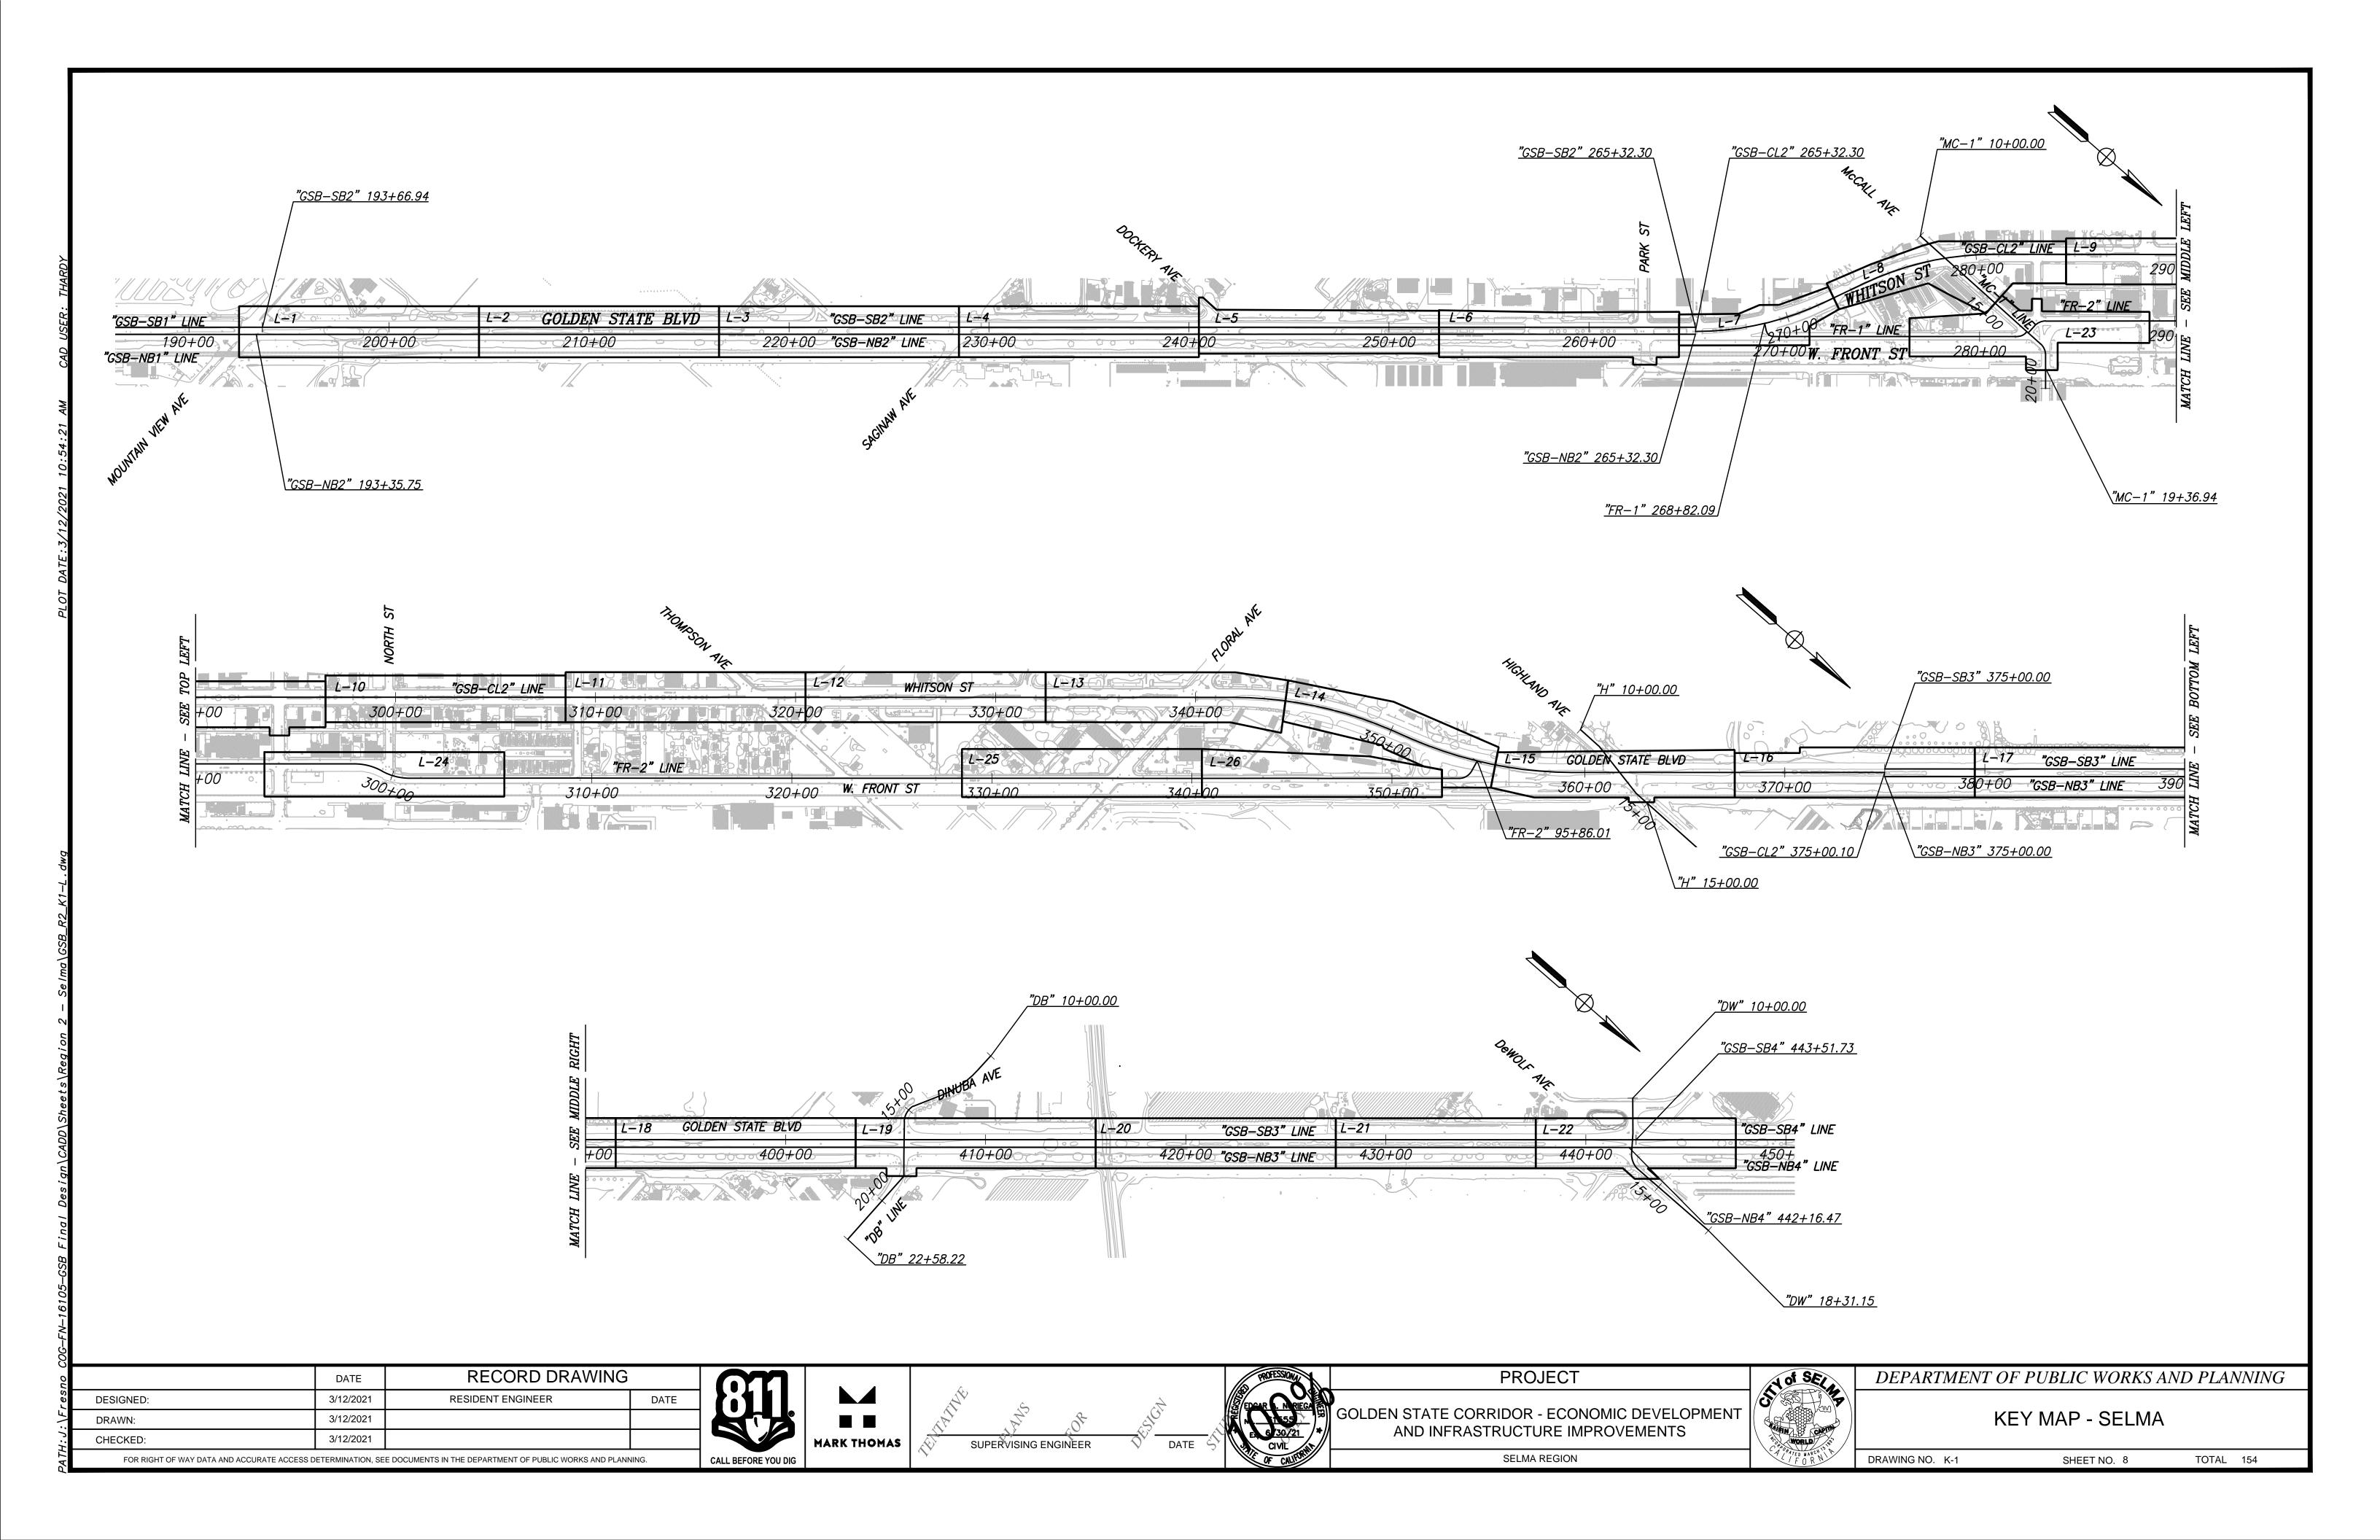

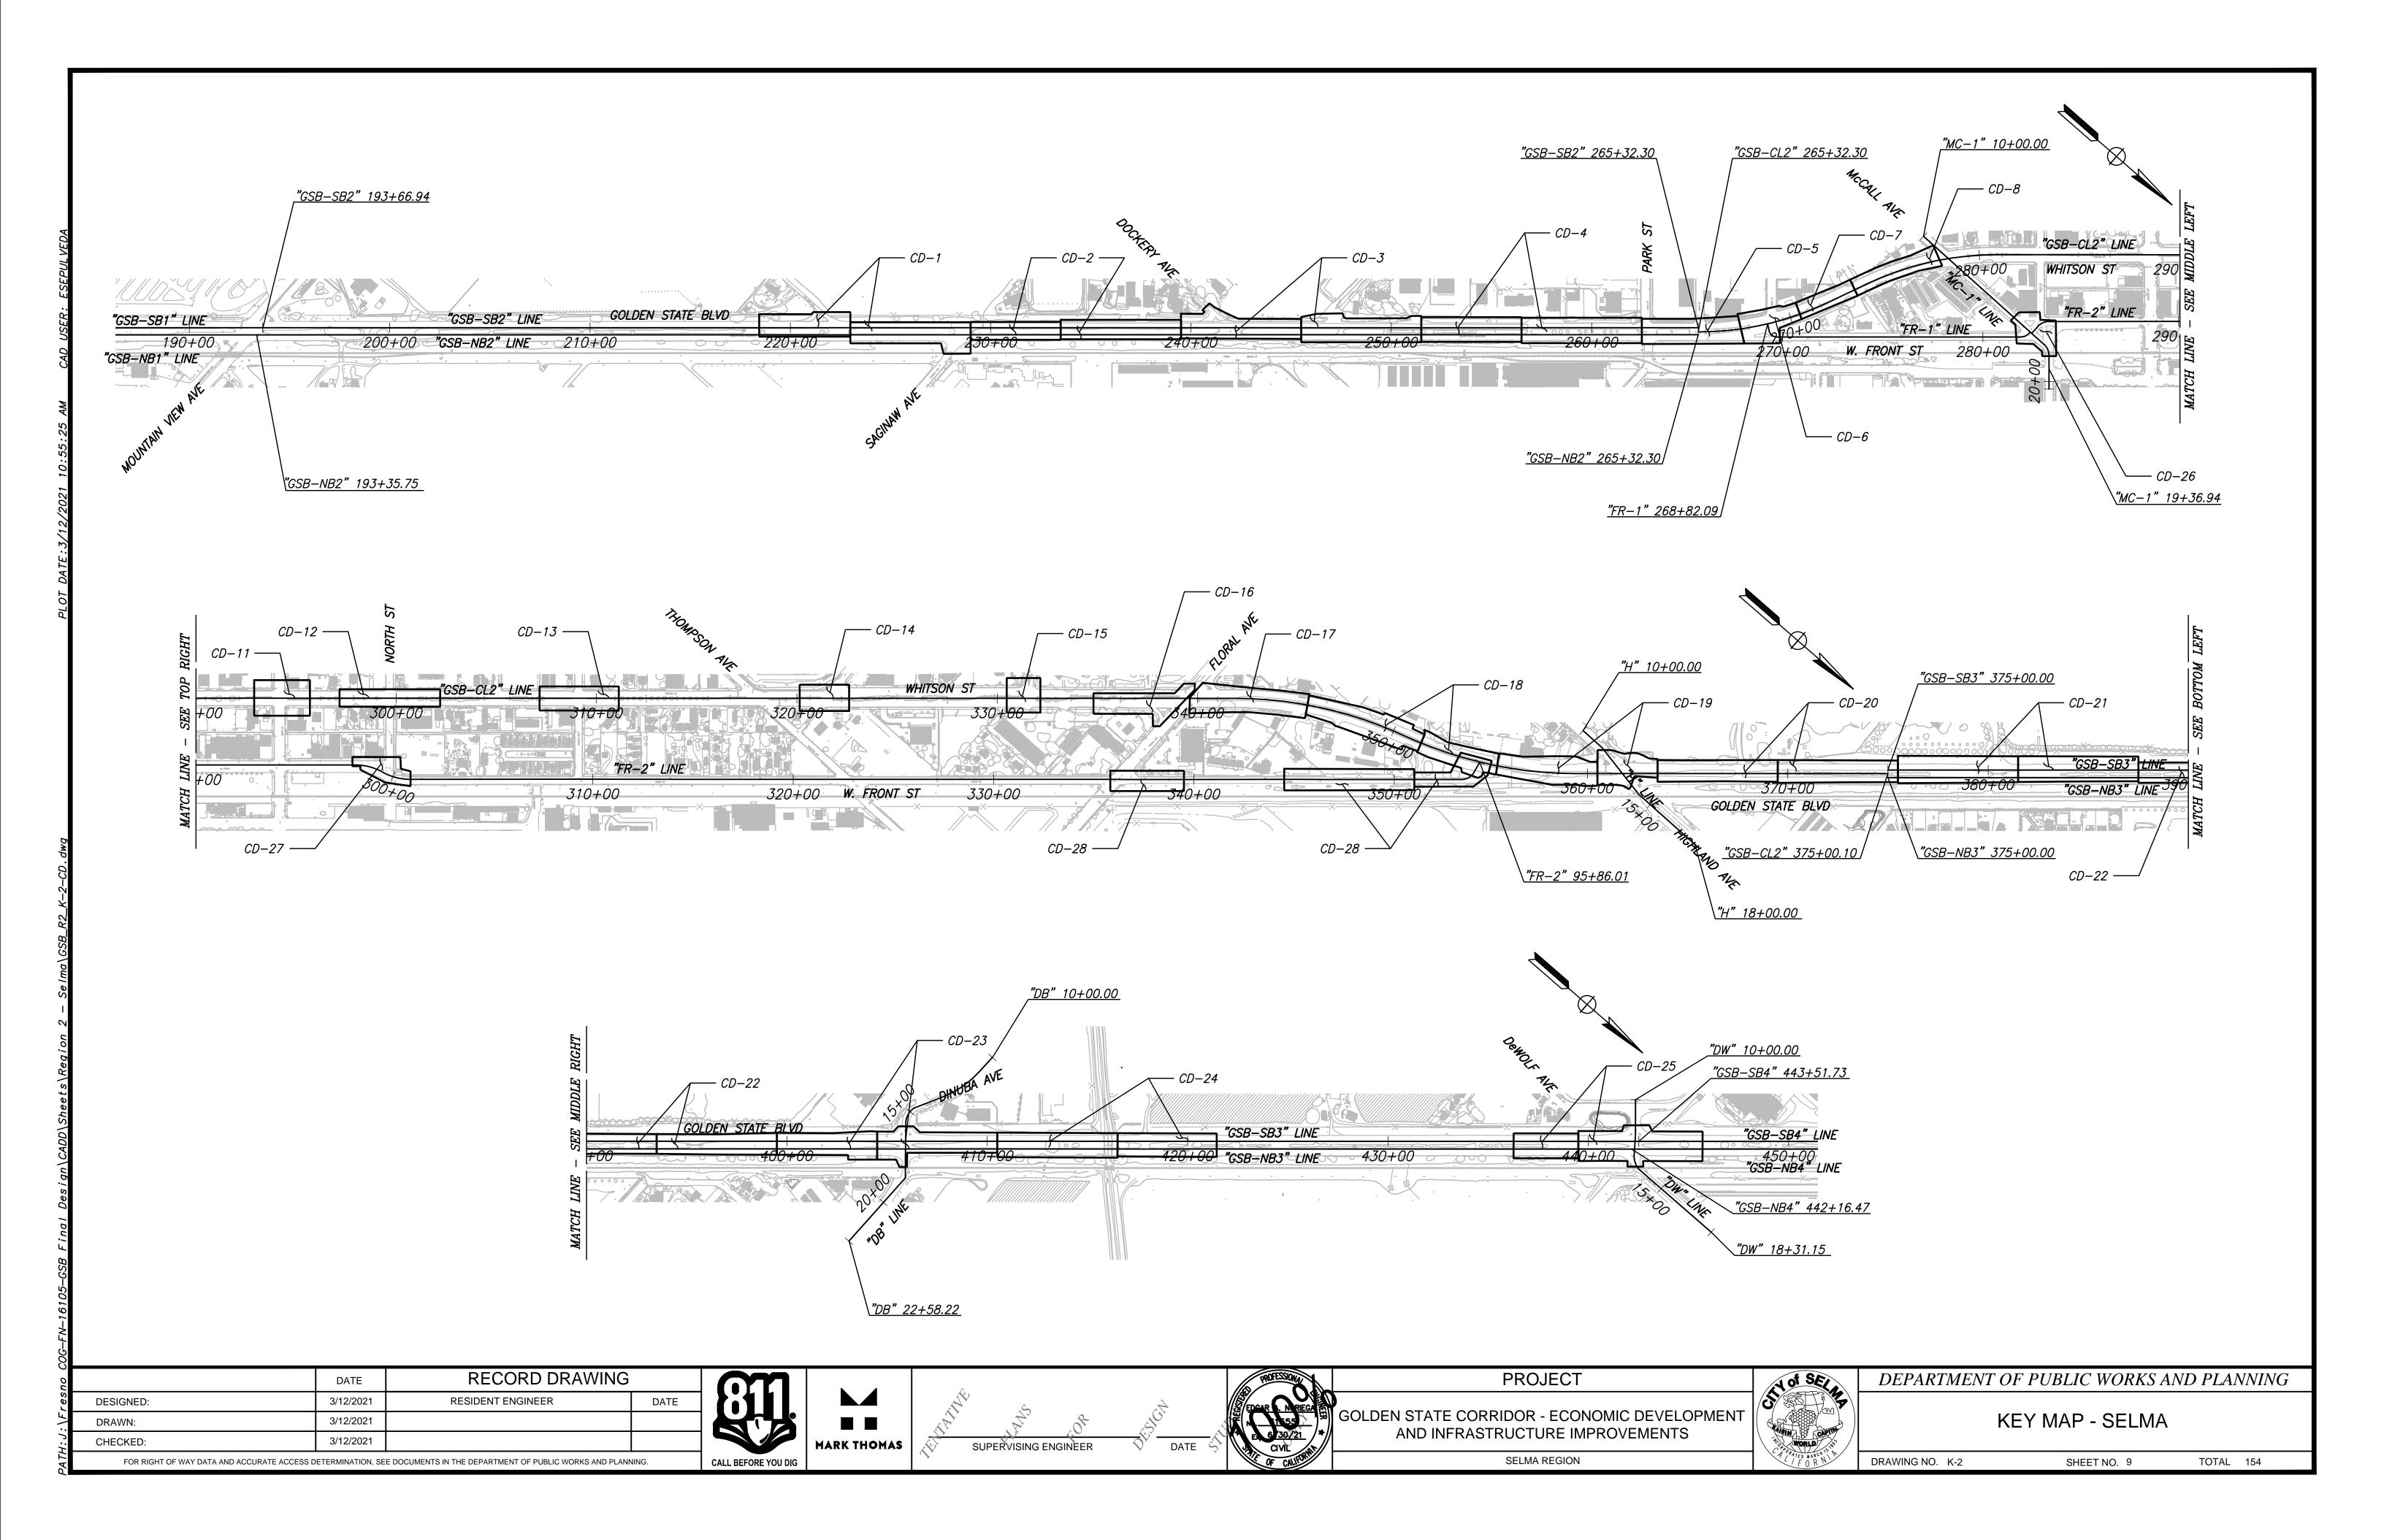

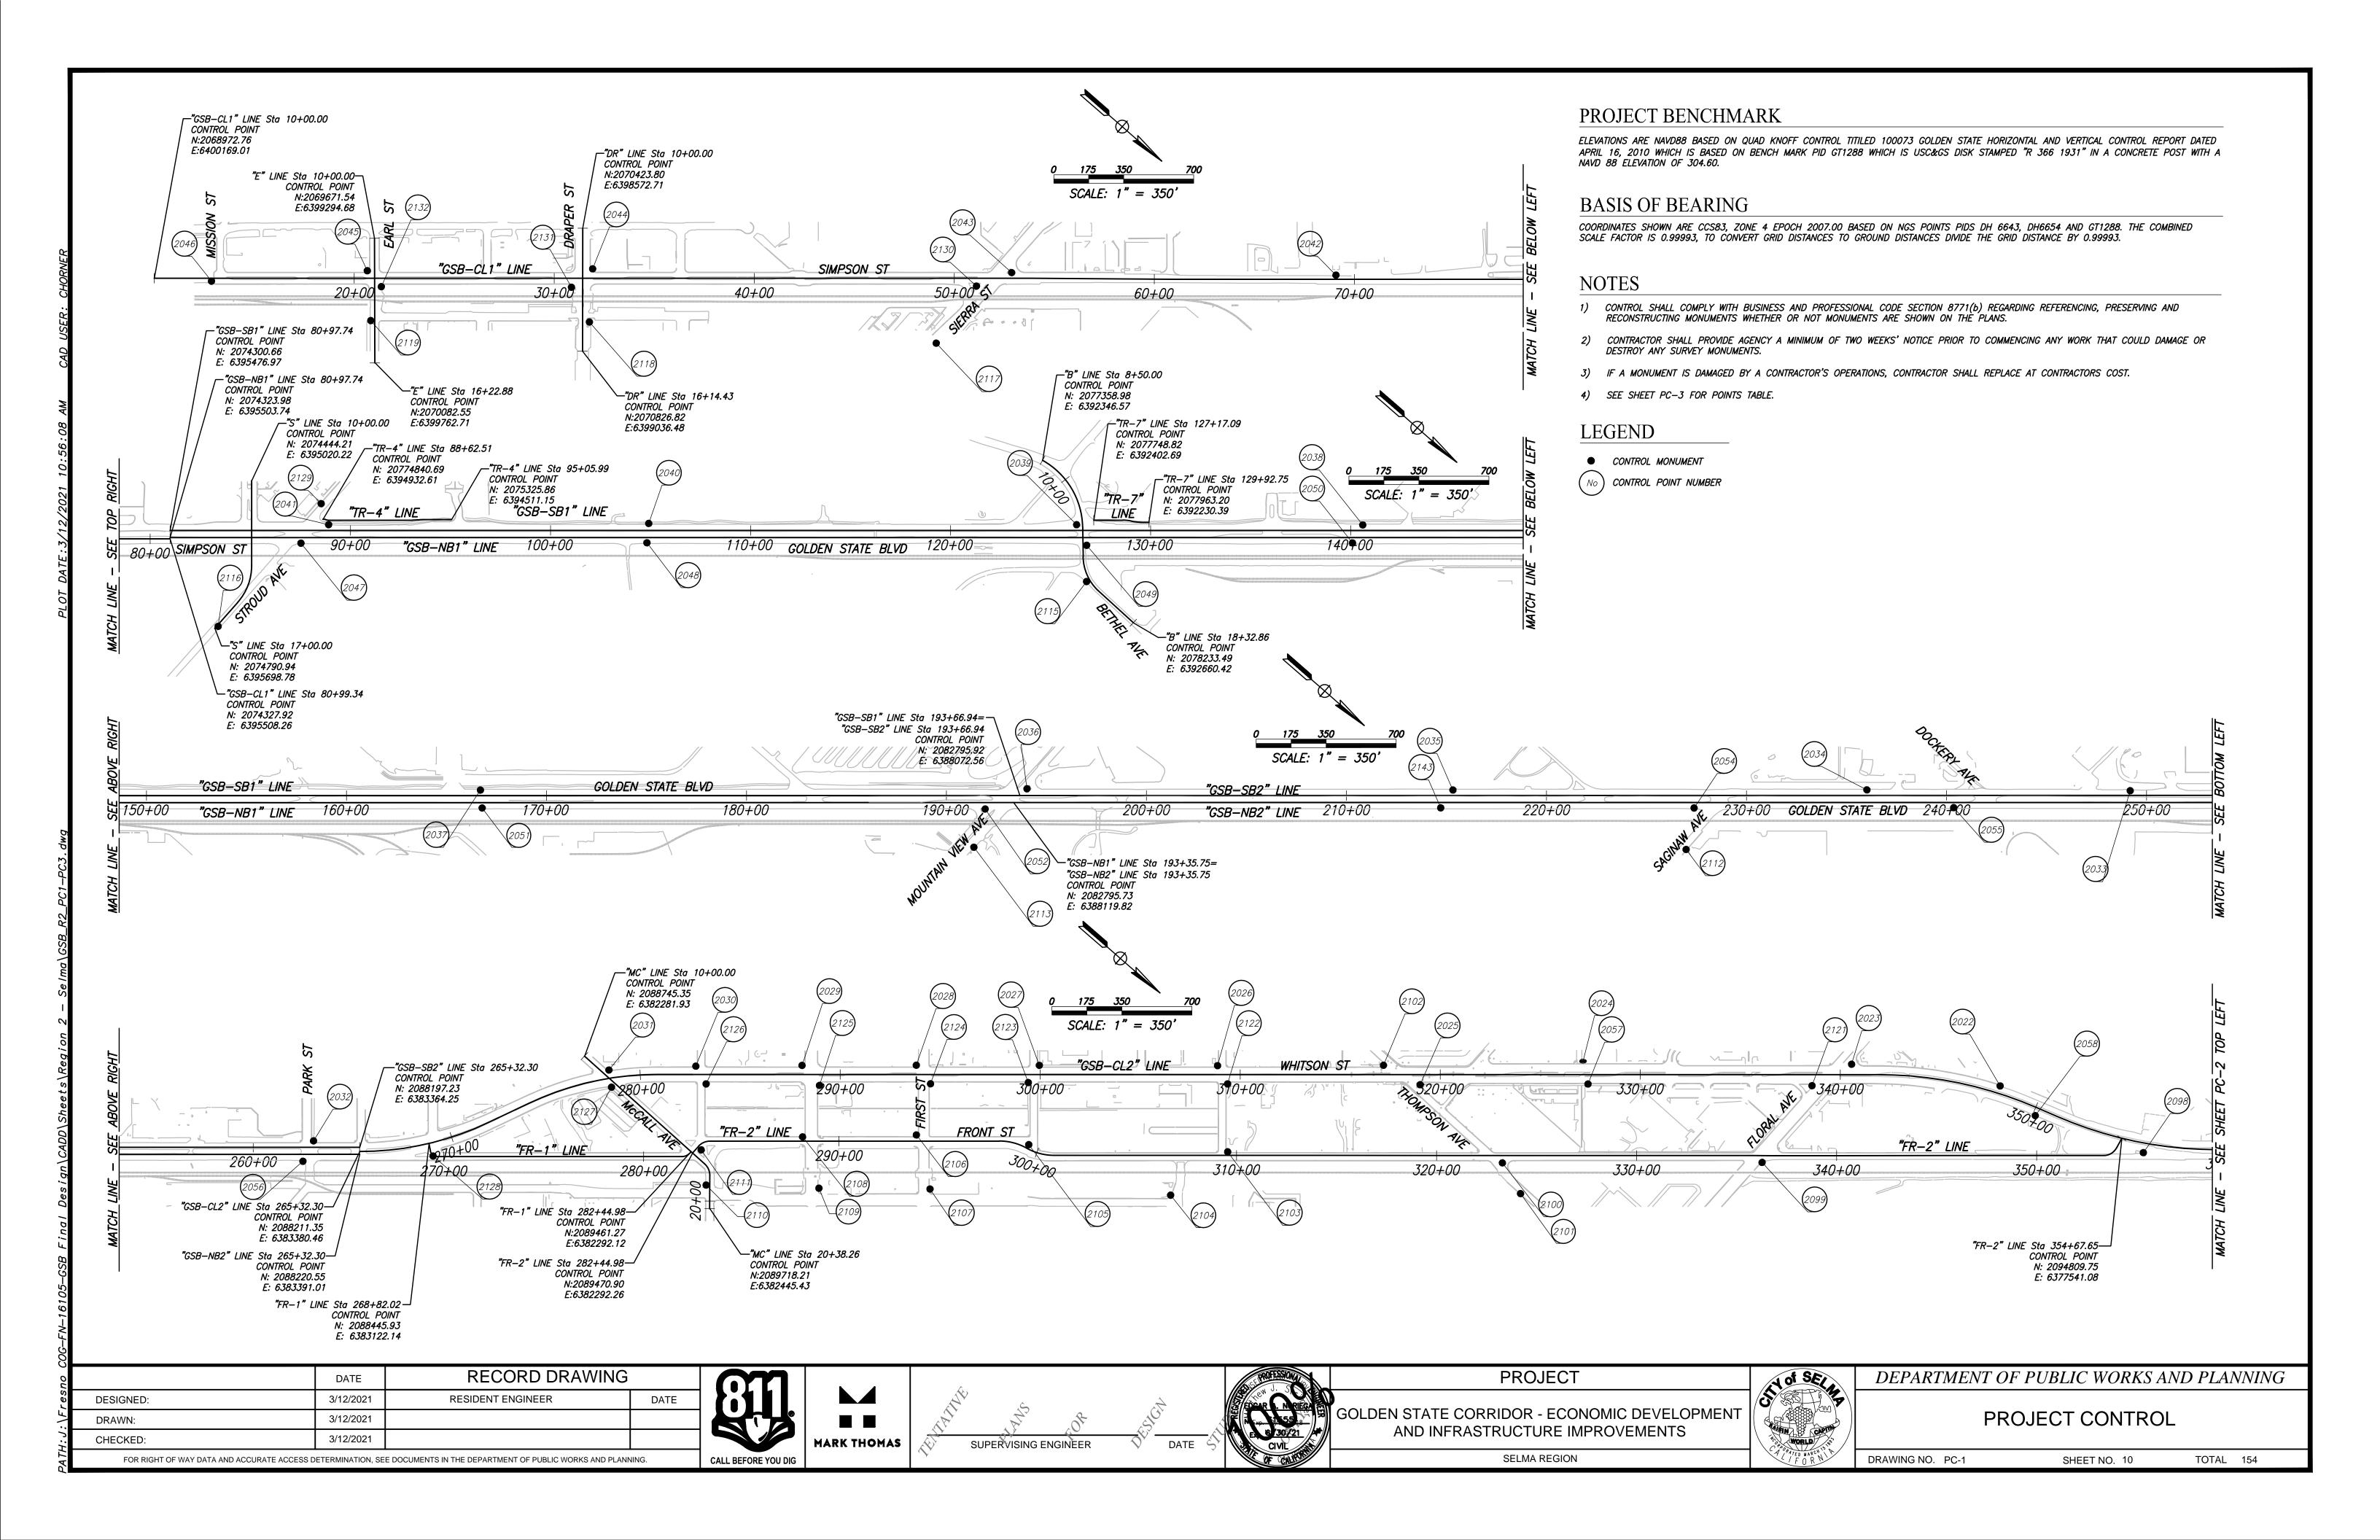

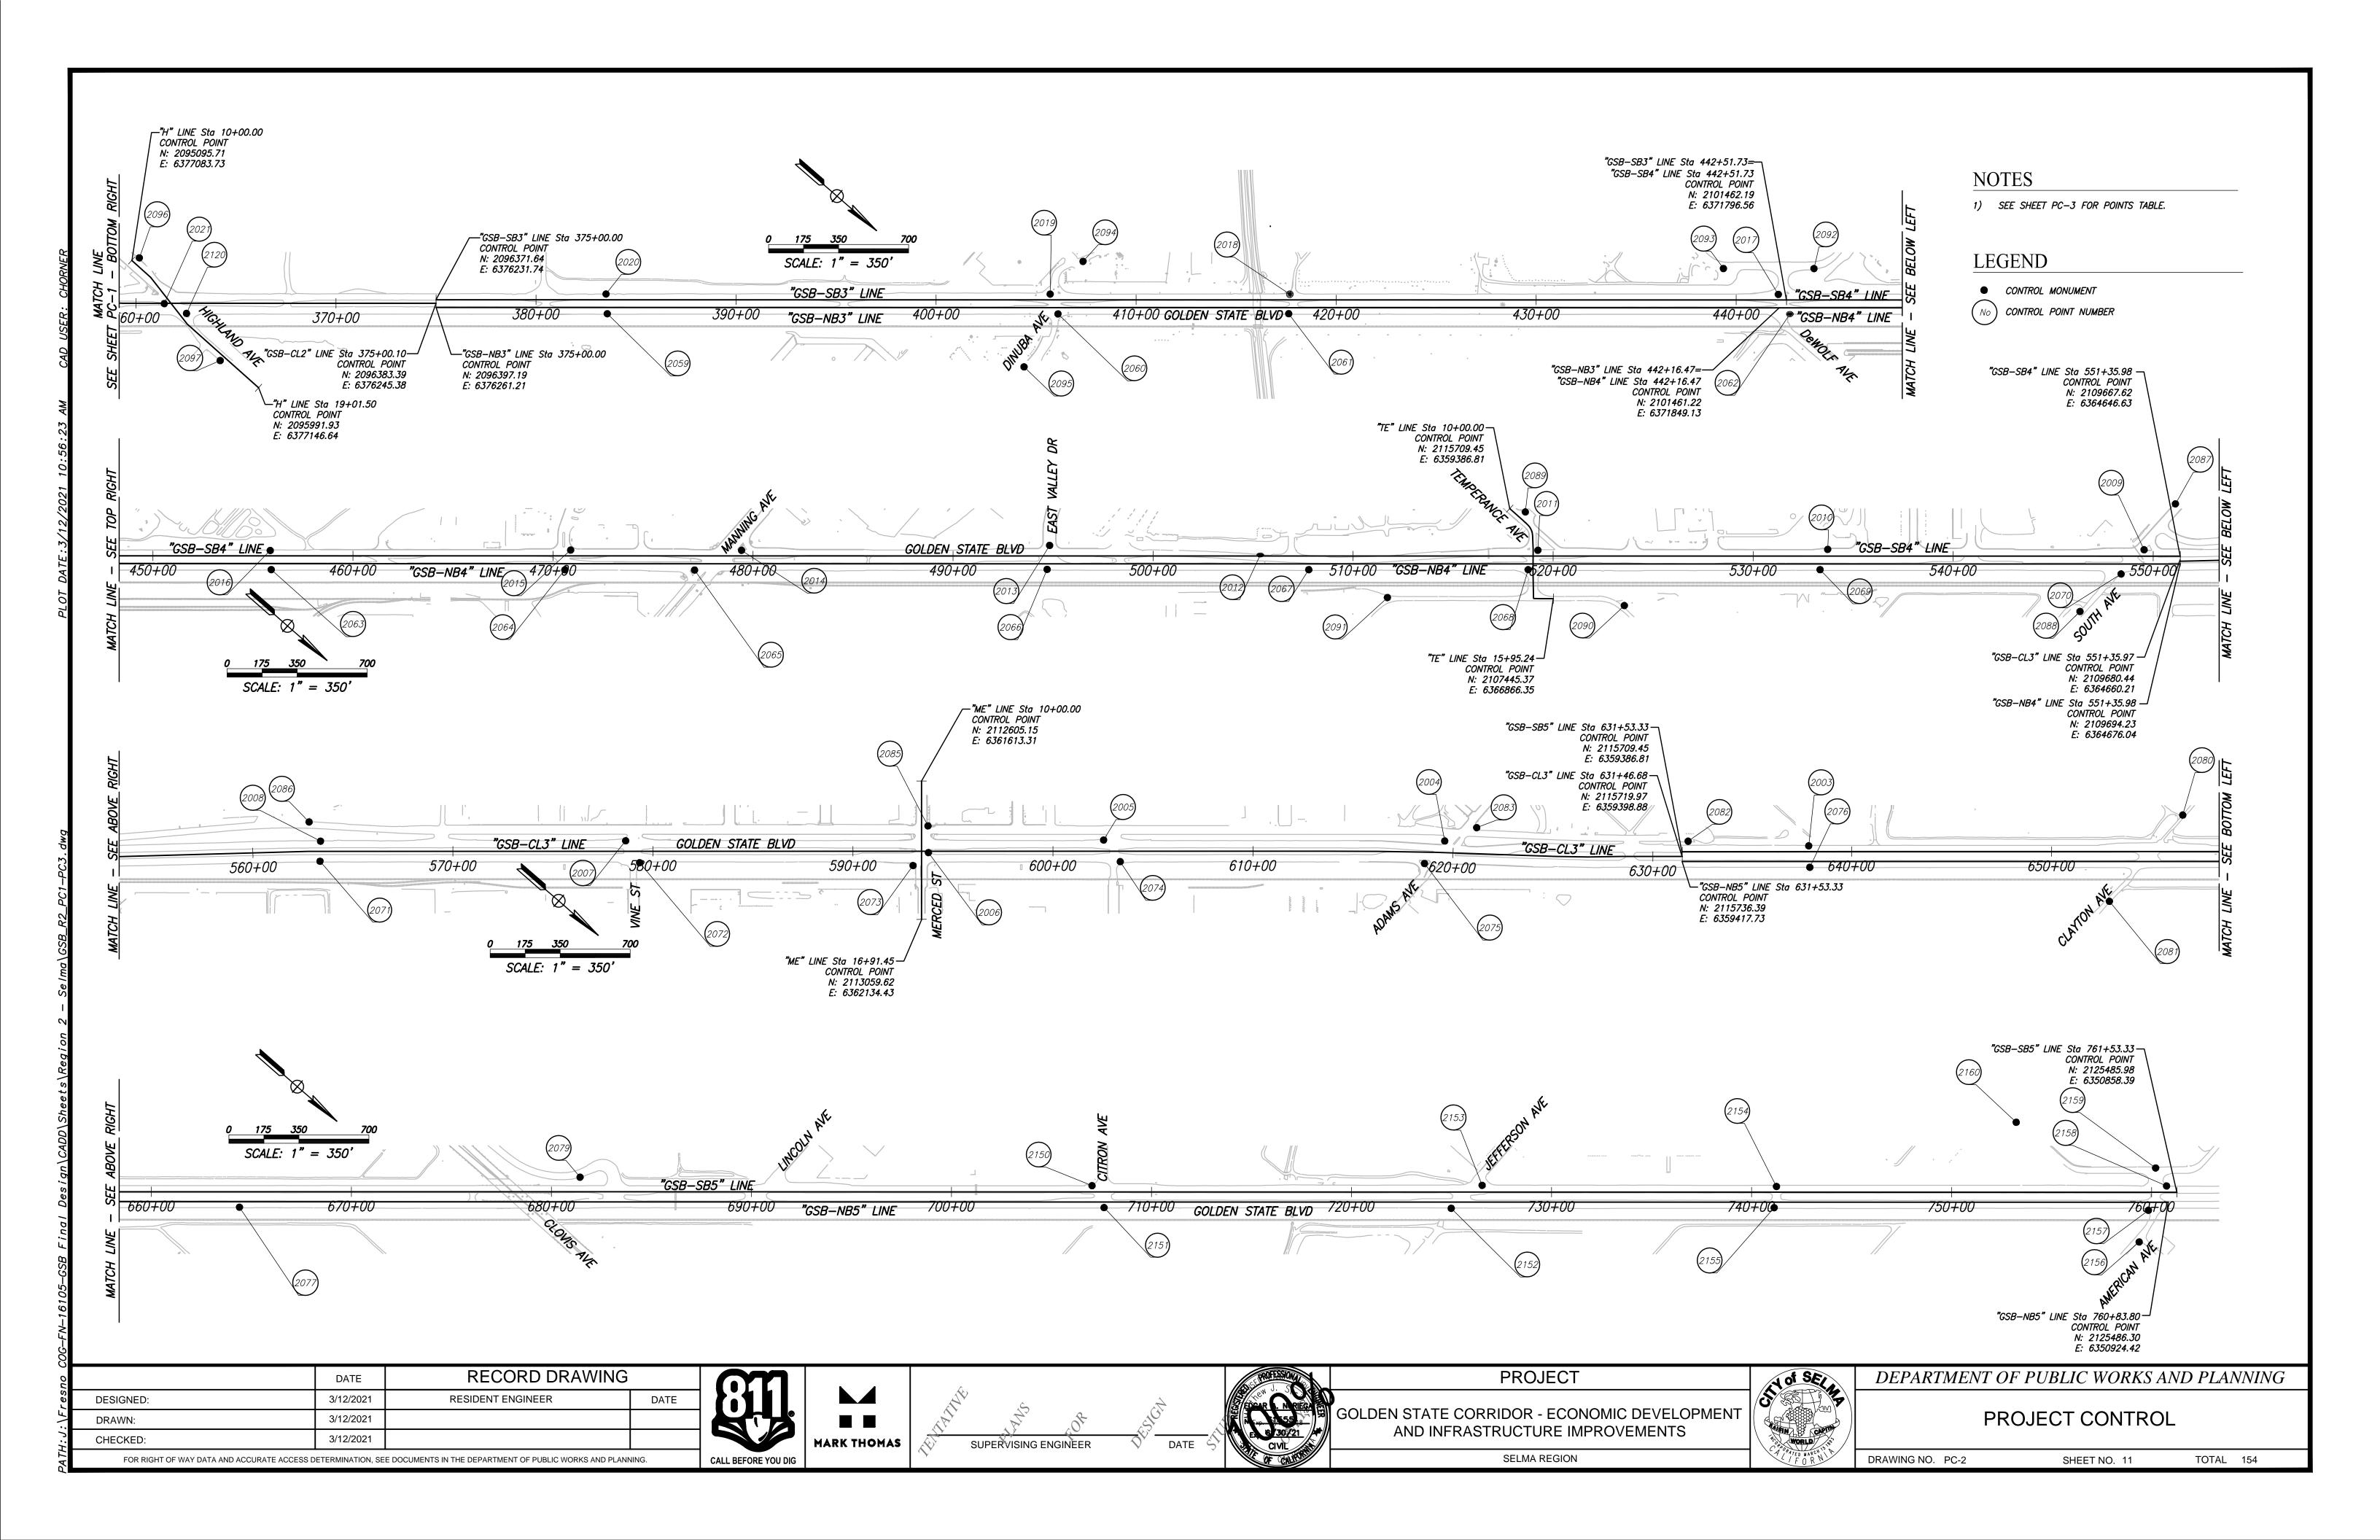

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2005	2113485.27	6361237.84	305.68	SVNS-SET
2006	2112865.89	6361860.67	306.90	SVNS-SET
2007	2111686.35	6362810.58	306.96	SVNS-SET
2008	2110537.37	6363814.36	309.65	SVNS-SET
2009	2109510.78	6364741.51	310.42	SVNS-SET
2010	2108317.28	6365779.40	307.64	SVFX MAG NAIL
2011	2107227.88	6366734.71	306.99	SVFX MAG NAIL
2012	2106197.31	6367664.45	305.56	SVFX MAG NAIL
2013	2105371.75	6368320.30	304.50	SVFX MAG NAIL
2014	2104226.89	6369350.79	305.23	SVFX MAG NAIL
2015	2103581.78	6369911.32	307.73	SVFX MAG NAIL
2016	2102451.09	6370899.66	312.92	SVFX MAG NAIL
2017	2101412.99	6371802.82	311.62	SVFX MAG NAIL
2018	2099571.23	6373406.64	313.71	SVFX MAG NAIL
2019	2098667.71	6374193.41	314.02	SVFX MAG NAIL
2020	2096993.39	6375651.96	311.37	SVFX MAG NAIL
2021	2095360.15	6377139.27	313.02	SVFX MAG NAIL
2022	2094179.37	6377743.84	313.44	SVFX SET MAG NAI
2023	2093548.19	6378150.19	313.15	SVFX SET X @ WAL
2024	2092525.80	6379020.92	311.61	SVFX SET X @ WAL
2025	2091988.94	6379644.79	309.60	SVFX SET X @ WAL
2026	2091162.98	6380238.39	308.73	SVFX SET X @ WAL
2027	2090490.37	6380822.58	309.67	SVFX SET X @ WAL
2028	2090026.34	6381226.43	309.40	SVFX SET X @ WAL
2029	2089596.29	6381602.60	307.55	SVFX SET X @ WAL
2030	2089198.20	6381954.31	307.00	SVFX SET X @ WAL
2031	2088883.40	6382254.29	307.76	SVFX SET X @ WAL
2032	2088002.46	6383491.48	305.93	SVFX SET X @ WAL
2033	2086965.15	6384406.95	305.37	SVFX MAG NAIL
2034	2085969.88	6385268.67	304.97	SVFX MAG NAIL
2035	2084410.11	6386629.11	306.00	SVFX SET MAG NAI
2036	2082800.54	6388023.81	309.16	SVCX-SET
2037	2080744.79	6389824.36	308.03	SVNS-SET
2038	2078777.36	6391538.12	305.81	SVNS-SET
<u> </u>	20/8///.36	0391338.12	<i>303.81</i>	SVNS-SE1

Point Table

Easting Elevation

Raw Description


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2040	2076081.71	6393878.16	305.93	SVNS-SET		
2041	2074879.34	6394934.09	304.84	SVNS-SET		
2042	2073416.33	6396275.30	300.60	SVNS-SET		
2043	2072185.68	6397330.94	299.80	SVCX-SET		
2044	2070594.48	6398693.21	297.70	SVCX-SET		
2045	2069751.36	6399440.44	296.82	SVCX-SET		
2046	2069198.36	6399991.57	296.26	SVNS-SET		
2047	2074835.86	6395094.61	304.71	SVNS-SET		
2048	2076138.24	6393956.67	306.13	SVNS-SET		
2049	2077803.81	6392521.81	301.17	SVNS-SET		
2050	2078797.89	6391639.88	304.98	SVFX SET MAG NAI		
2051	2080810.07	6389885.97	307.34	SVNS-SET		
2052	2082709.32	6388237.48	310.51	SVCX-SET		
2054	2085378.08	6385904.57	305.11	SVNS-SET		
2055	2086355.67	6385050.65	304.29	SVFX MAG NAIL		
2056	2088029.27	6383603.22	305.47	SVFX MAG NAIL		
2057	2092619.57	6379090.46	311.38	SVFX SET X @ WAL		
2058	2094409.15	6377740.46	312.53	SVFX SET MAG NAI		
2059	2097063.08	6375722.29	307.72	SVFX MAG NAIL		
2060	2098762.34	6374242.46	313.36	SVFX MAG NAIL		
2061	2099631.06	6373483.82	313.93	SVFX MAG NAIL		
2062	2101521.21	6371838.91	310.87	SVFX MAG NAIL		
2063	2102517.33	6370968.38	313.12	SVFX MAG NAIL		
2064	2103624.84	6370004.54	305.71	SVFX MAG NAIL		
2065	2104114.29	6369579.36	306.39	SVFX MAG NAIL		
2066	2105441.02	6368418.91	303.29	SVFX MAG NAIL		
2067	2106428.09	6367560.23	306.69	SVFX MAG NAIL		
2068	2107254.84	6366839.71	307.31	SVNS-SET		
2069	2108355.11	6365880.89	305.61	SVFX MAG NAIL		
2070	2109503.82	6364908.28	311.09	SVNS-SET		
2071	2110601.42	6363891.83	309.53	SVNS-SET		
2072	2111810.55	6362847.57	307.07	SVNS-SET		
2073	2112850.72	6361959.79	306.39	SVCX-SET		
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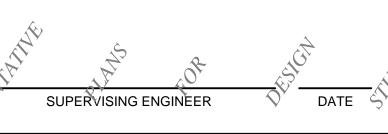
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2080	2117470.35	6357598.65	302.98	SVNS-SET		
2081	2117477.21	6358164.63	301.02	SVNS-SET		
2082	2115692.00	6359322.24	306.37	SVNS-SET		
2083	2114850.75	6359965.61	304.28	SVCX-SET		
2085	2112776.83	6361761.51	304.48	SVNS-SET		
2086	2110431.36	6363779.54	310.01	SVNS-SET		
2087	2109478.42	6364465.95	303.04	SVNS-SET		
2088	2109472.19	6365184.41	312.82	SVFX MAG NAIL		
2089	2107054.72	6366631.47	302.91	SVFX MAG NAIL		
2090	2107735.10	6366659.05	308.10	SVFX MAG NAIL		
2091	2106816.12	6367407.01	310.86	SVNS-SET		
2092	2101462.64	6371588.26	310.57	SVFX MAG NAIL		
2093	2101121.25	6371885.50	310.88	SVFX MAG NAIL		
2094	2098684.13	6373962.31	314.41	SVFX MAG NAIL		
2095	2098808.06	6374553.41	314.34	SVFX MAG NAIL		
2096	2095115.96	6377048.74	311.83	SVFX SET X @ WAL		
2097	2095757.87	6377170.16	313.36	SVFX MAG NAIL		
2098	2094938.25	6377524.75	312.14	SVFX MAG NAIL		
2099	2093533.15	6378813.90	311.26	SVFX SET X @ WAL		
2100	2092555.79	6379668.74	310.04	SVFX MAG NAIL		
2101	2092725.19	6379724.91	310.03	SVFX MAG NAIL		
2102	2091787.06	6379691.75	309.26	SVFX SET X @ WAL		
2103	2091484.15	6380529.63	309.70	SVFX SET X @ WAL		
2104	2091411.39	6380880.49	310.40	SVFX SET X @ WAL		
2105	2090710.69	6381156.13	308.80	SVFX MAG NAIL		
2106	2090255.37	6381488.68	307.51	SVFX SET X @ WAL		
2107	2090484.12	6381647.80	308.97	SVFX SET X @ WAL		
2108	2089832.79	6381869.93	306.45	SVFX SET X @ WAL		
2109	2090062.76	6382009.47	308.64	SVFX SET X @ WAL		
2110	2089627.23	6382368.15	308.12	SVFX MAG NAIL		
2111	2089493.39	6382252.01	307.01	SVFX SET X @ POR		
2112	2085484.07	6386087.06	305.54	SVFX SET MAG NAI		
2113	2082792.24	6388418.50	310.37	SVNS-SET		

Doin! //	Northin-	Fasting		Paw Donorintian
Point #	Northing	Easting	Elevation	Raw Description
2115	2077922.64	6392658.57	305.63	SVNS-SET
2116	2074796.68	6395679.74	303.68	SVNS-SET
2117	2072133.30	6397844.57	299.92	SVCX-SET
2118	2070756.47	6398904.18	299.35	SVNS-SET
2119	2069928.05	6399617.05	297.27	SVNS-SET
2120	2095476.11	6377103.27	313.14	SVFX MAG NAIL
2121	2093469.54	6378361.00	312.32	SVFX SET X @ WAL
2122	2091260.97	6380274.09	308.88	SVFX SET X @ WAL
2123	2090505.21	6380923.85	309.73	SVFX SET X @ WAL
2124	2090140.57	6381249.51	309.29	SVFX SET X @ WAL
2125	2089727.51	6381620.50	307.68	SVFX SET X @ WAL
2126	2089294.91	6381987.34	306.81	SVFX SET X @ WAL
2127	2088949.47	6382310.38	306.09	SVFX SET X @ WAL
2128	2088502.82	6383155.62	308.41	SVFX MAG NAIL
2129	2074782.16	6394879.36	303.92	SVNS-SET
2130	2072097.37	6397497.47	301.09	SVCX-SET
2131	2070574.90	6398832.16	298.95	SVCX-SET
2132	2069856.48	6399454.46	297.29	SVNS-SET
2143	2084422.76	6386736.42	305.24	SVNS-SET
2150	2121374.97	6354397.67	305.05	SET MAG NAIL-SCAN CONTROL MARK
2151	2121492.22	6354440.63	304.09	SET MAG NAIL-SCAN CONTROL MARK
2152	2122803.11	6353303.14	306.25	SET MAG NAIL-SCAN CONTROL MARK
2153	2122844.29	6353115.12	306.27	SET MAG NAIL-SCAN CONTROL MARK
2154	2123957.67	6352152.51	304.29	SET MAG NAIL-SCAN CONTROL MARK
2155	2124018.23	6352239.92	303.44	SET MAG NAIL-SCAN CONTROL MARK
2156	2125507.00	6351169.94	301.83	SET MAG NAIL-SCAN CONTROL MARK
2157	2125437.29	6351020.12	301.56	SET MAG NAIL-SCAN CONTROL MARK
2158	2125426.00	6350869.16	303.17	SET MAG NAIL-SCAN CONTROL MARK
2159	2125325.80	6350837.24	299.45	SET MAG NAIL-SCAN CONTROL MARK
2160	2124650.18	6351123.06	302.82	SET MAG NAIL-SCAN CONTROL MARK
2161	2125474.61	6350391.74	302.65	SET MAG NAIL-SCAN CONTROL MARK
2162	2125987.98	6350383.60	302.12	SET MAG NAIL-SCAN CONTROL MARK
2163	2126058.58	6350463.21	301.19	SET MAG NAIL—SCAN CONTROL MARK

	DATE	RECORD DRAWING		
DESIGNED:	3/12/2021	RESIDENT ENGINEER	DATE]
DRAWN:	3/12/2021] [
CHECKED:	3/12/2021] '
FOR RIGHT OF WAY DATA AND ACCURATE ACCESS DETERMINATION. SEE DOCUMENTS IN THE DEPARTMENT OF PUBLIC WORKS AND PLANNING.				





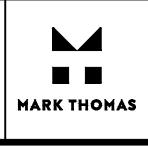





PROJECT


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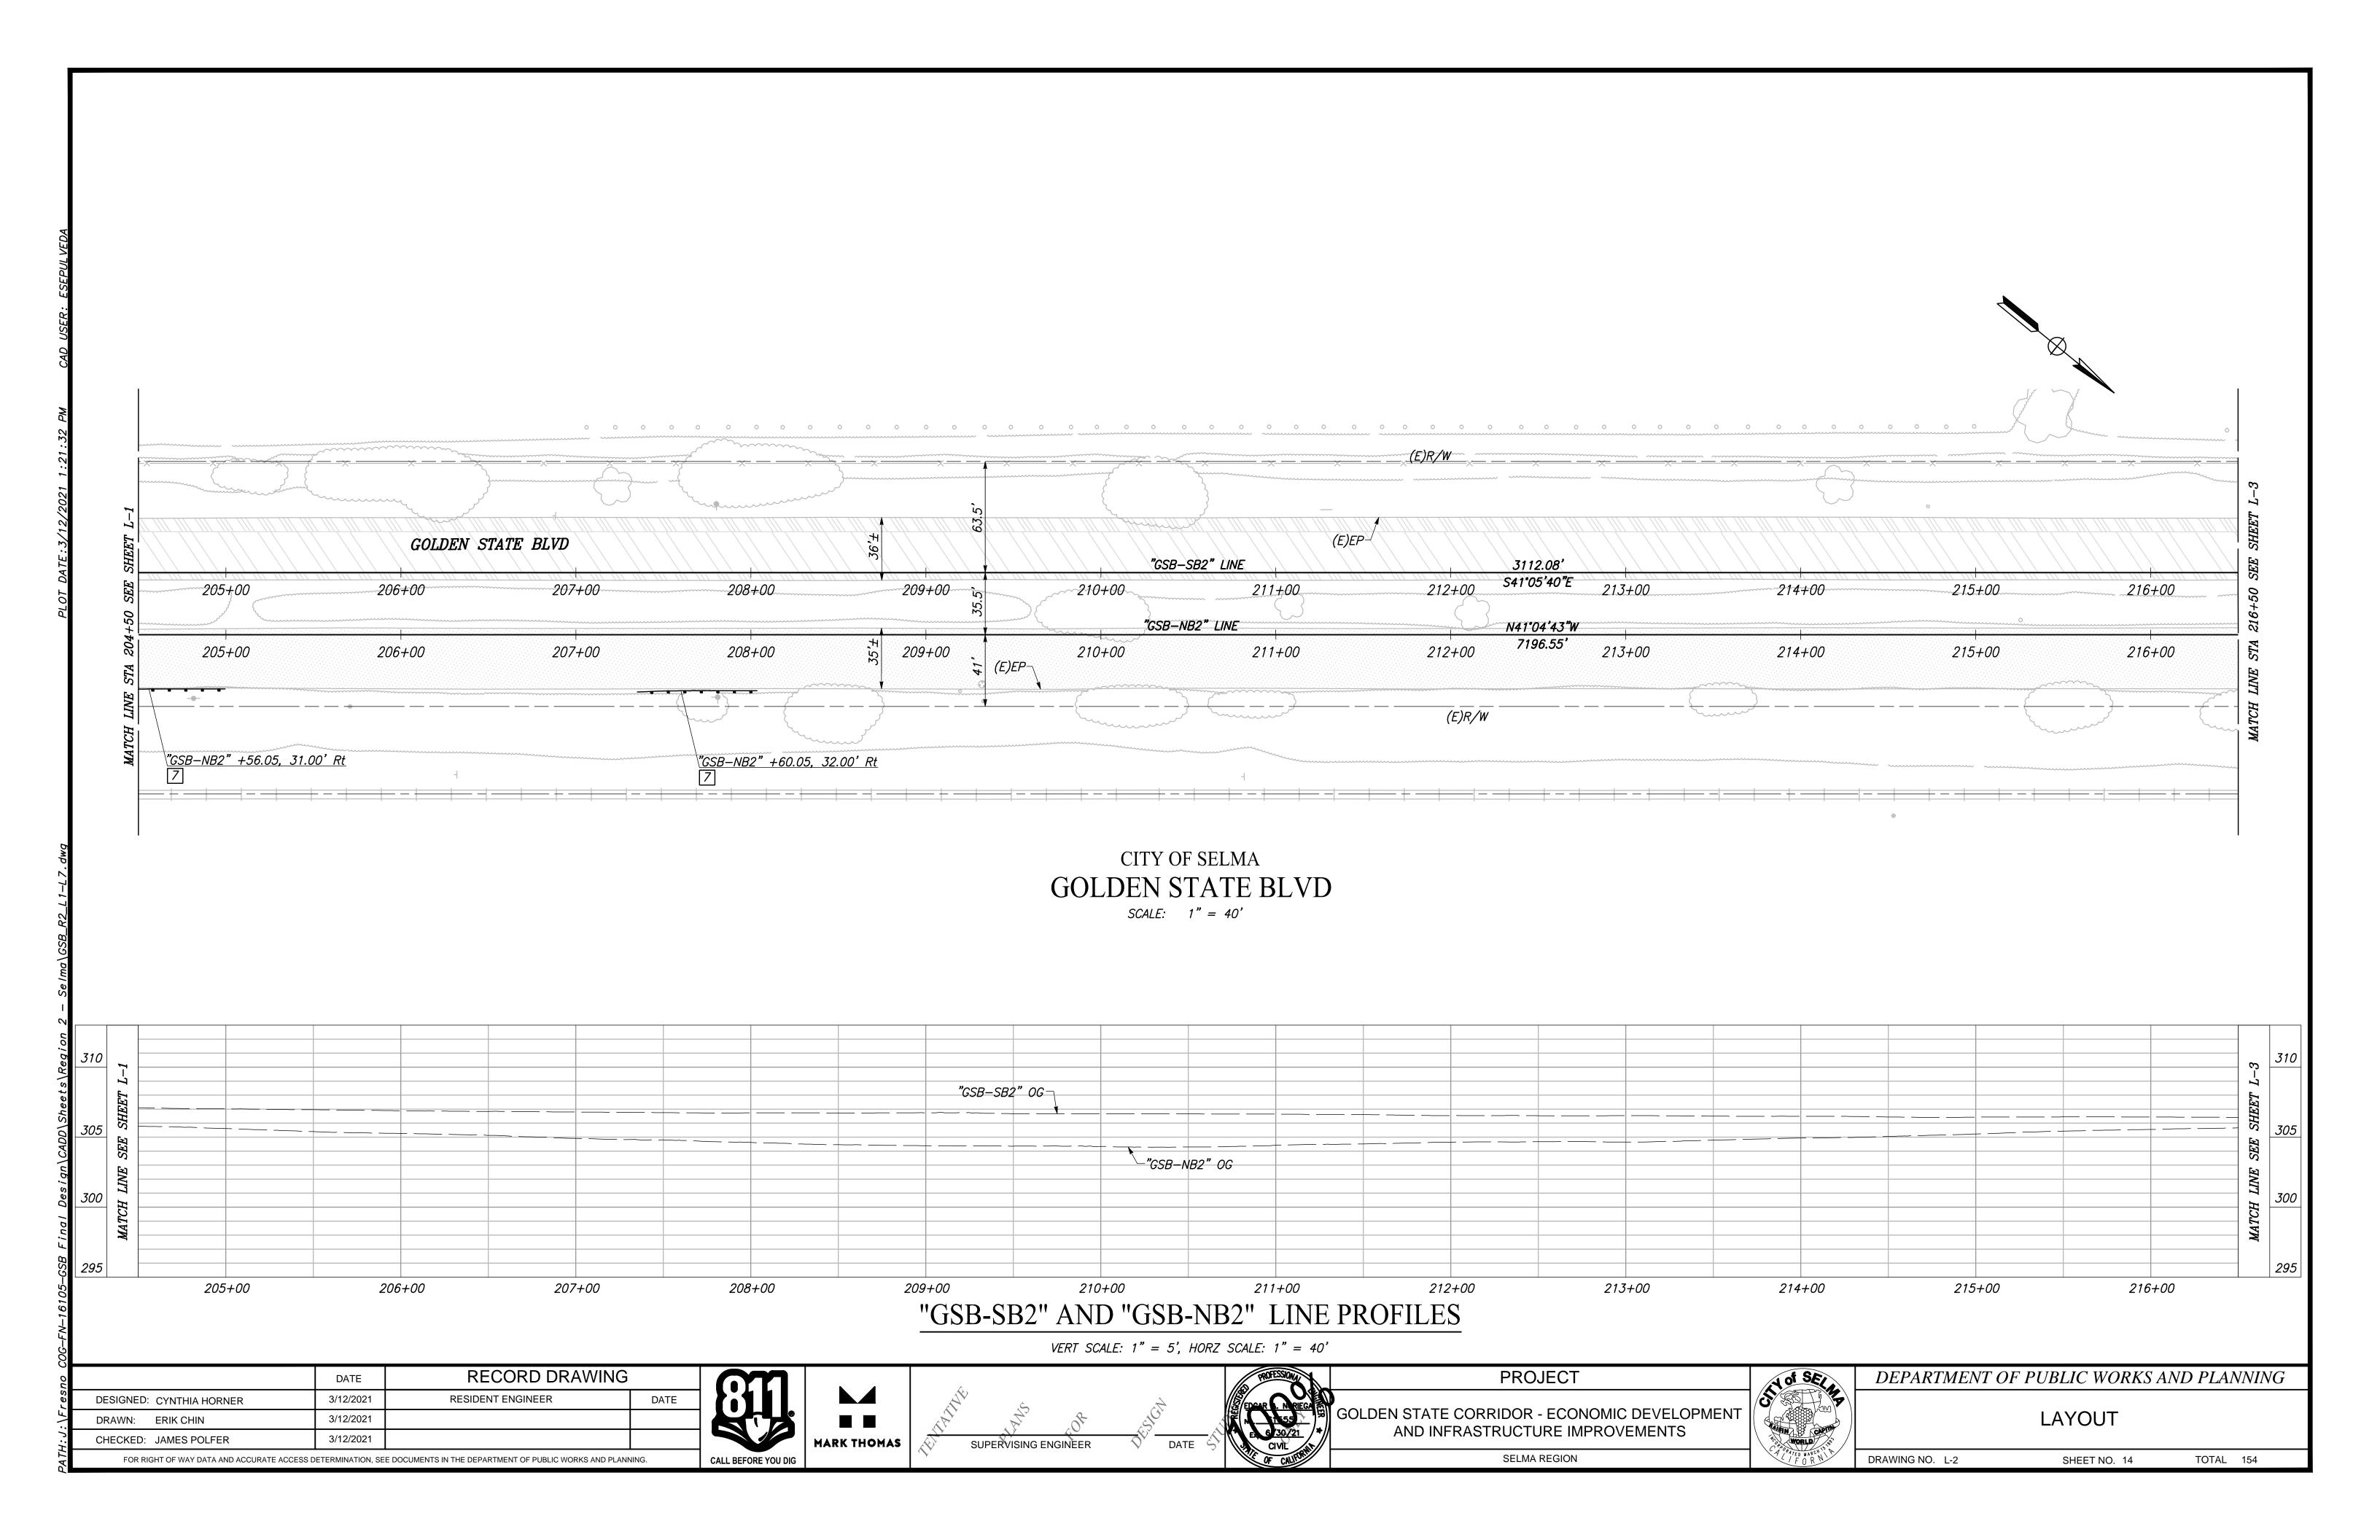
DEPARTMENT OF PUBLIC WORKS AND PLANNING


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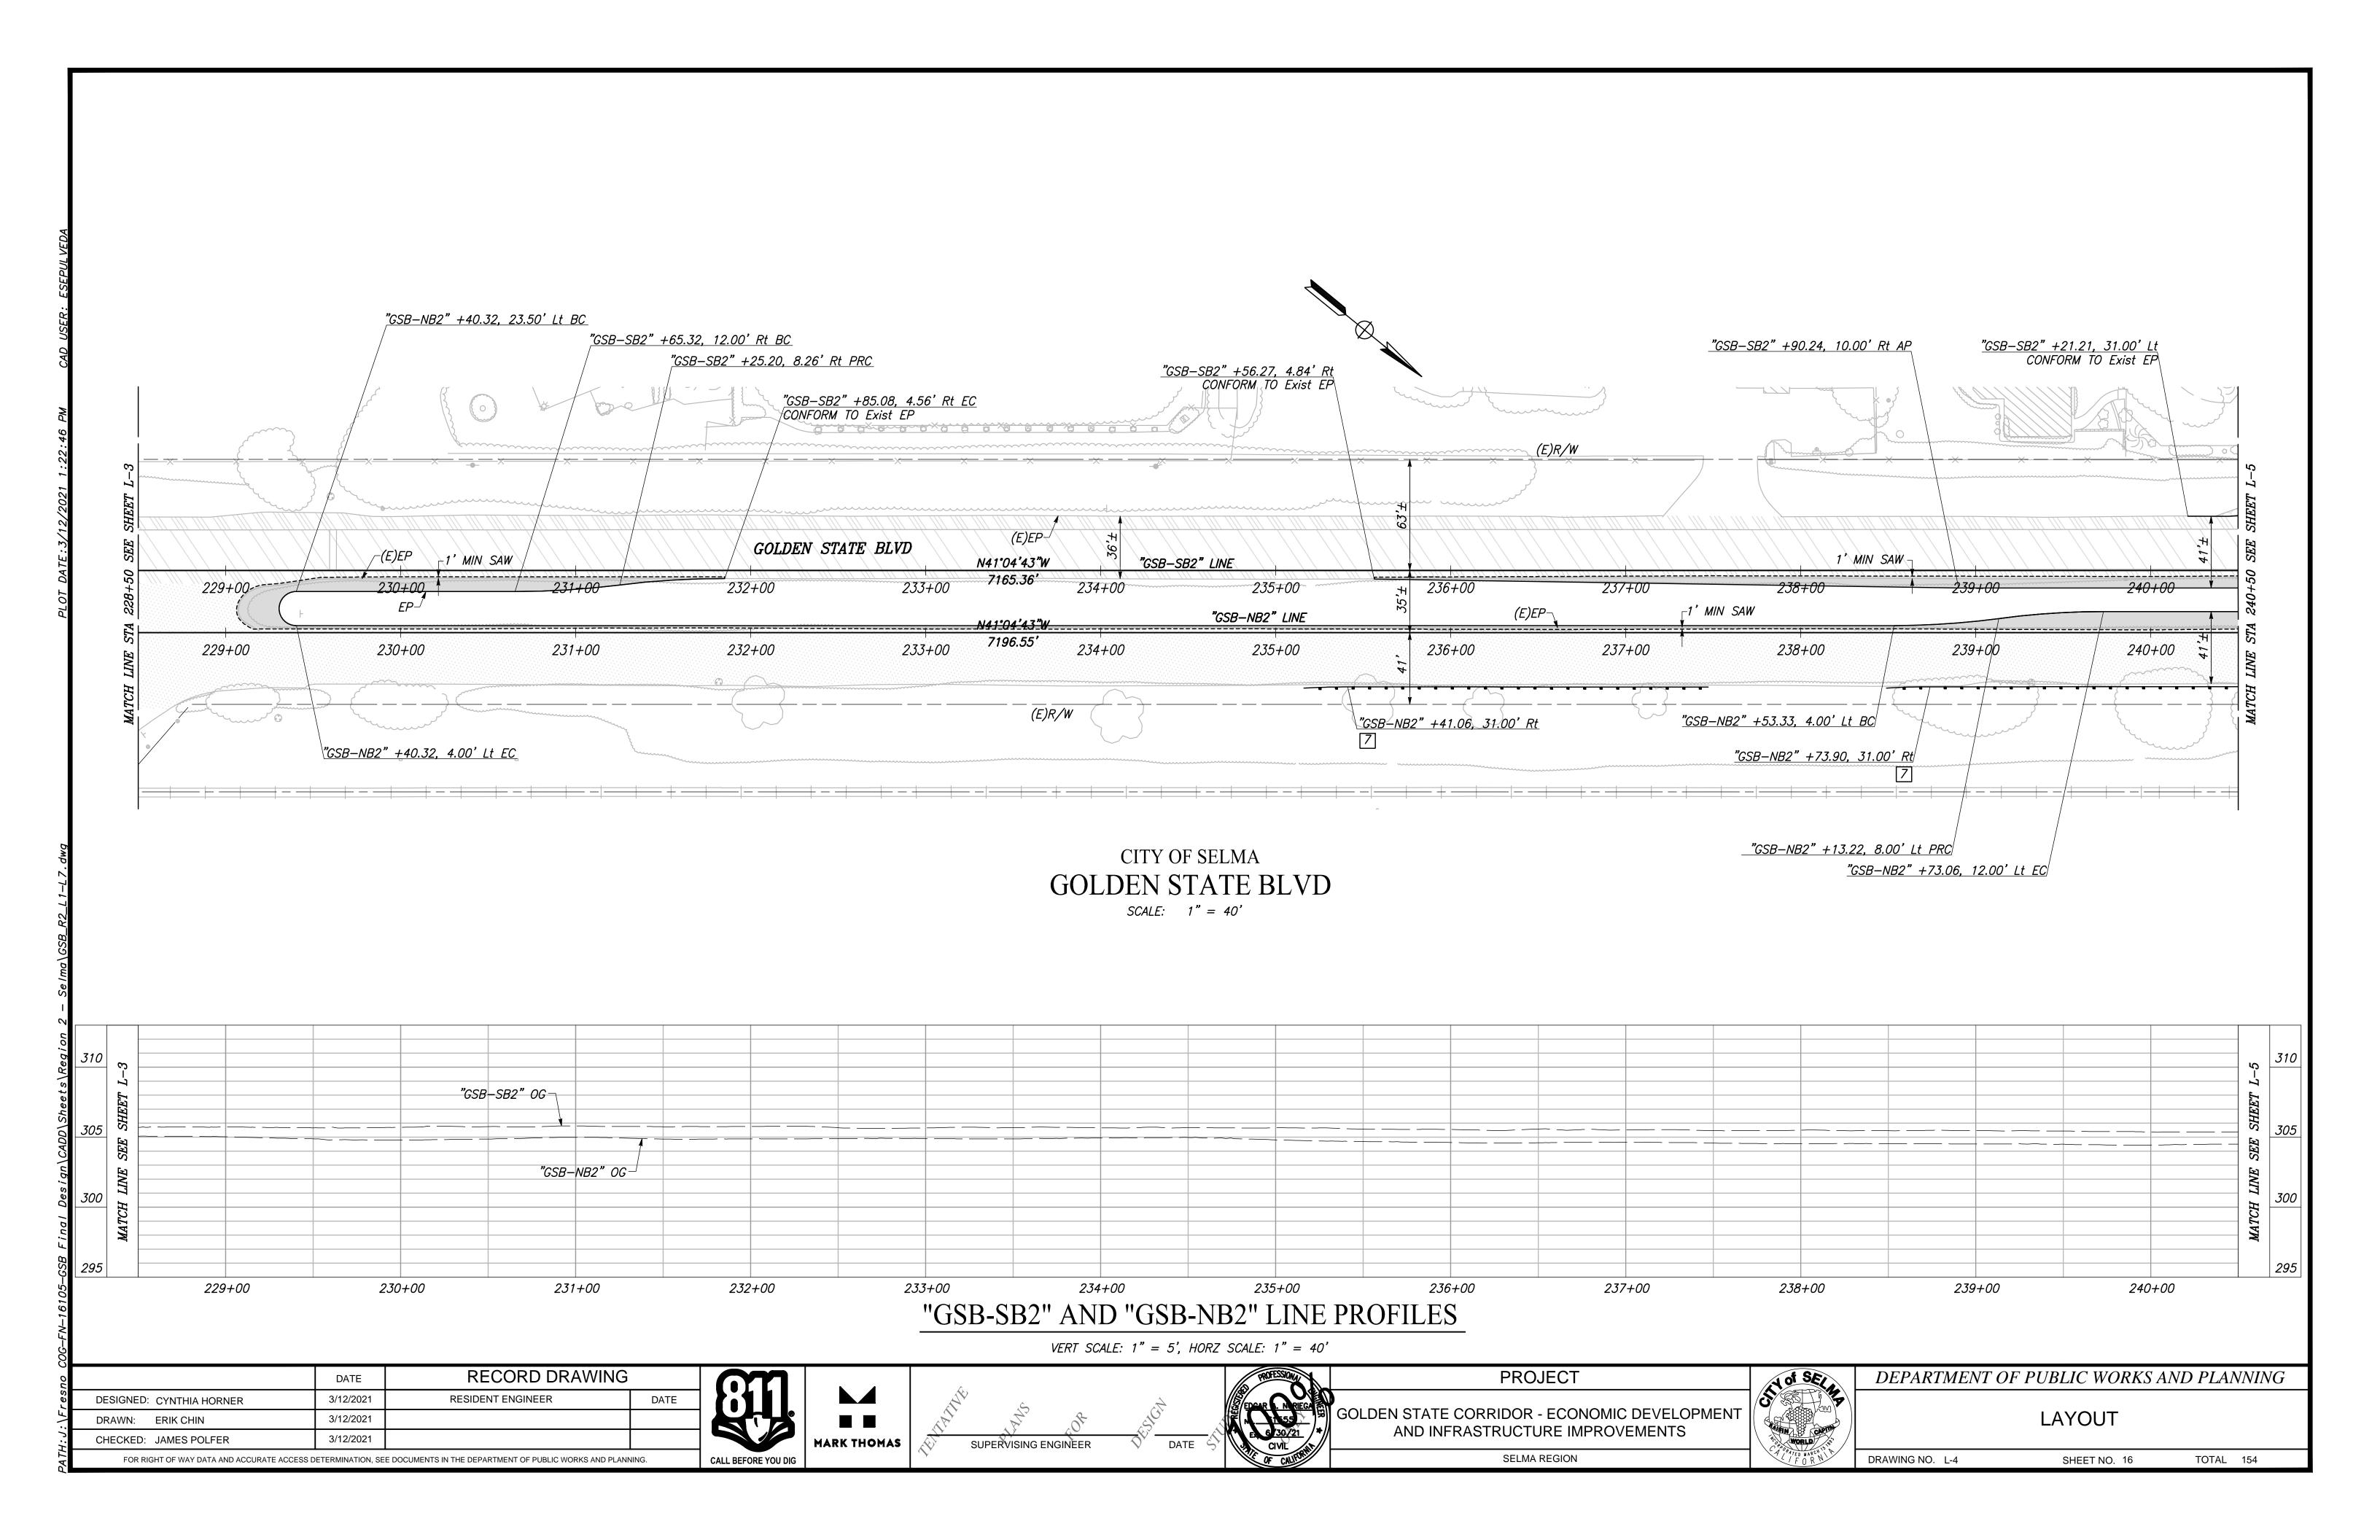
DRAWING NO. PC-3 SHEET NO. 12 T


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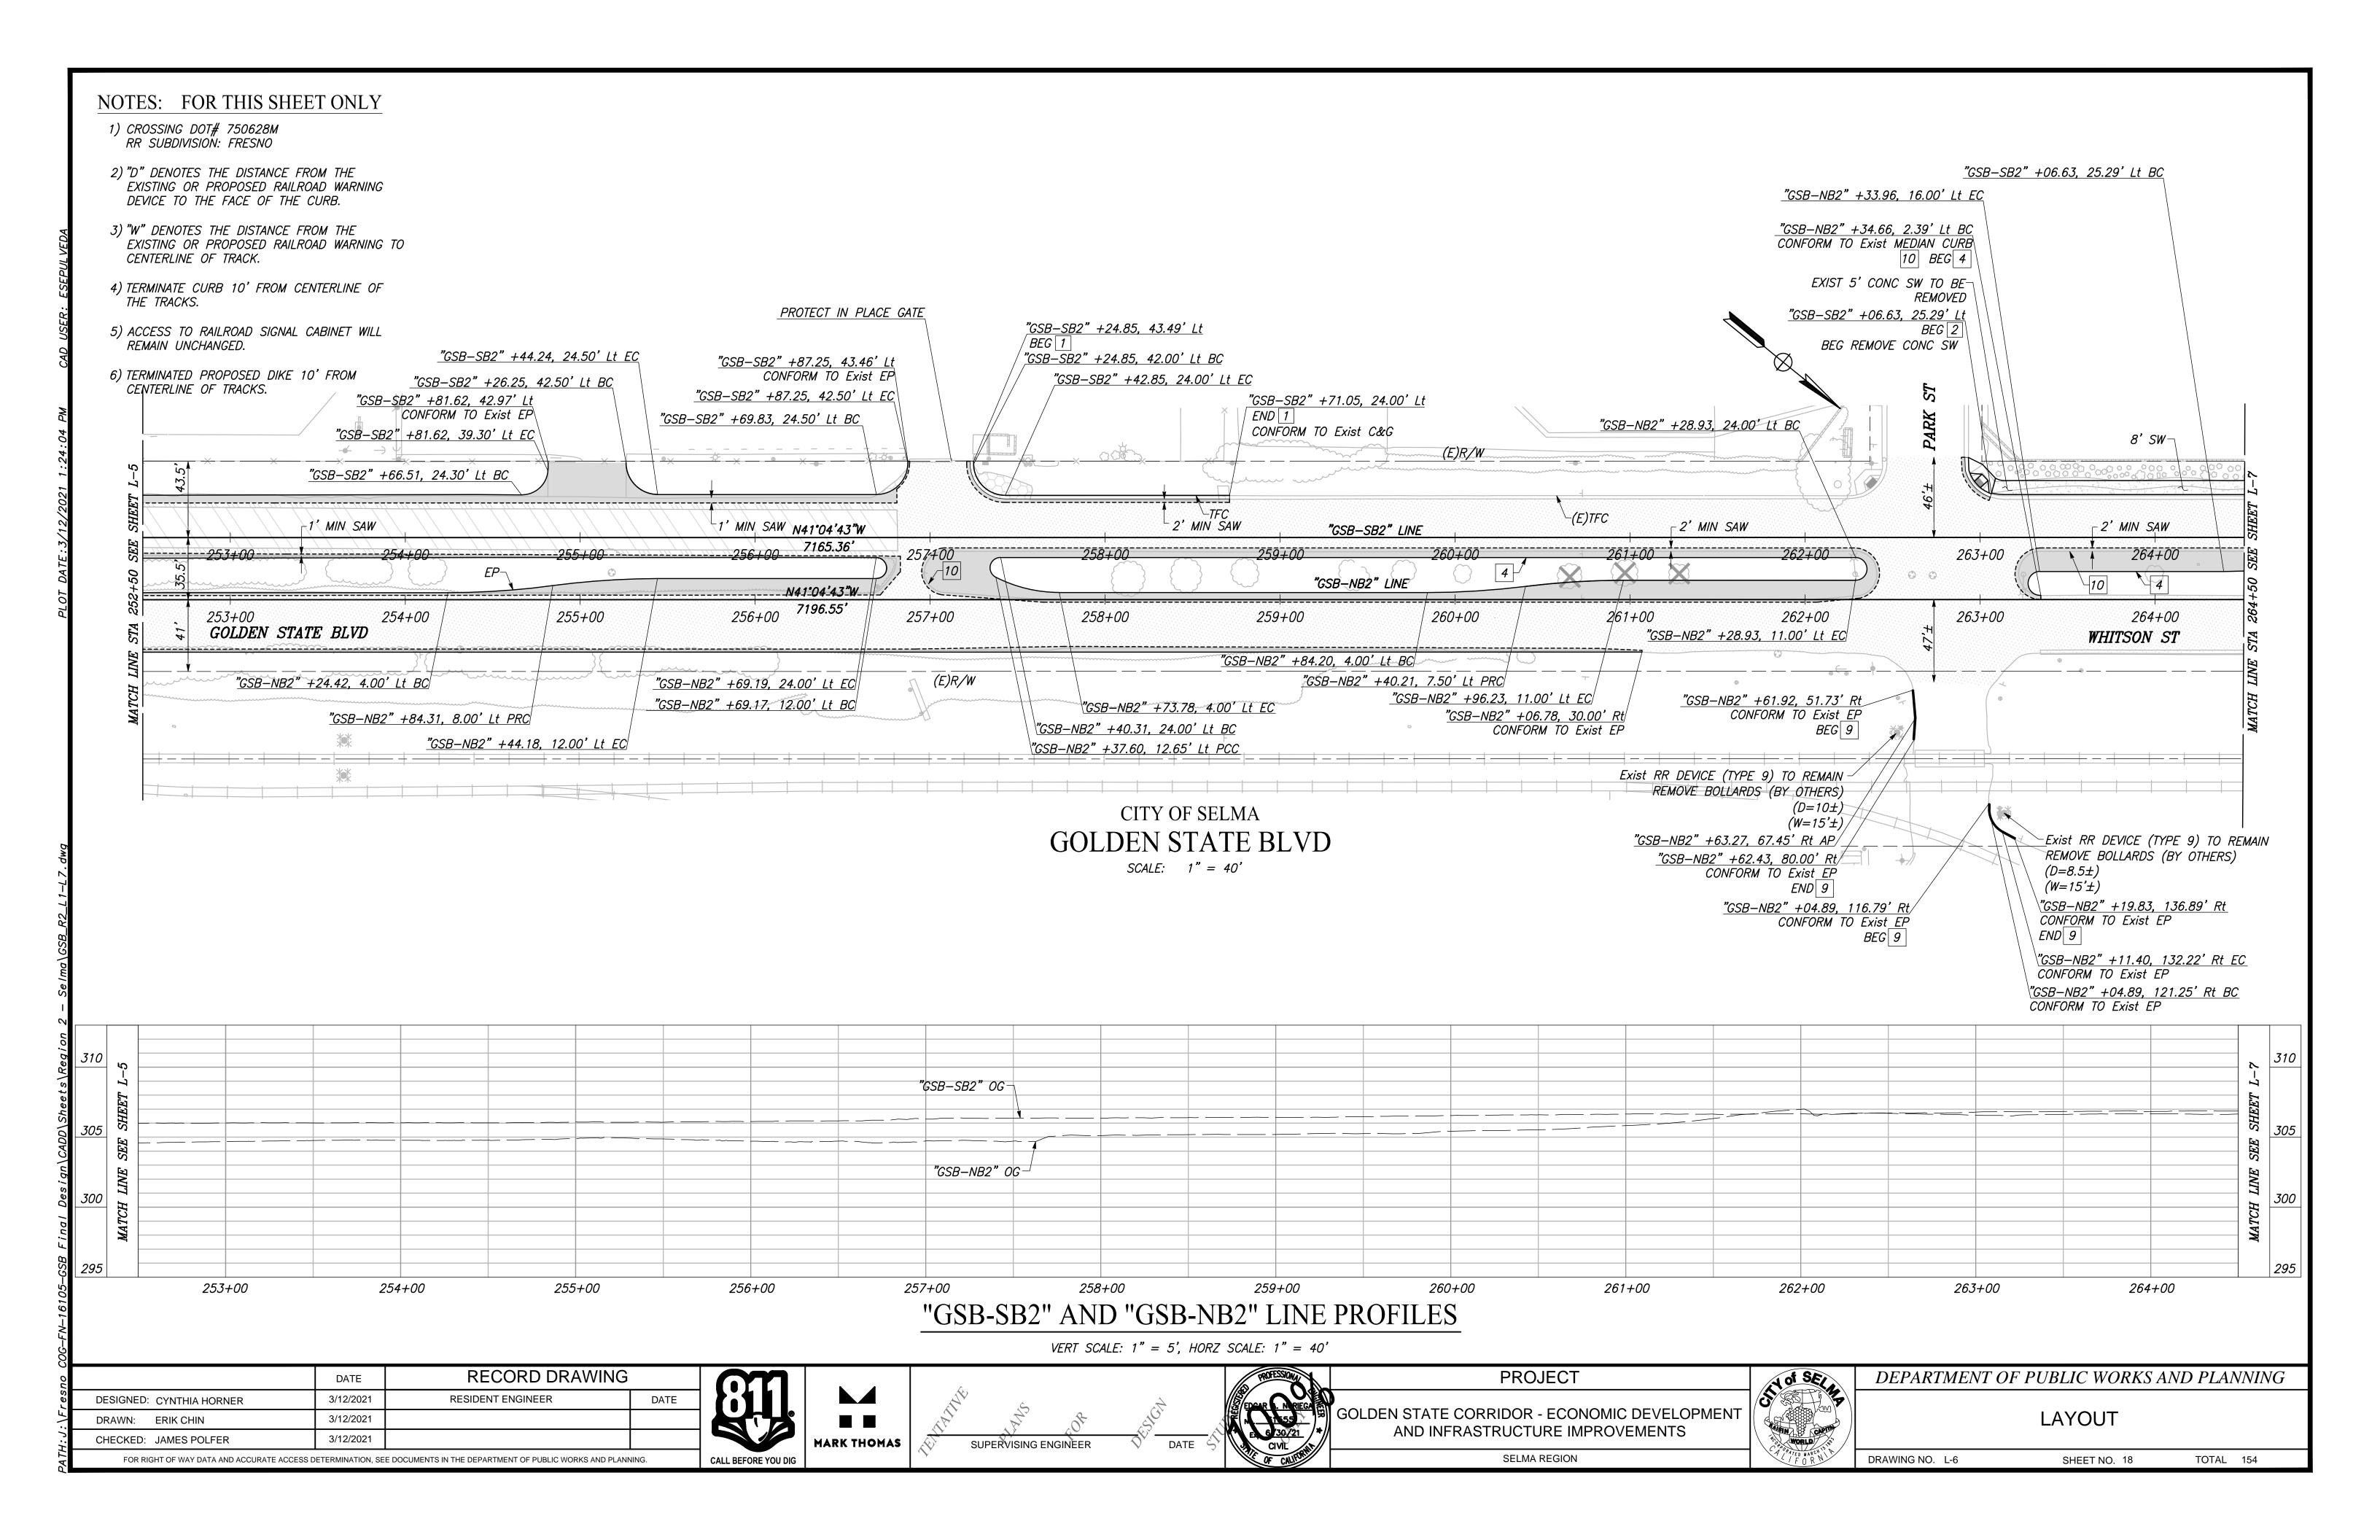








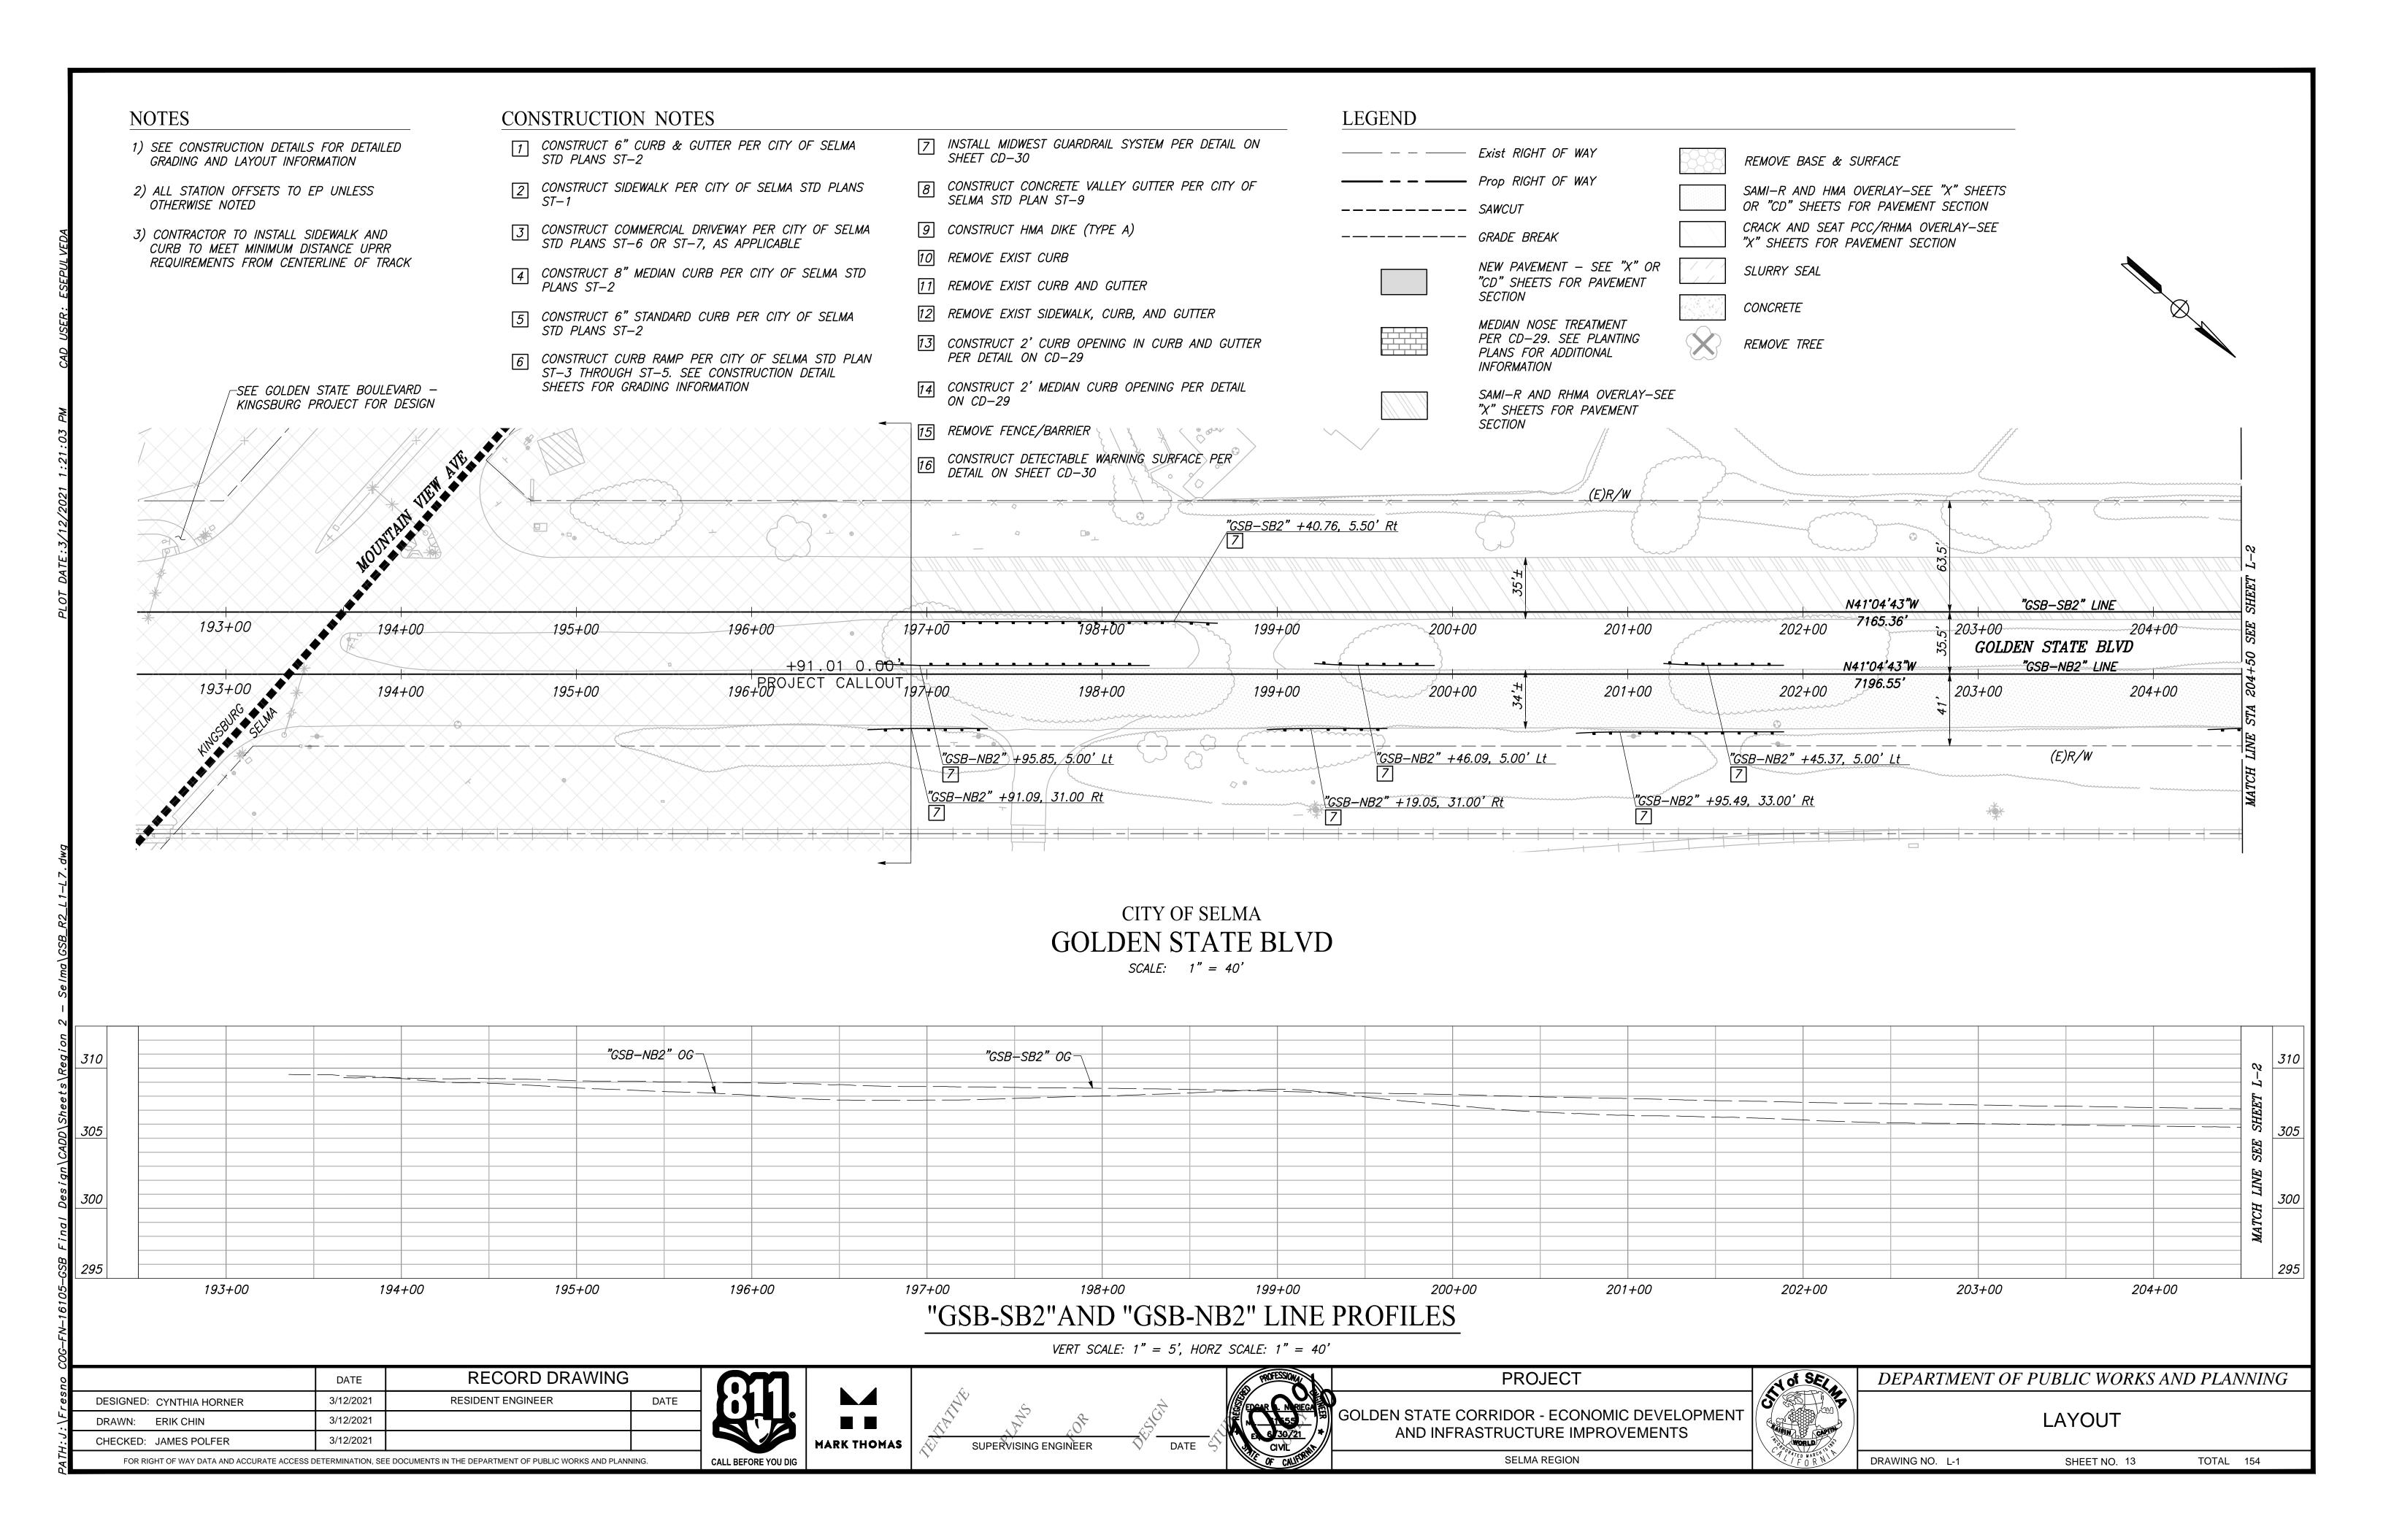


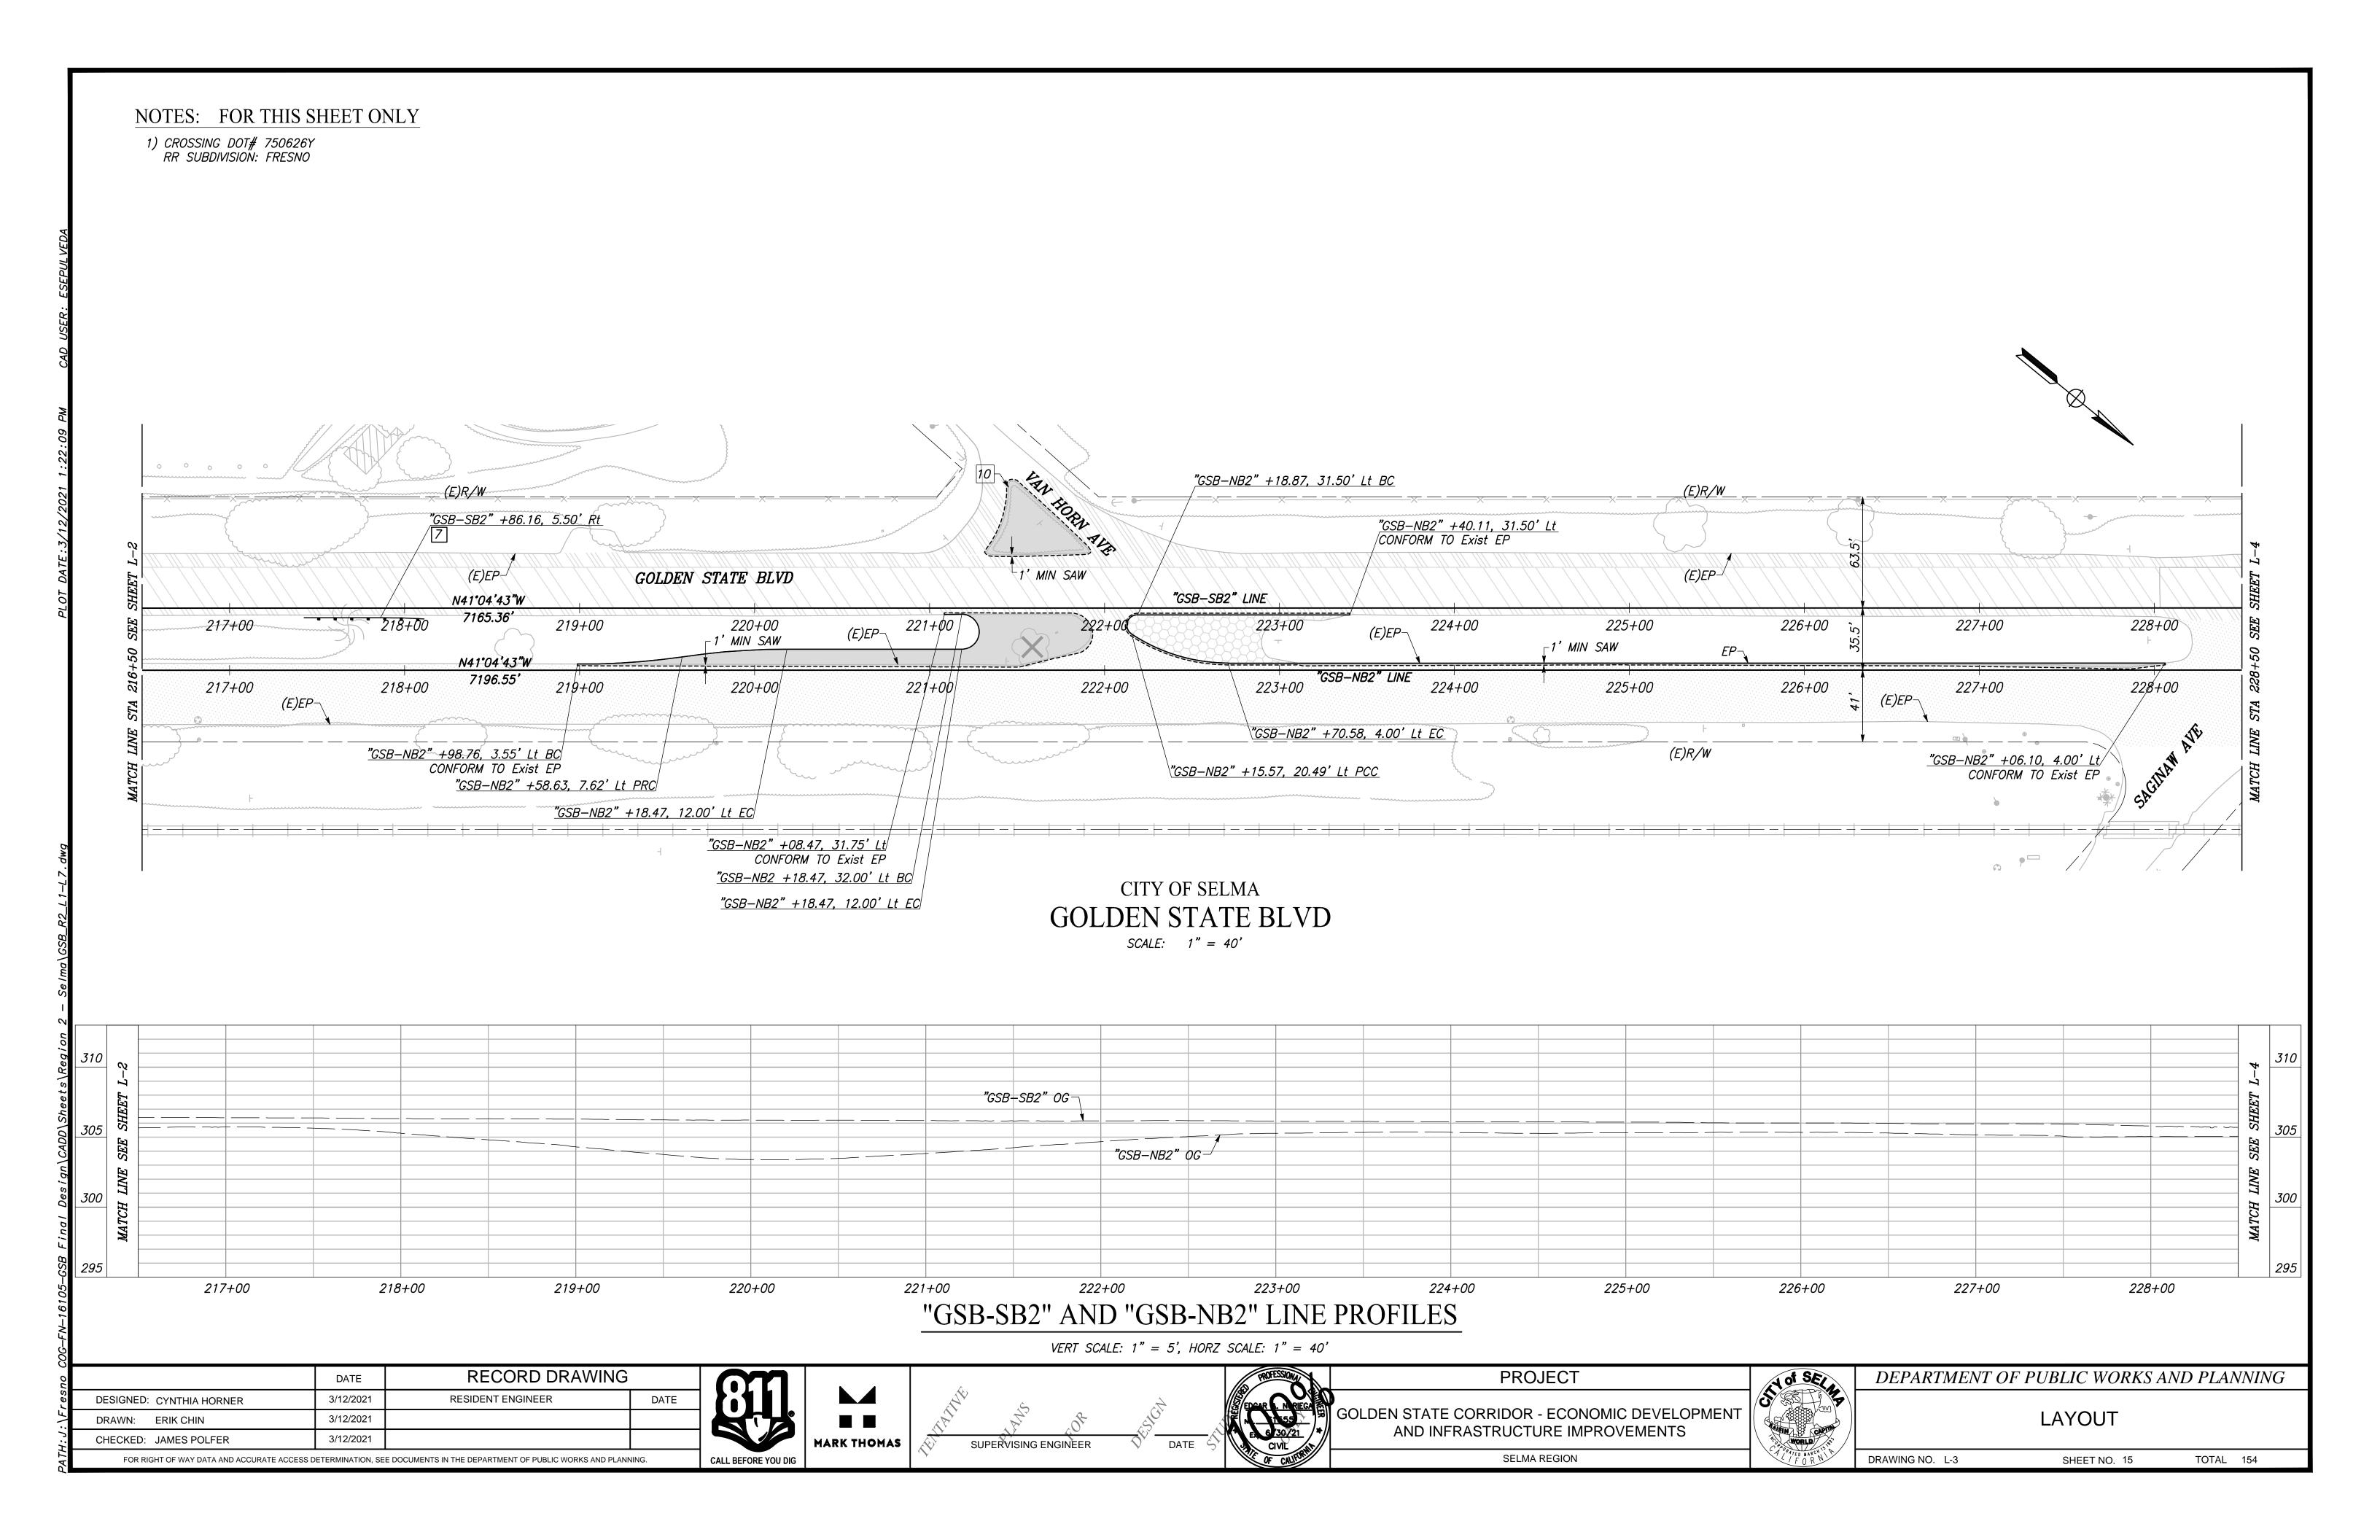


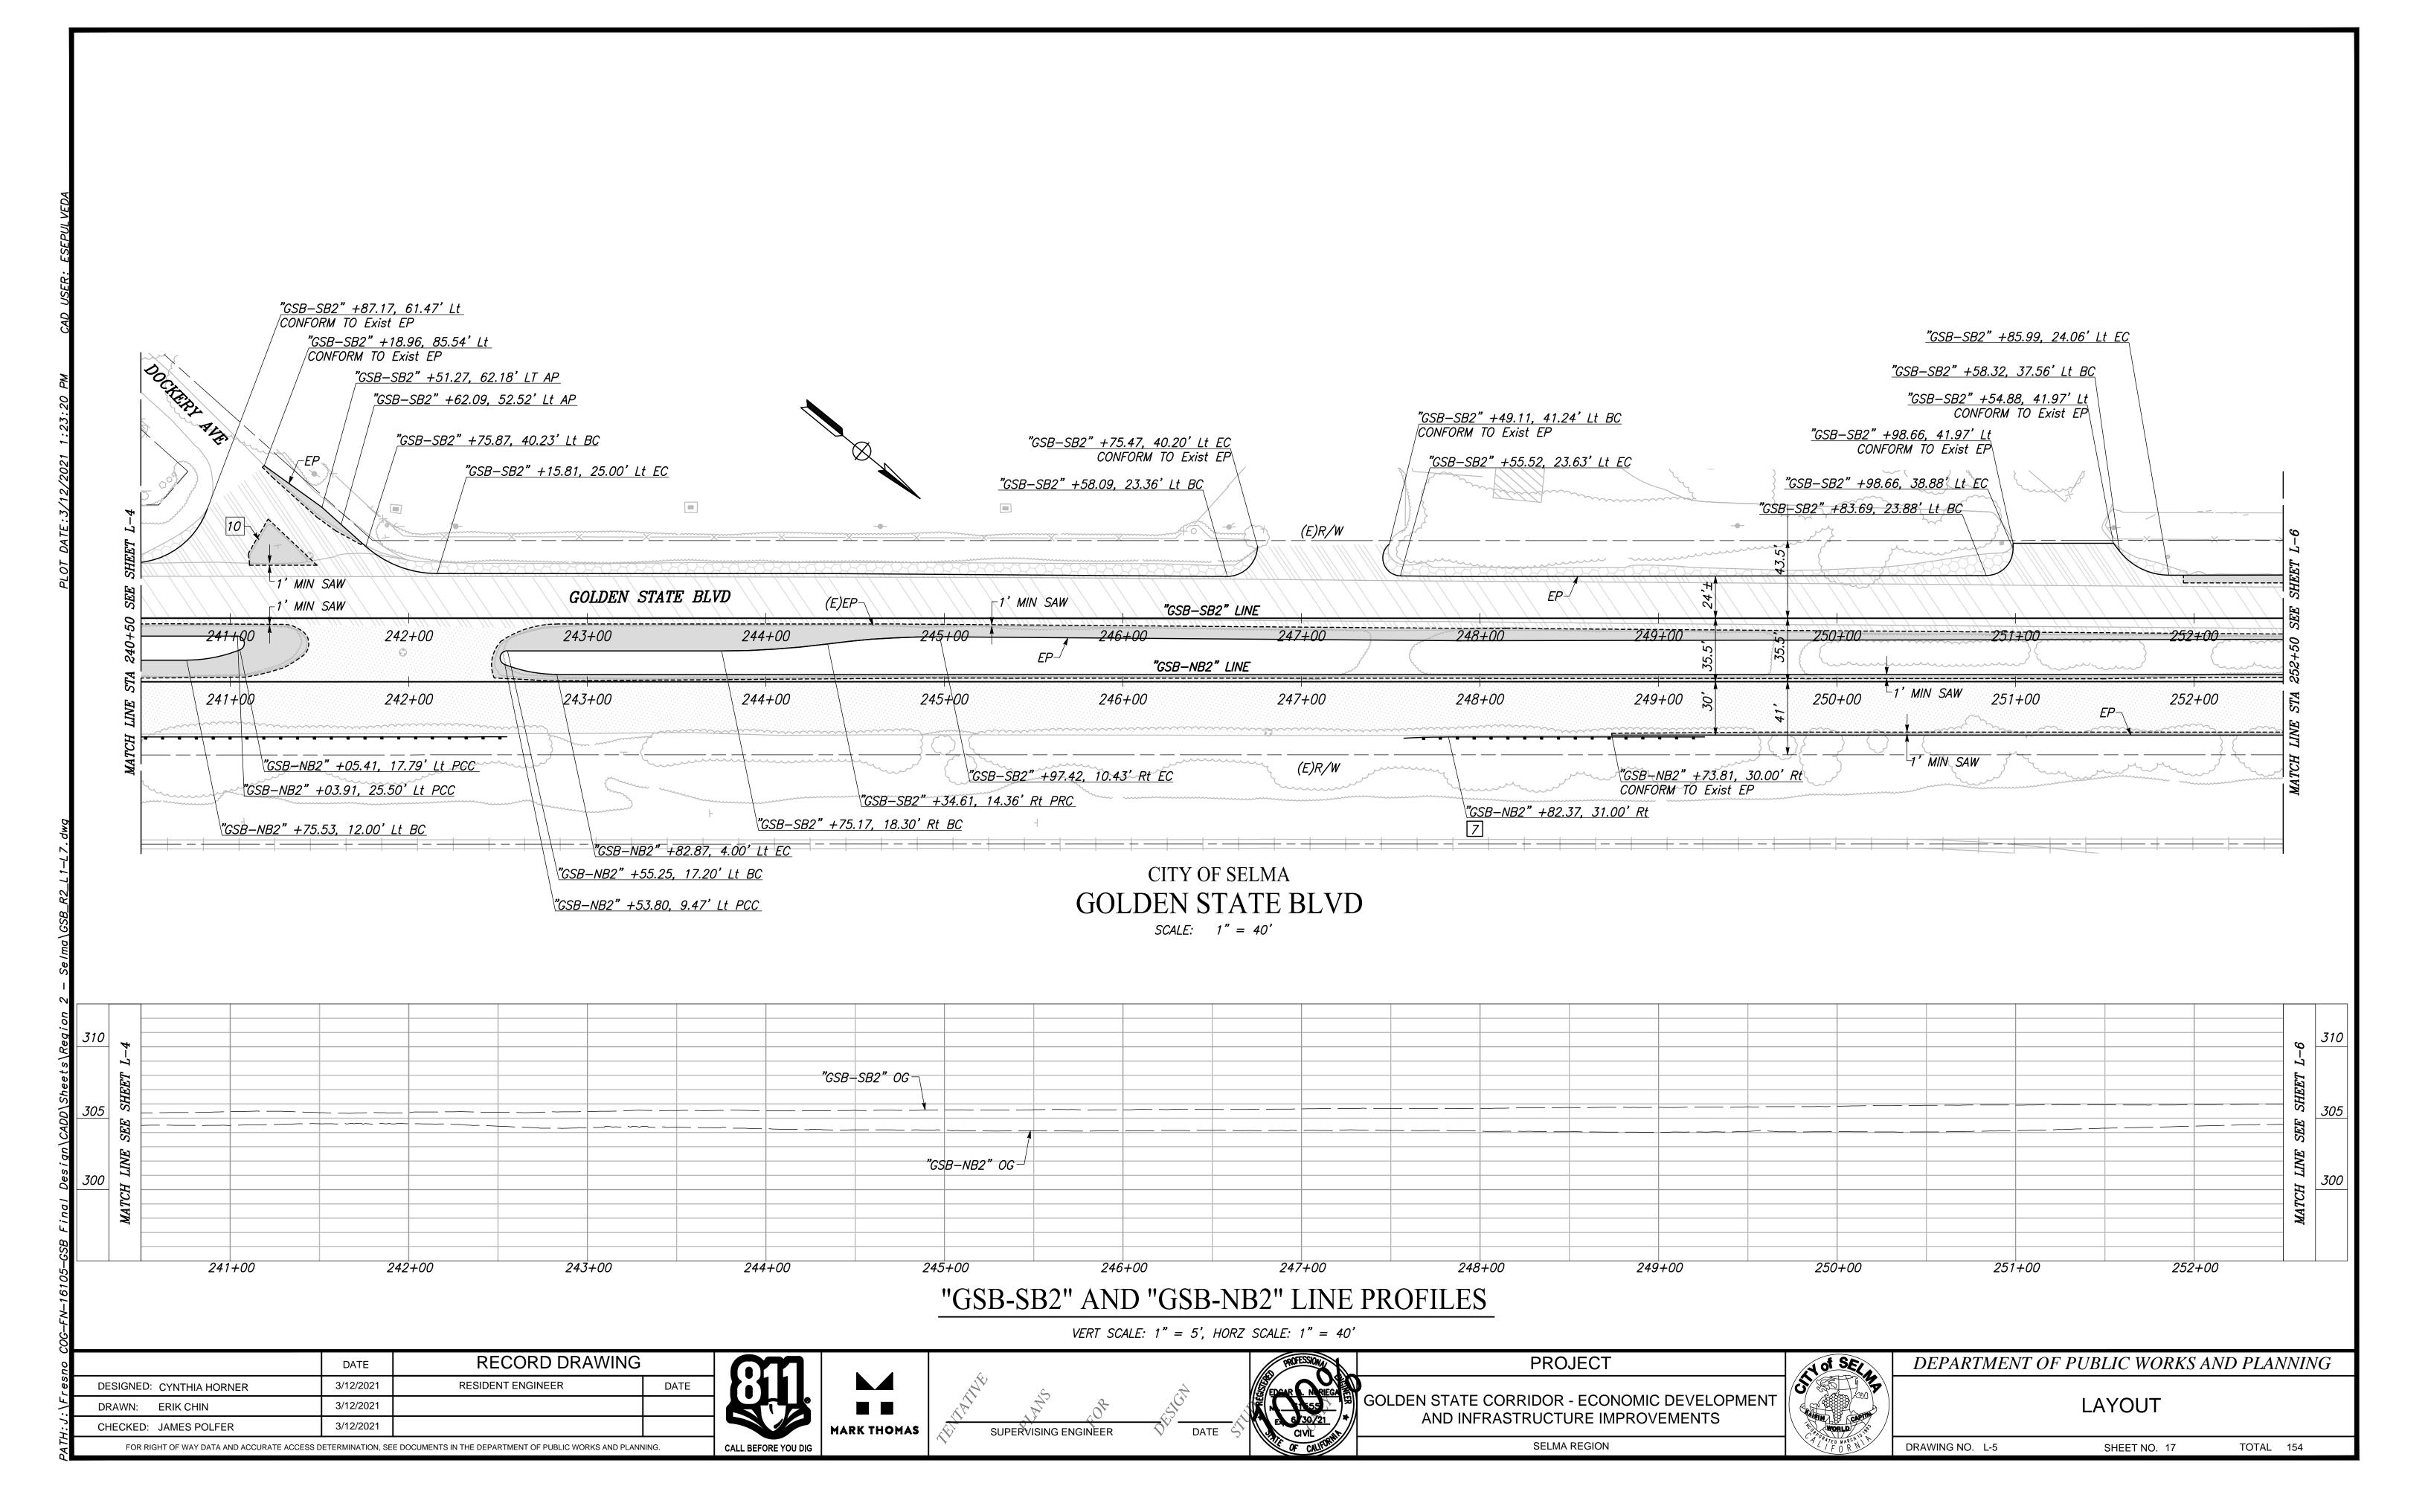


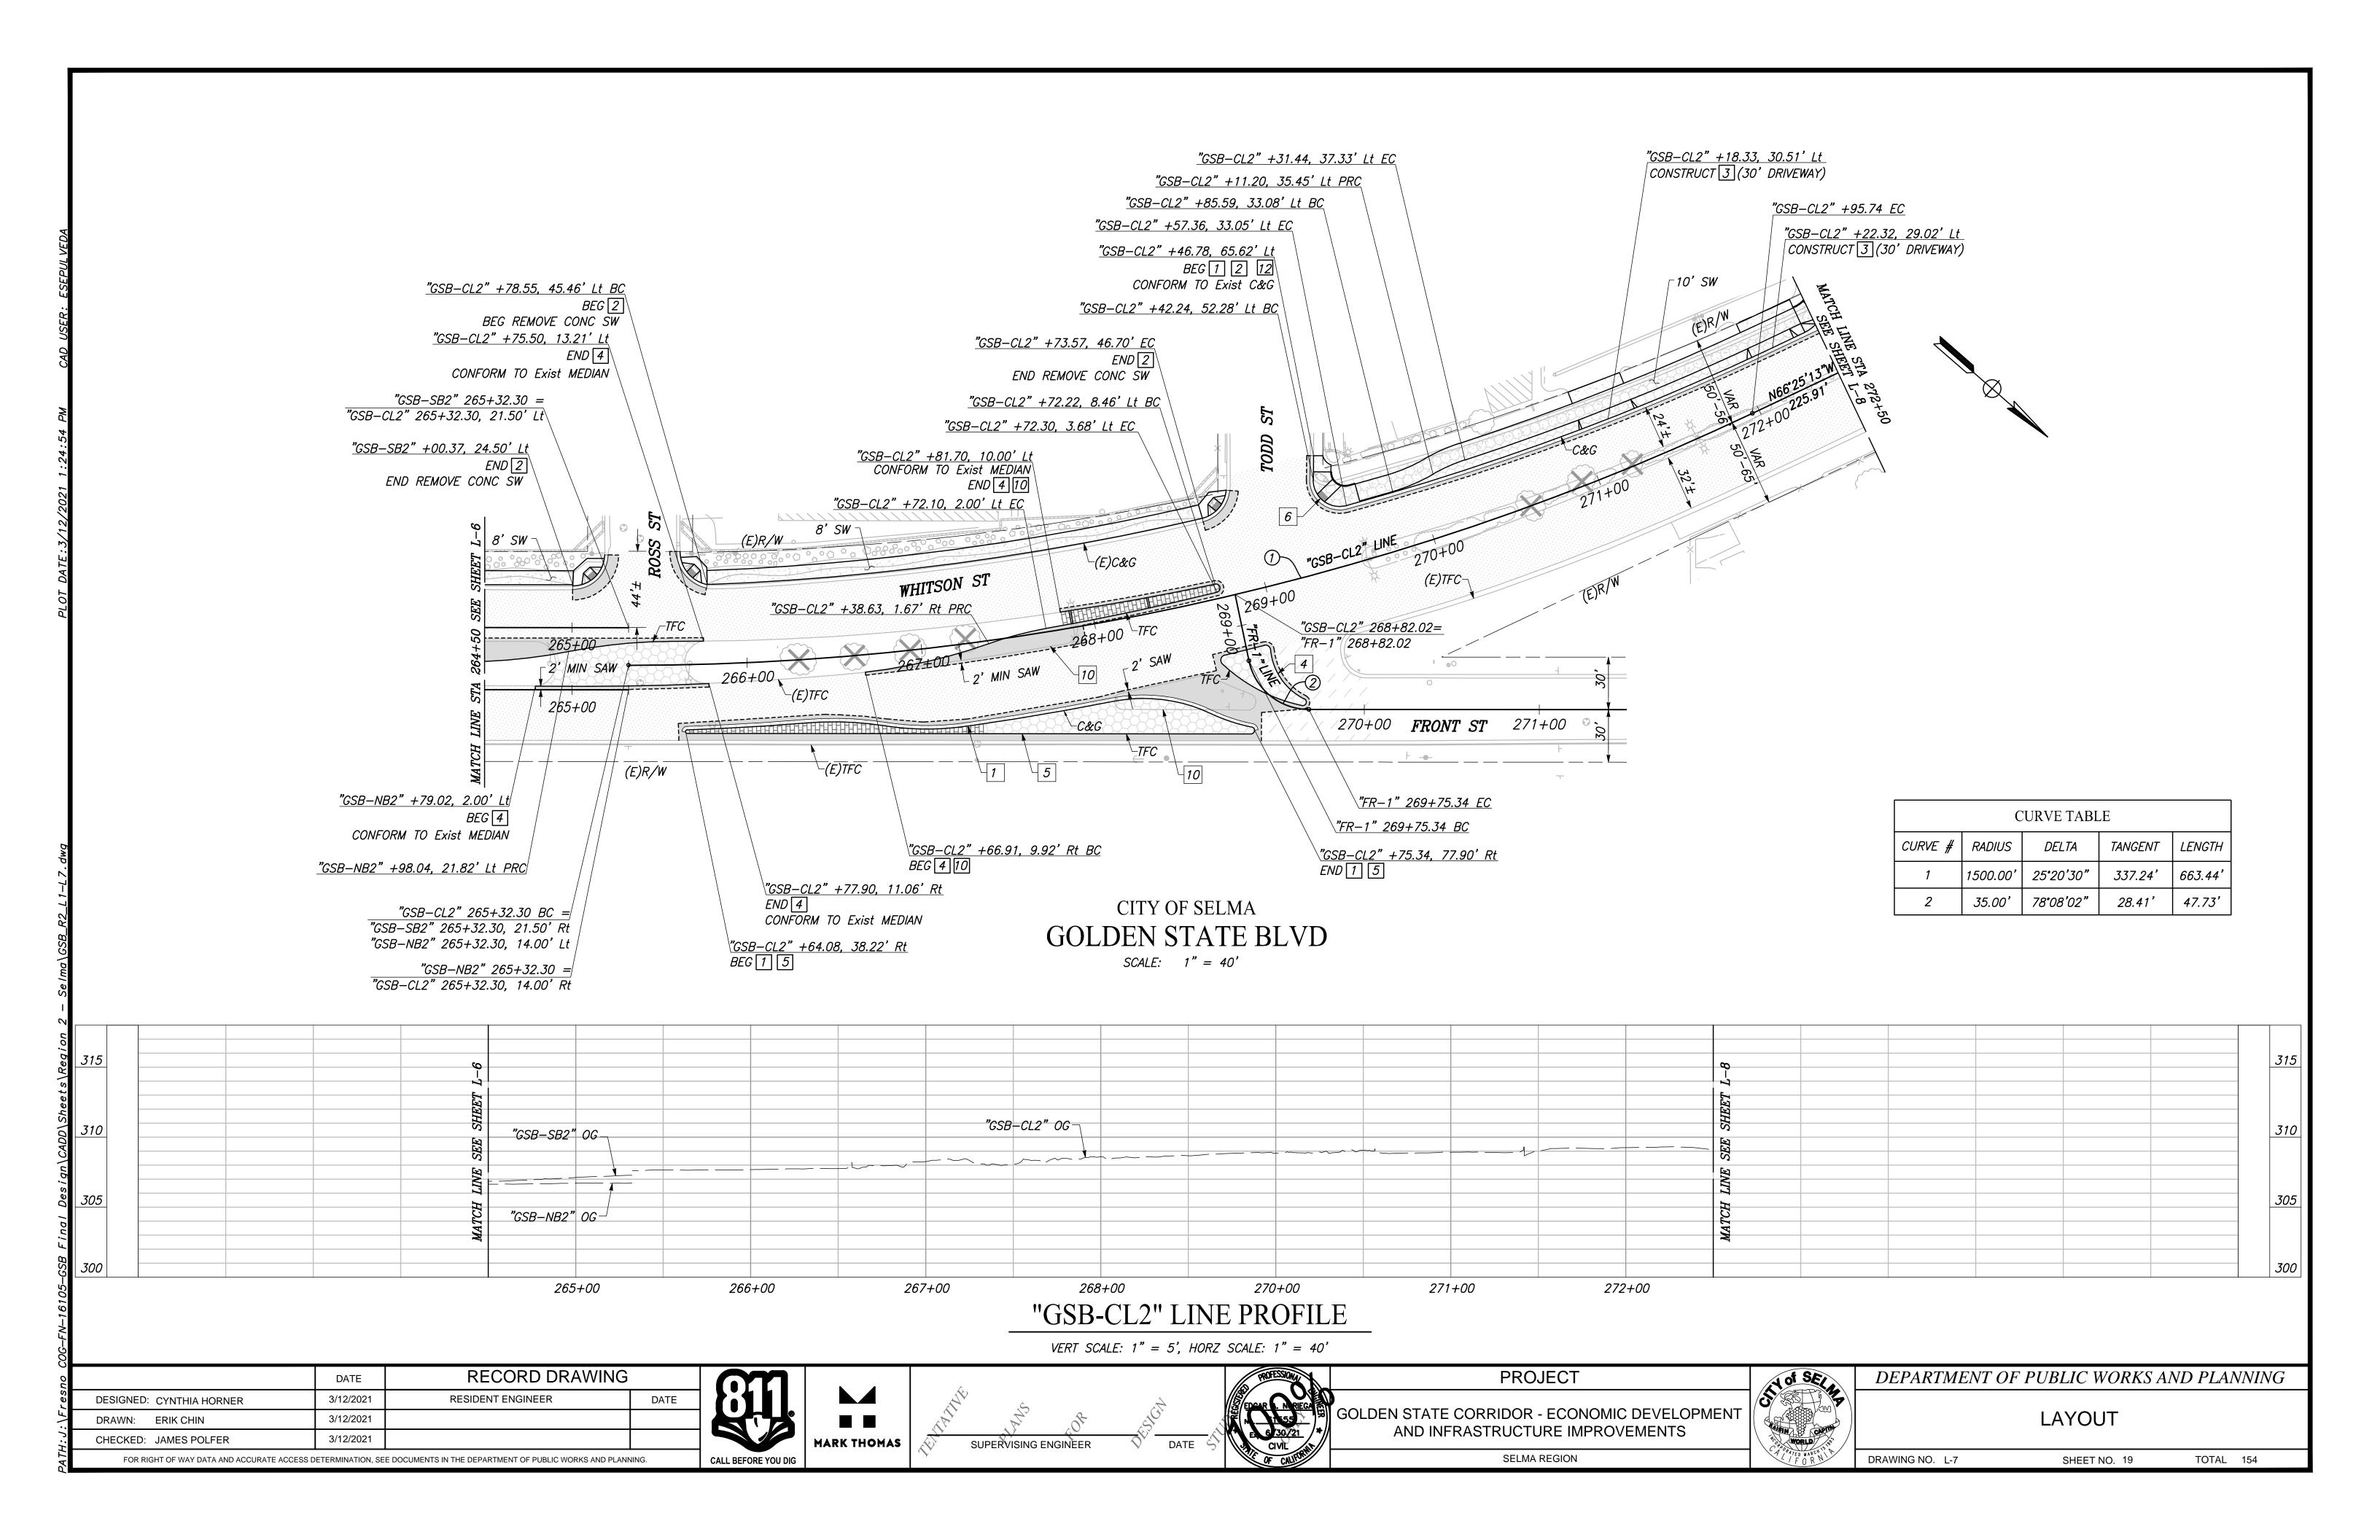


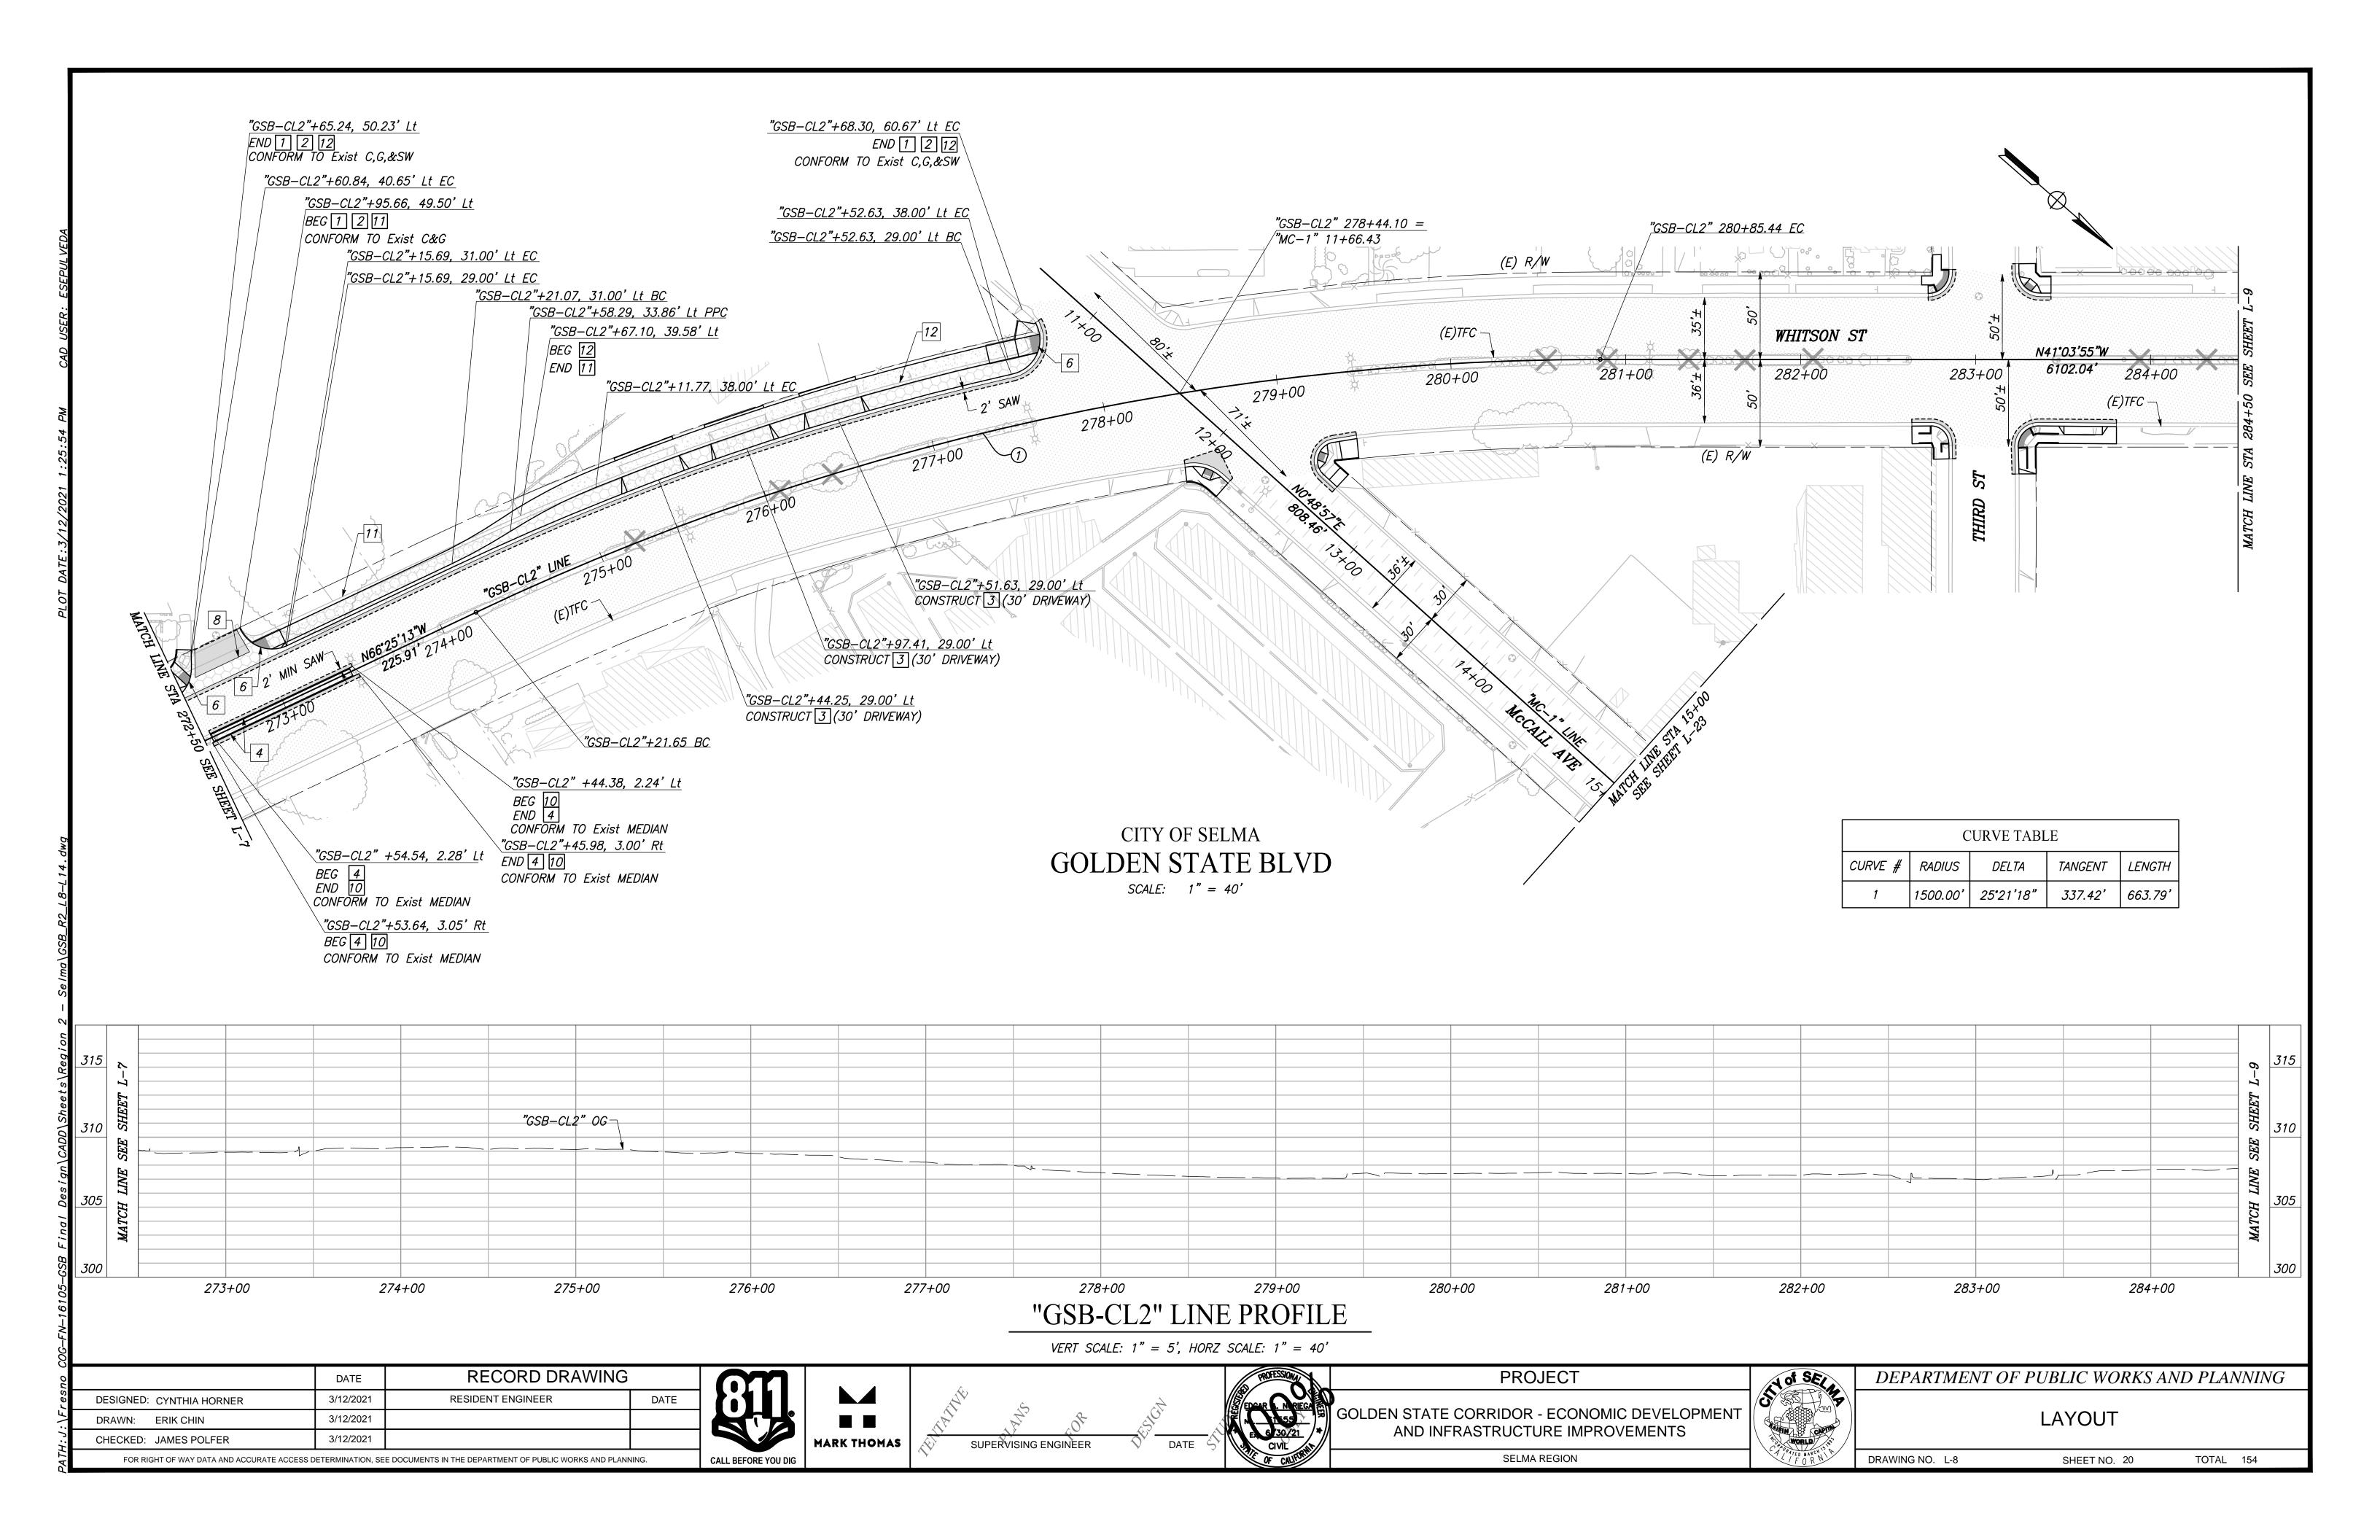


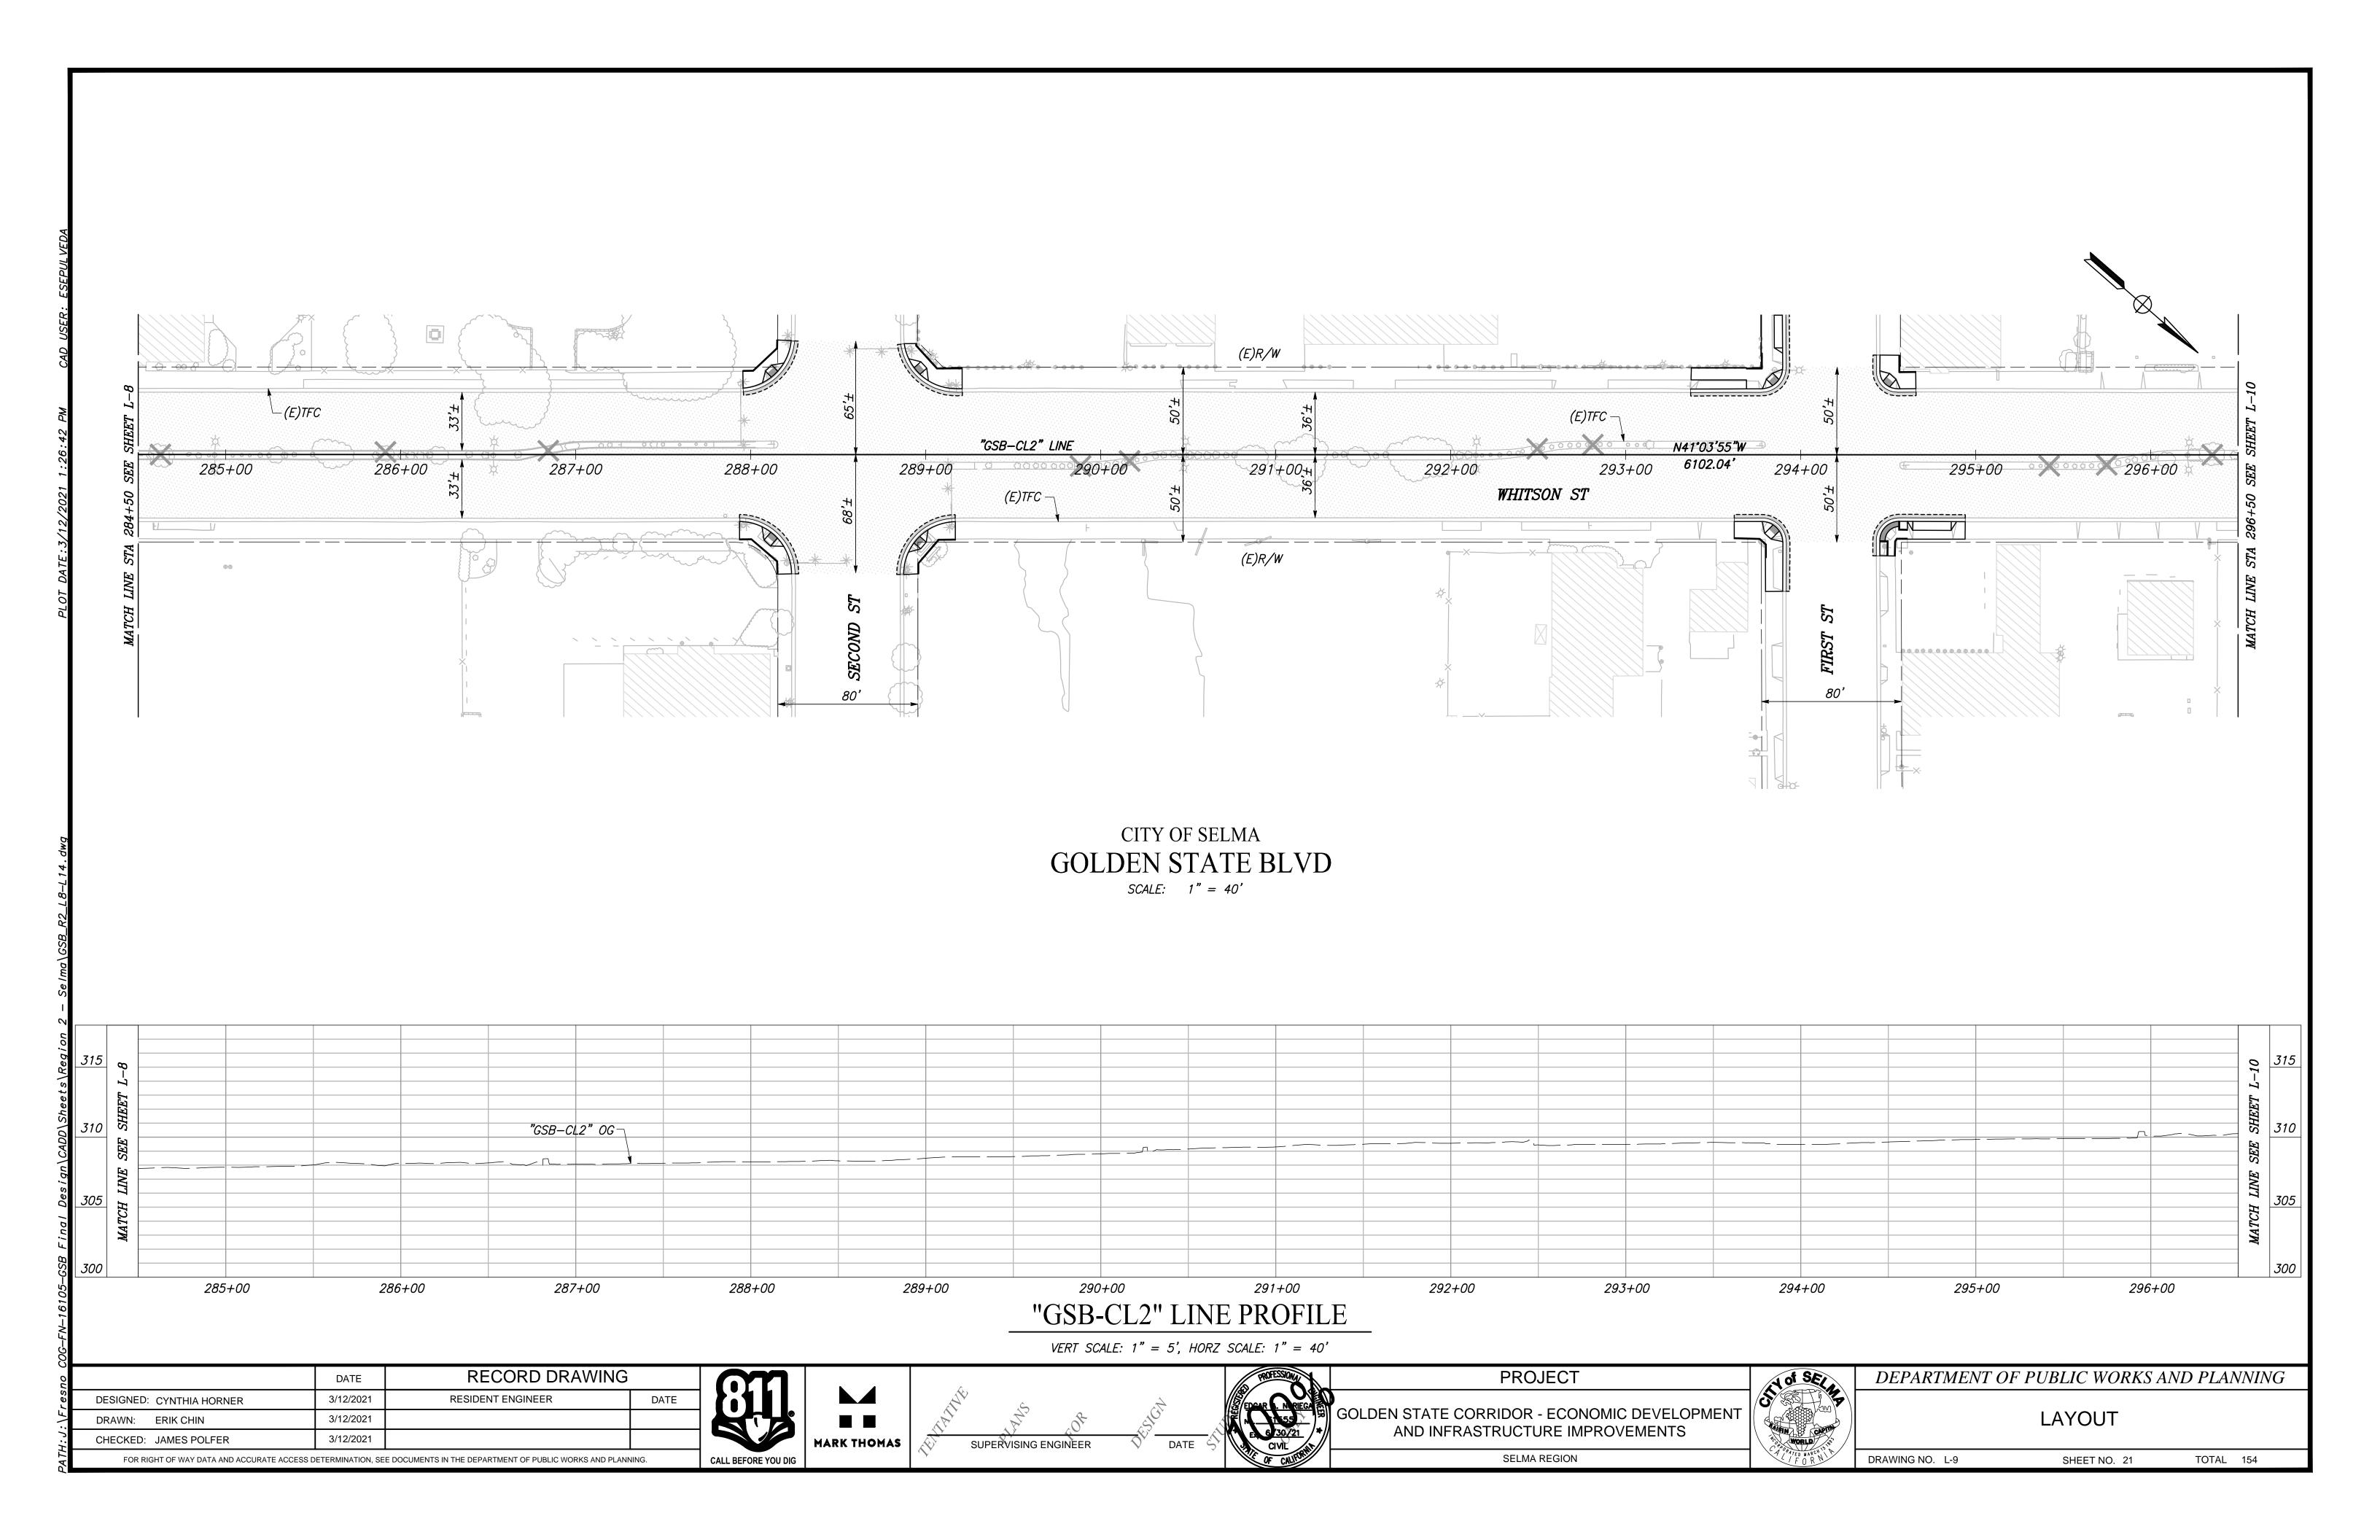


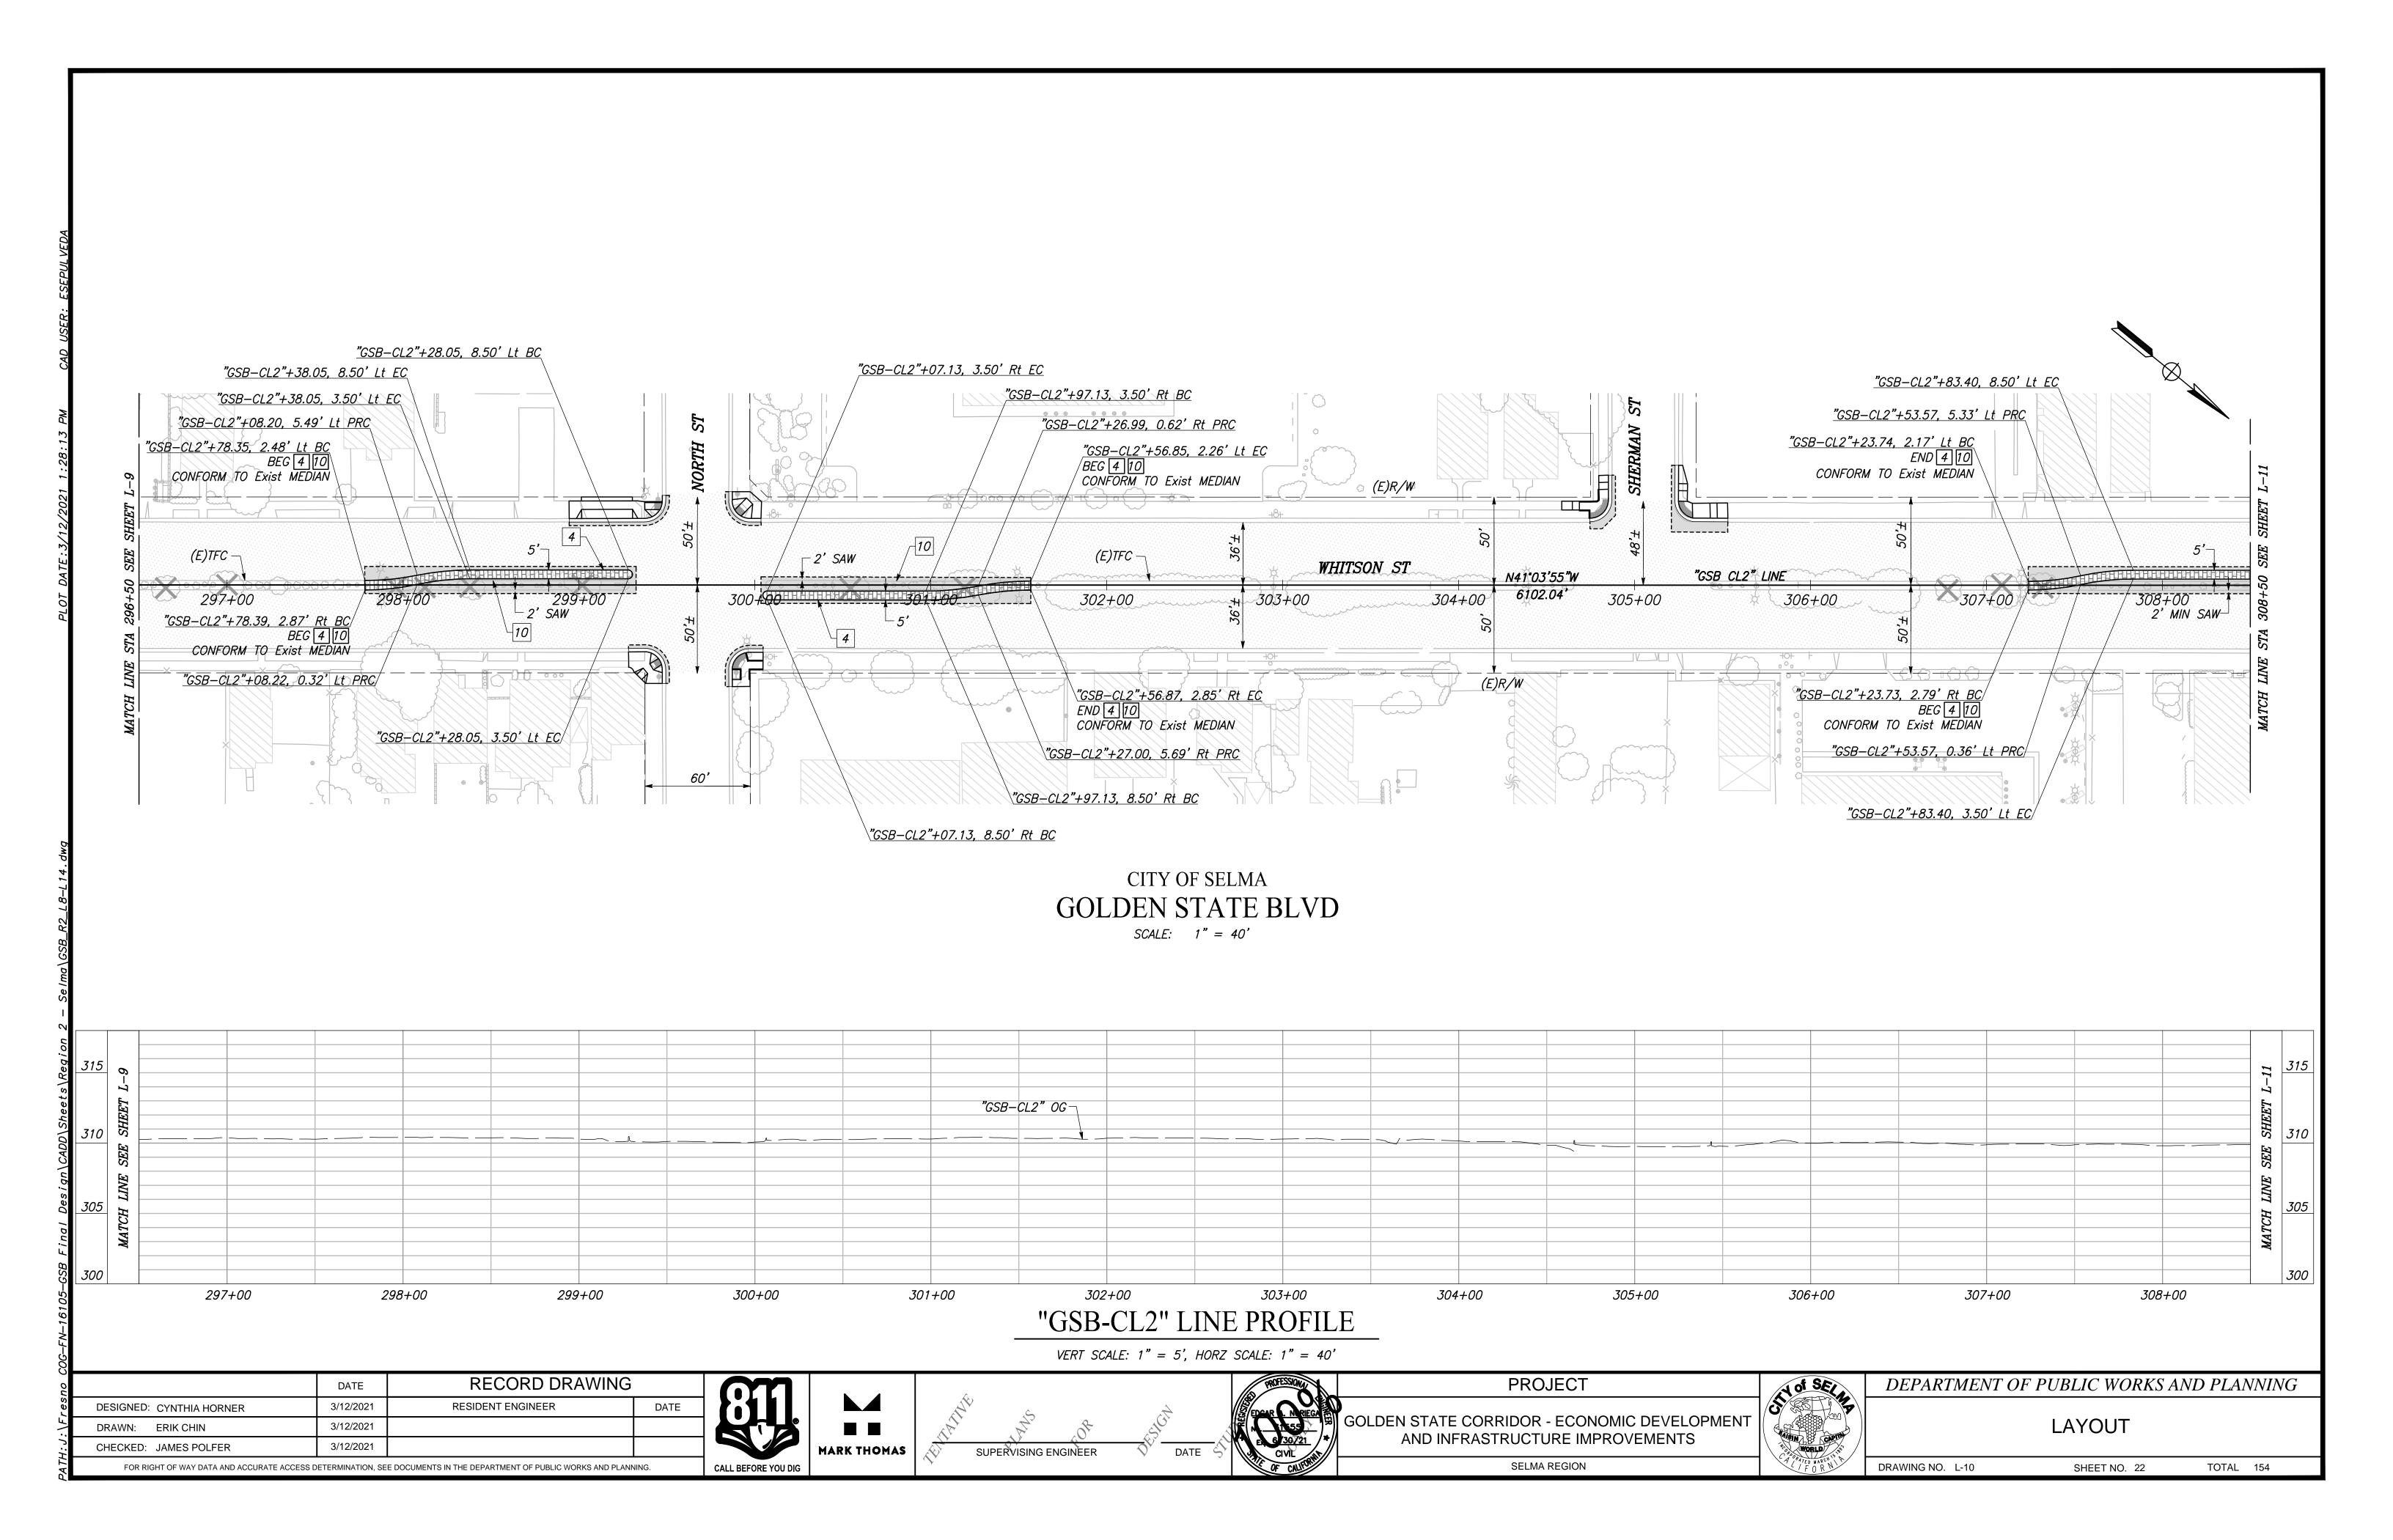


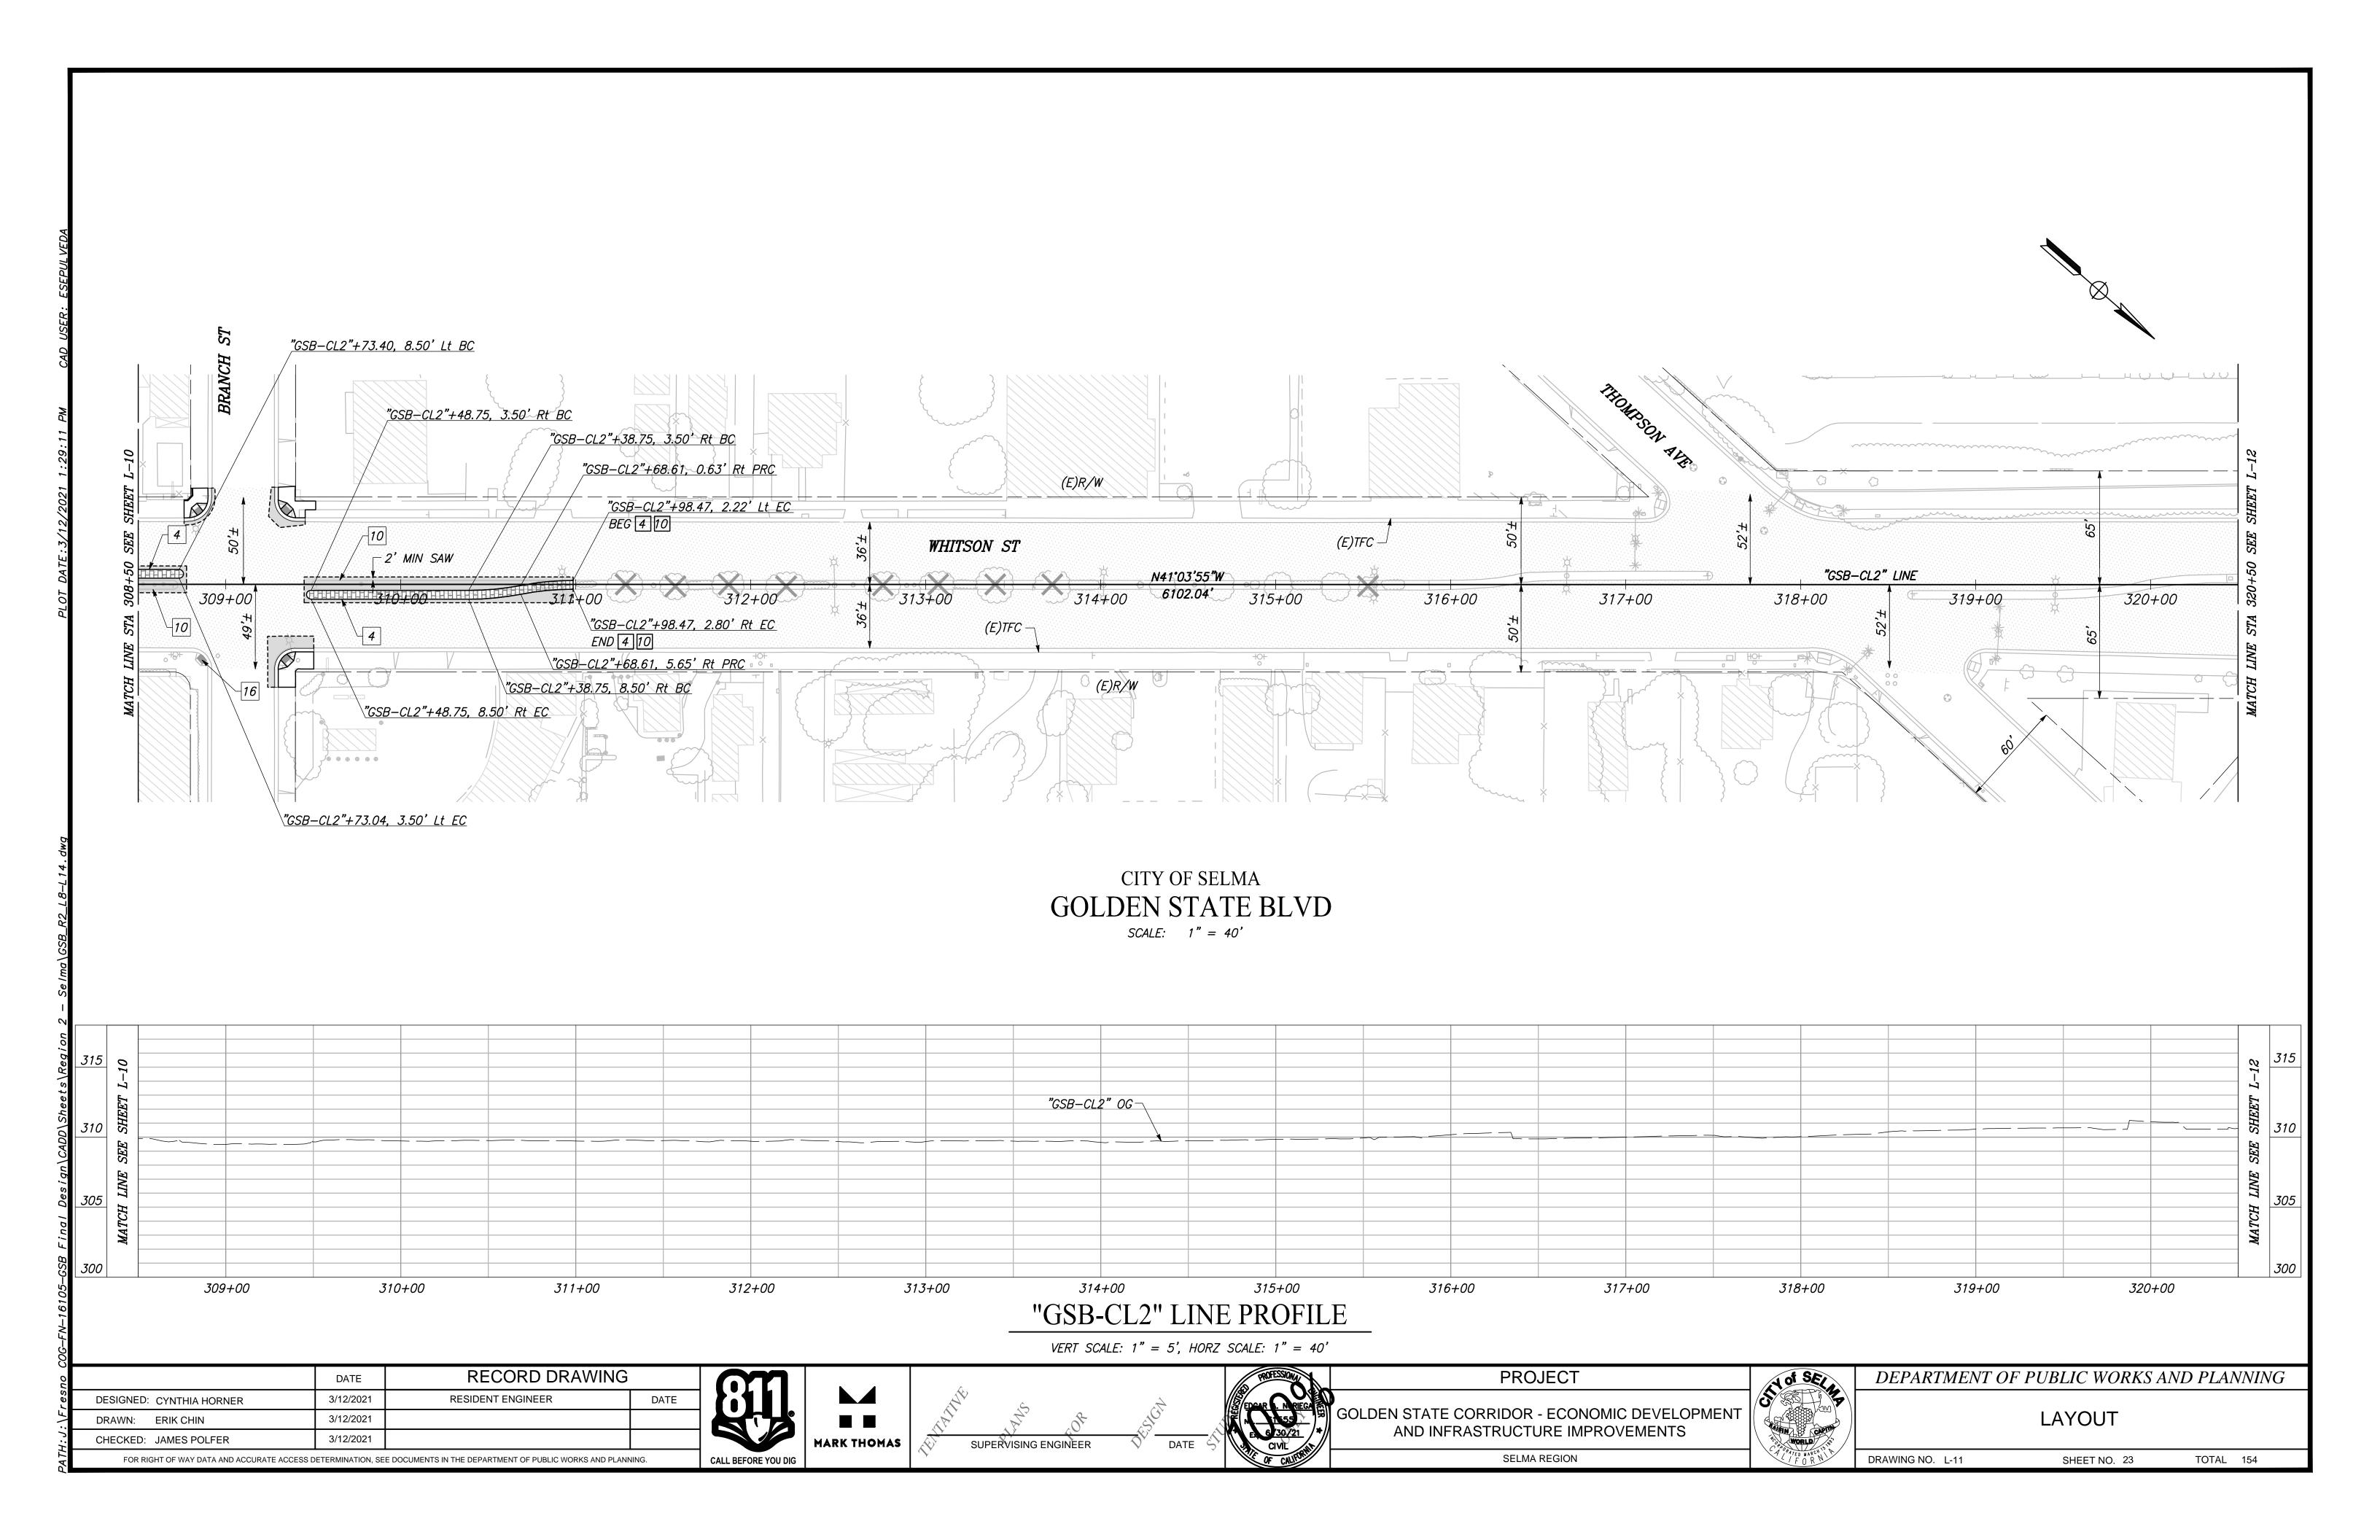

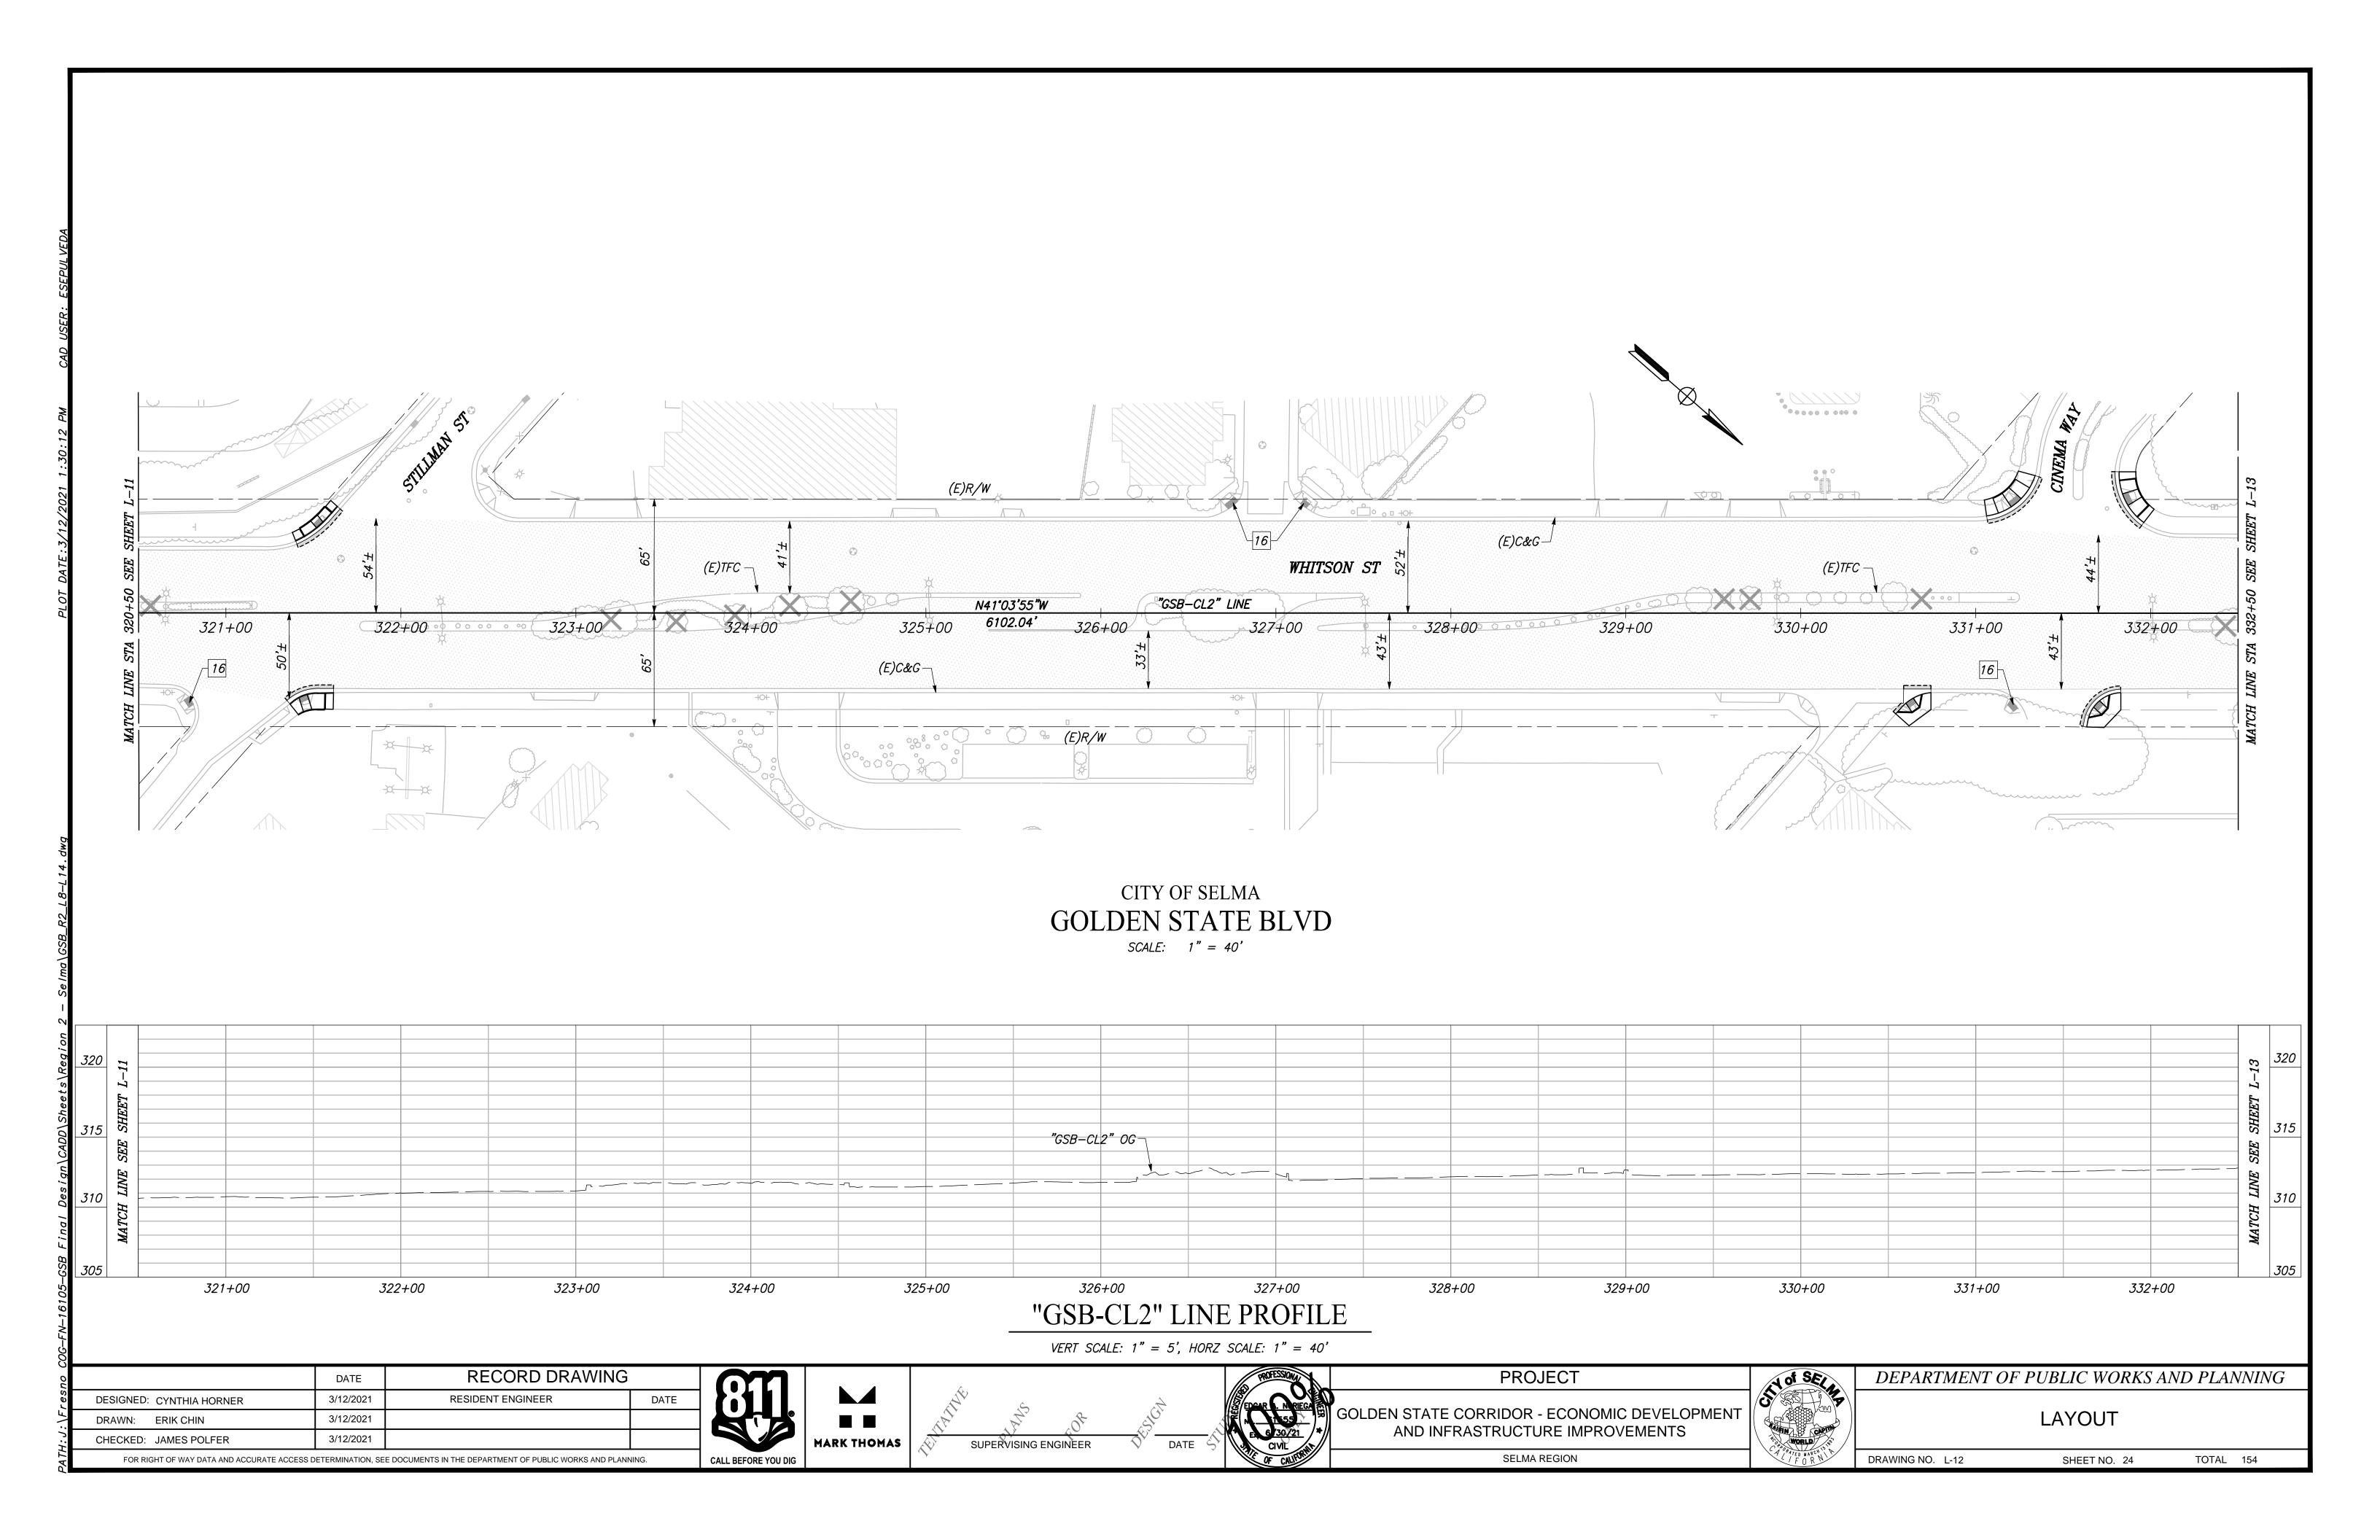

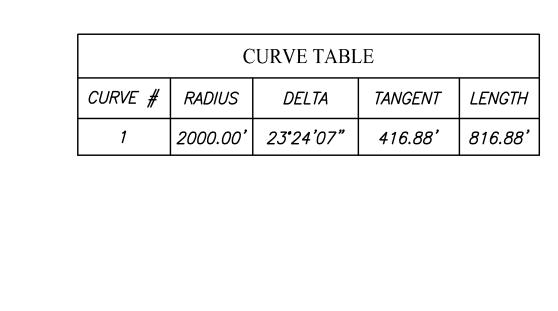

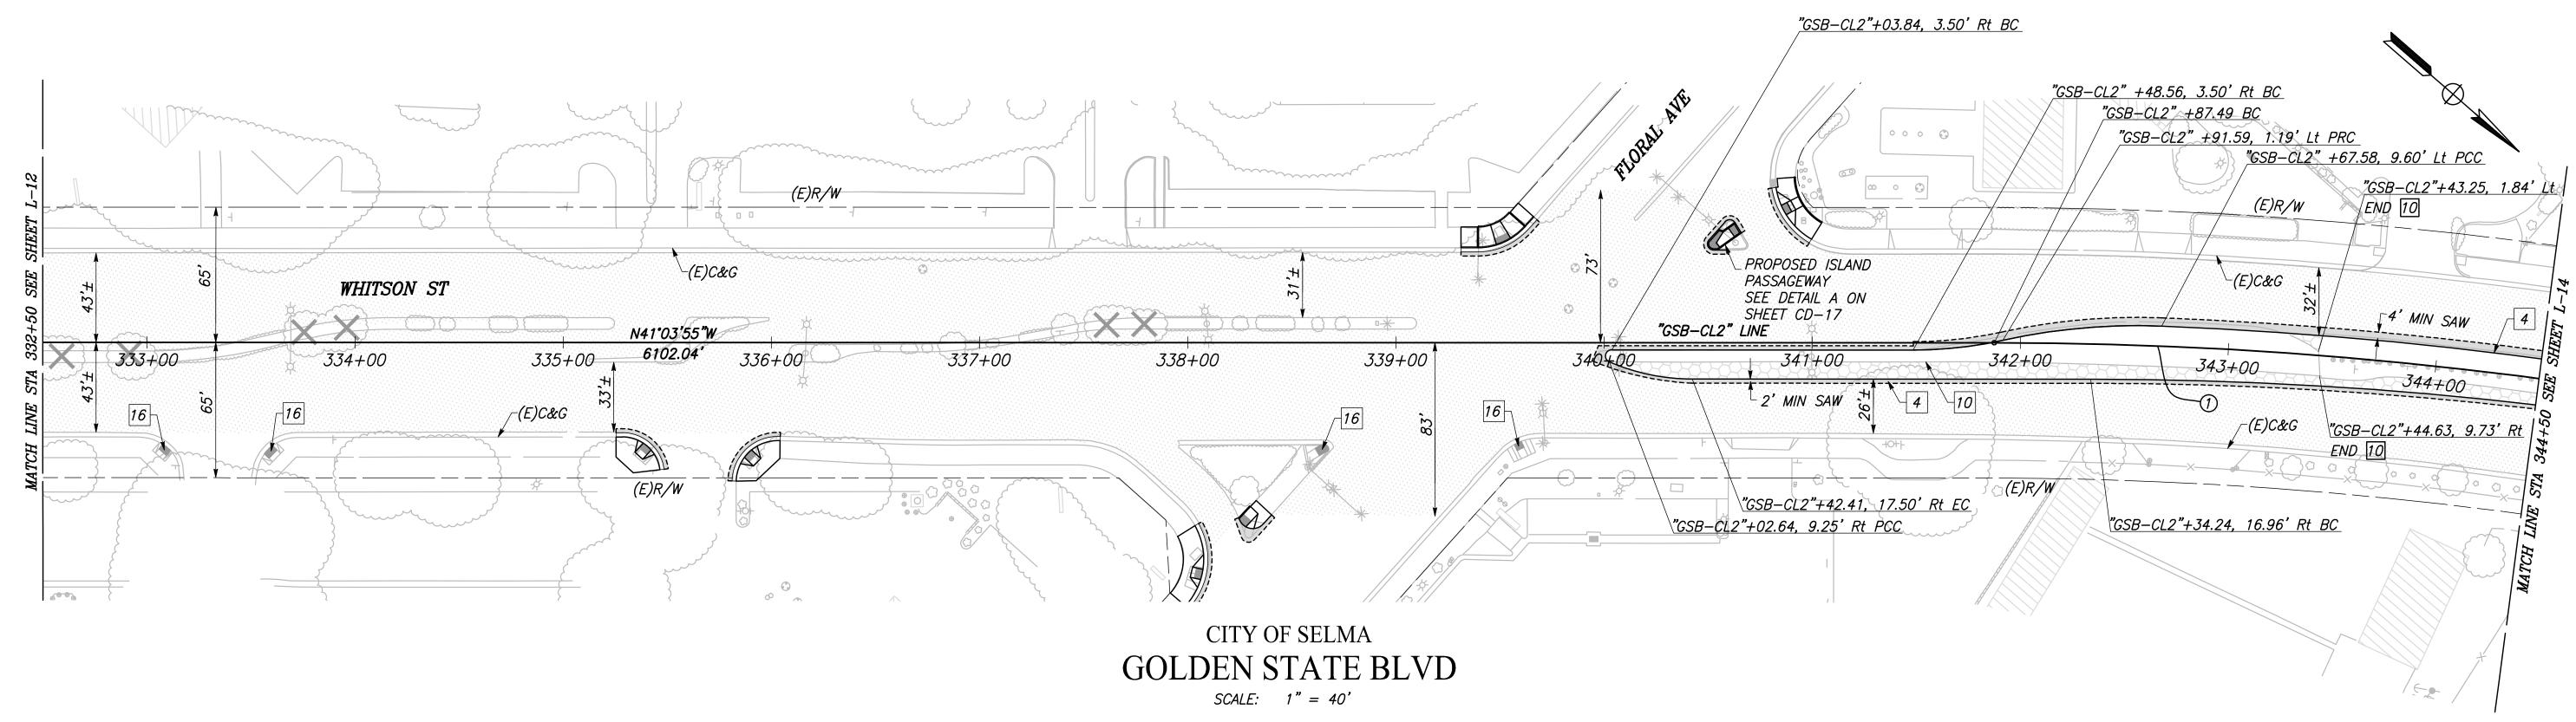

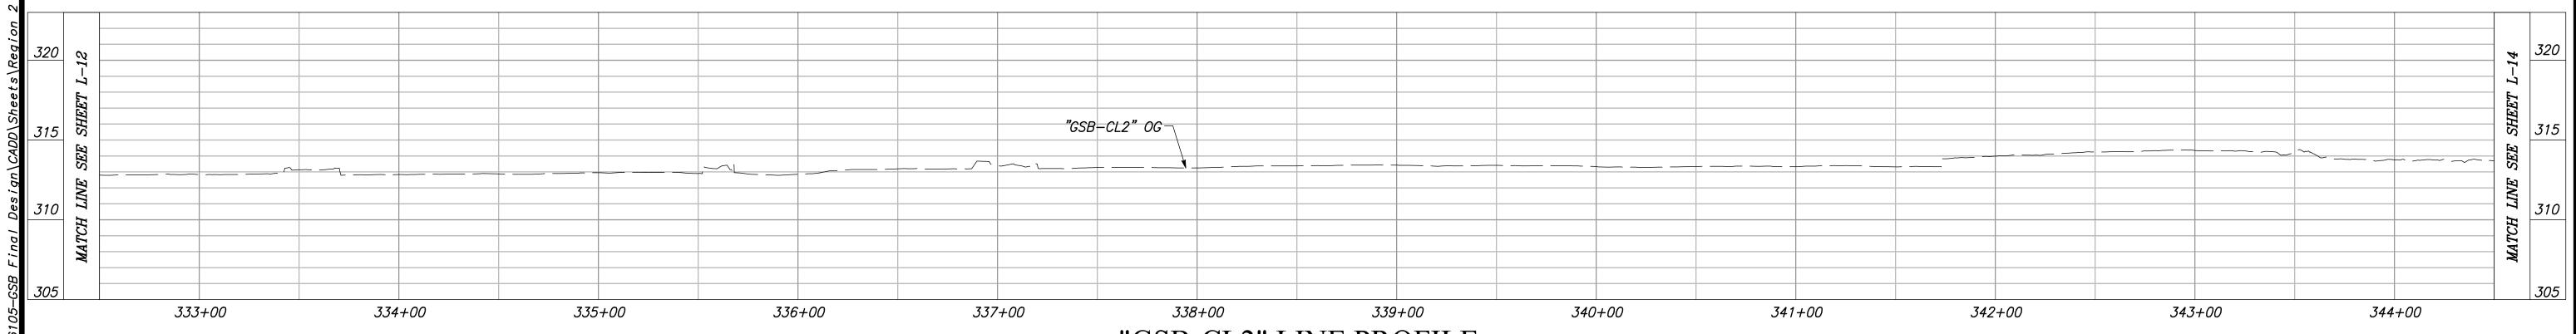



"GSB-CL2" LINE PROFILE

VERT SCALE: 1" = 5', HORZ SCALE: 1" = 40'

	DATE	RECORD DRAWING	
DESIGNED: CYNTHIA HORN	IER 3/12/2021	RESIDENT ENGINEER	DATE
DRAWN: ERIK CHIN	3/12/2021		
CHECKED: JAMES POLFER	3/12/2021		
FOR RIGHT OF WAY DATA AN	D ACCURATE ACCESS DETERMINATION, SE	E DOCUMENTS IN THE DEPARTMENT OF PUBLIC WORKS AND P	LANNING.



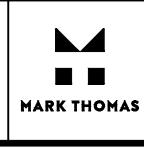

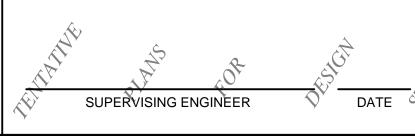




GOLDEN STATE CORRIDOR - ECONOMIC DEVELOPMENT AND INFRASTRUCTURE IMPROVEMENTS

SELMA REGION


PROJECT

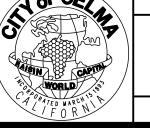



DEPARTMENT OF PUBLIC WORKS AND PLANNING


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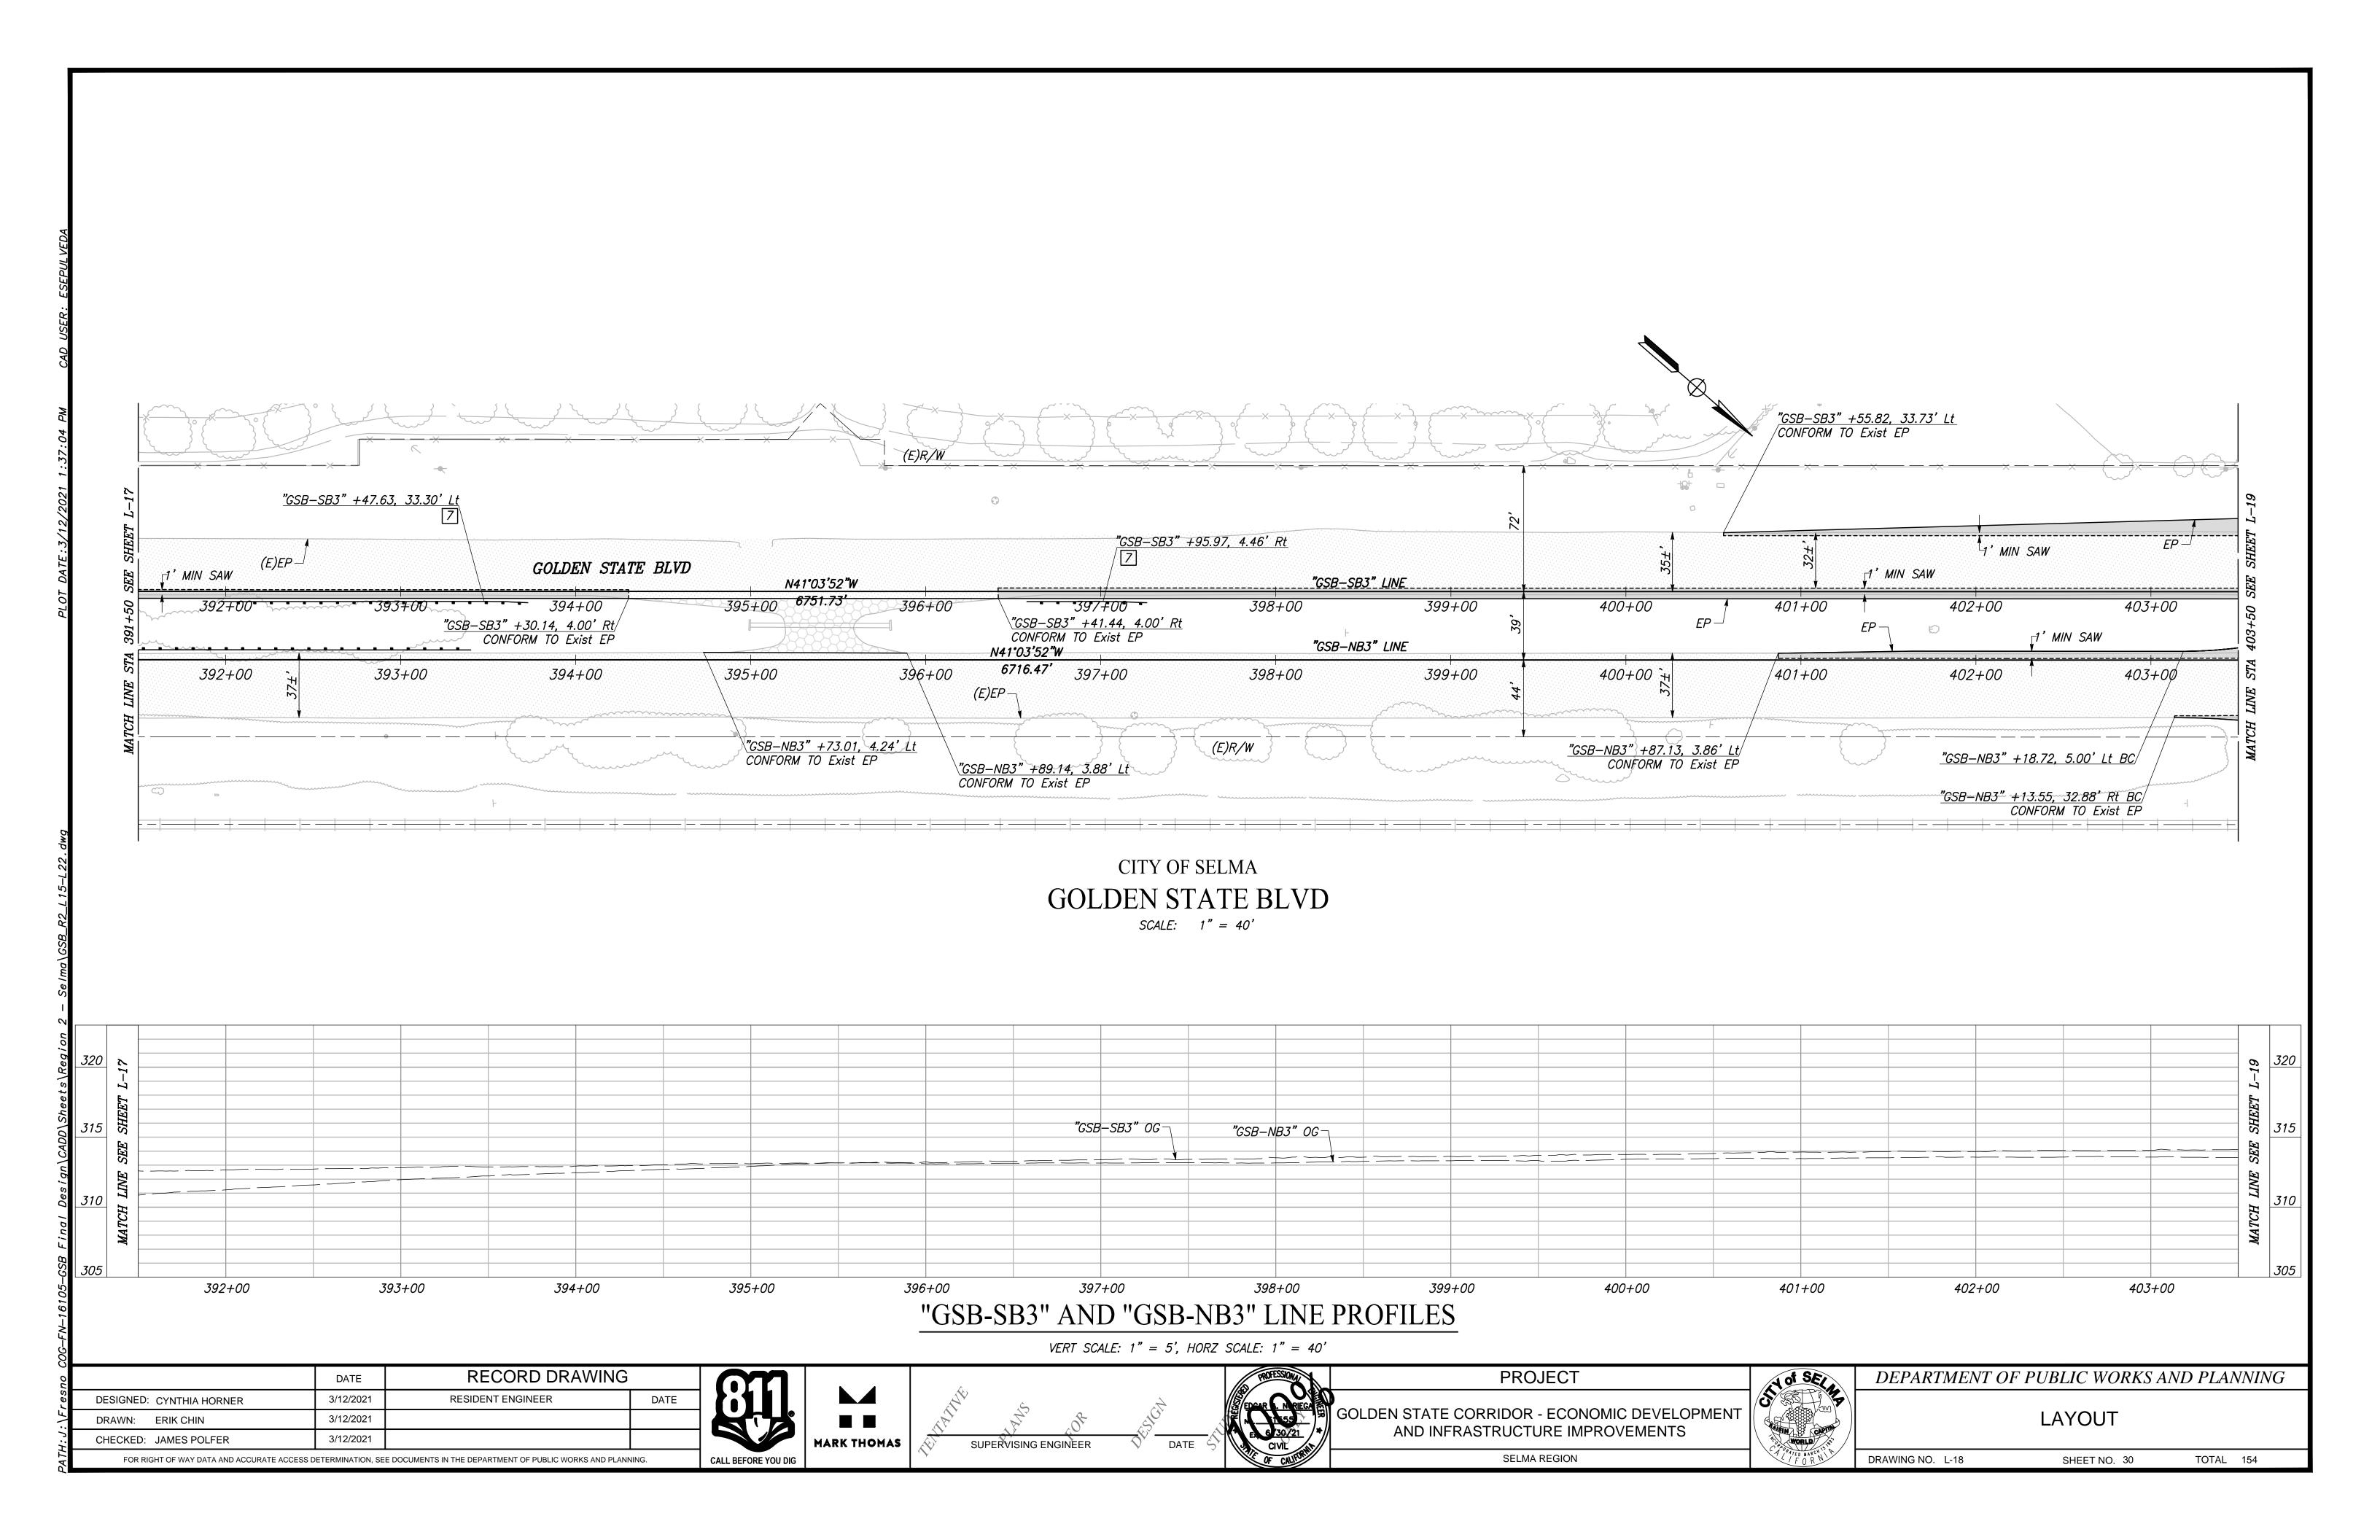
DRAWING NO. L-13 SHEET NO. 25 TOTAL 154




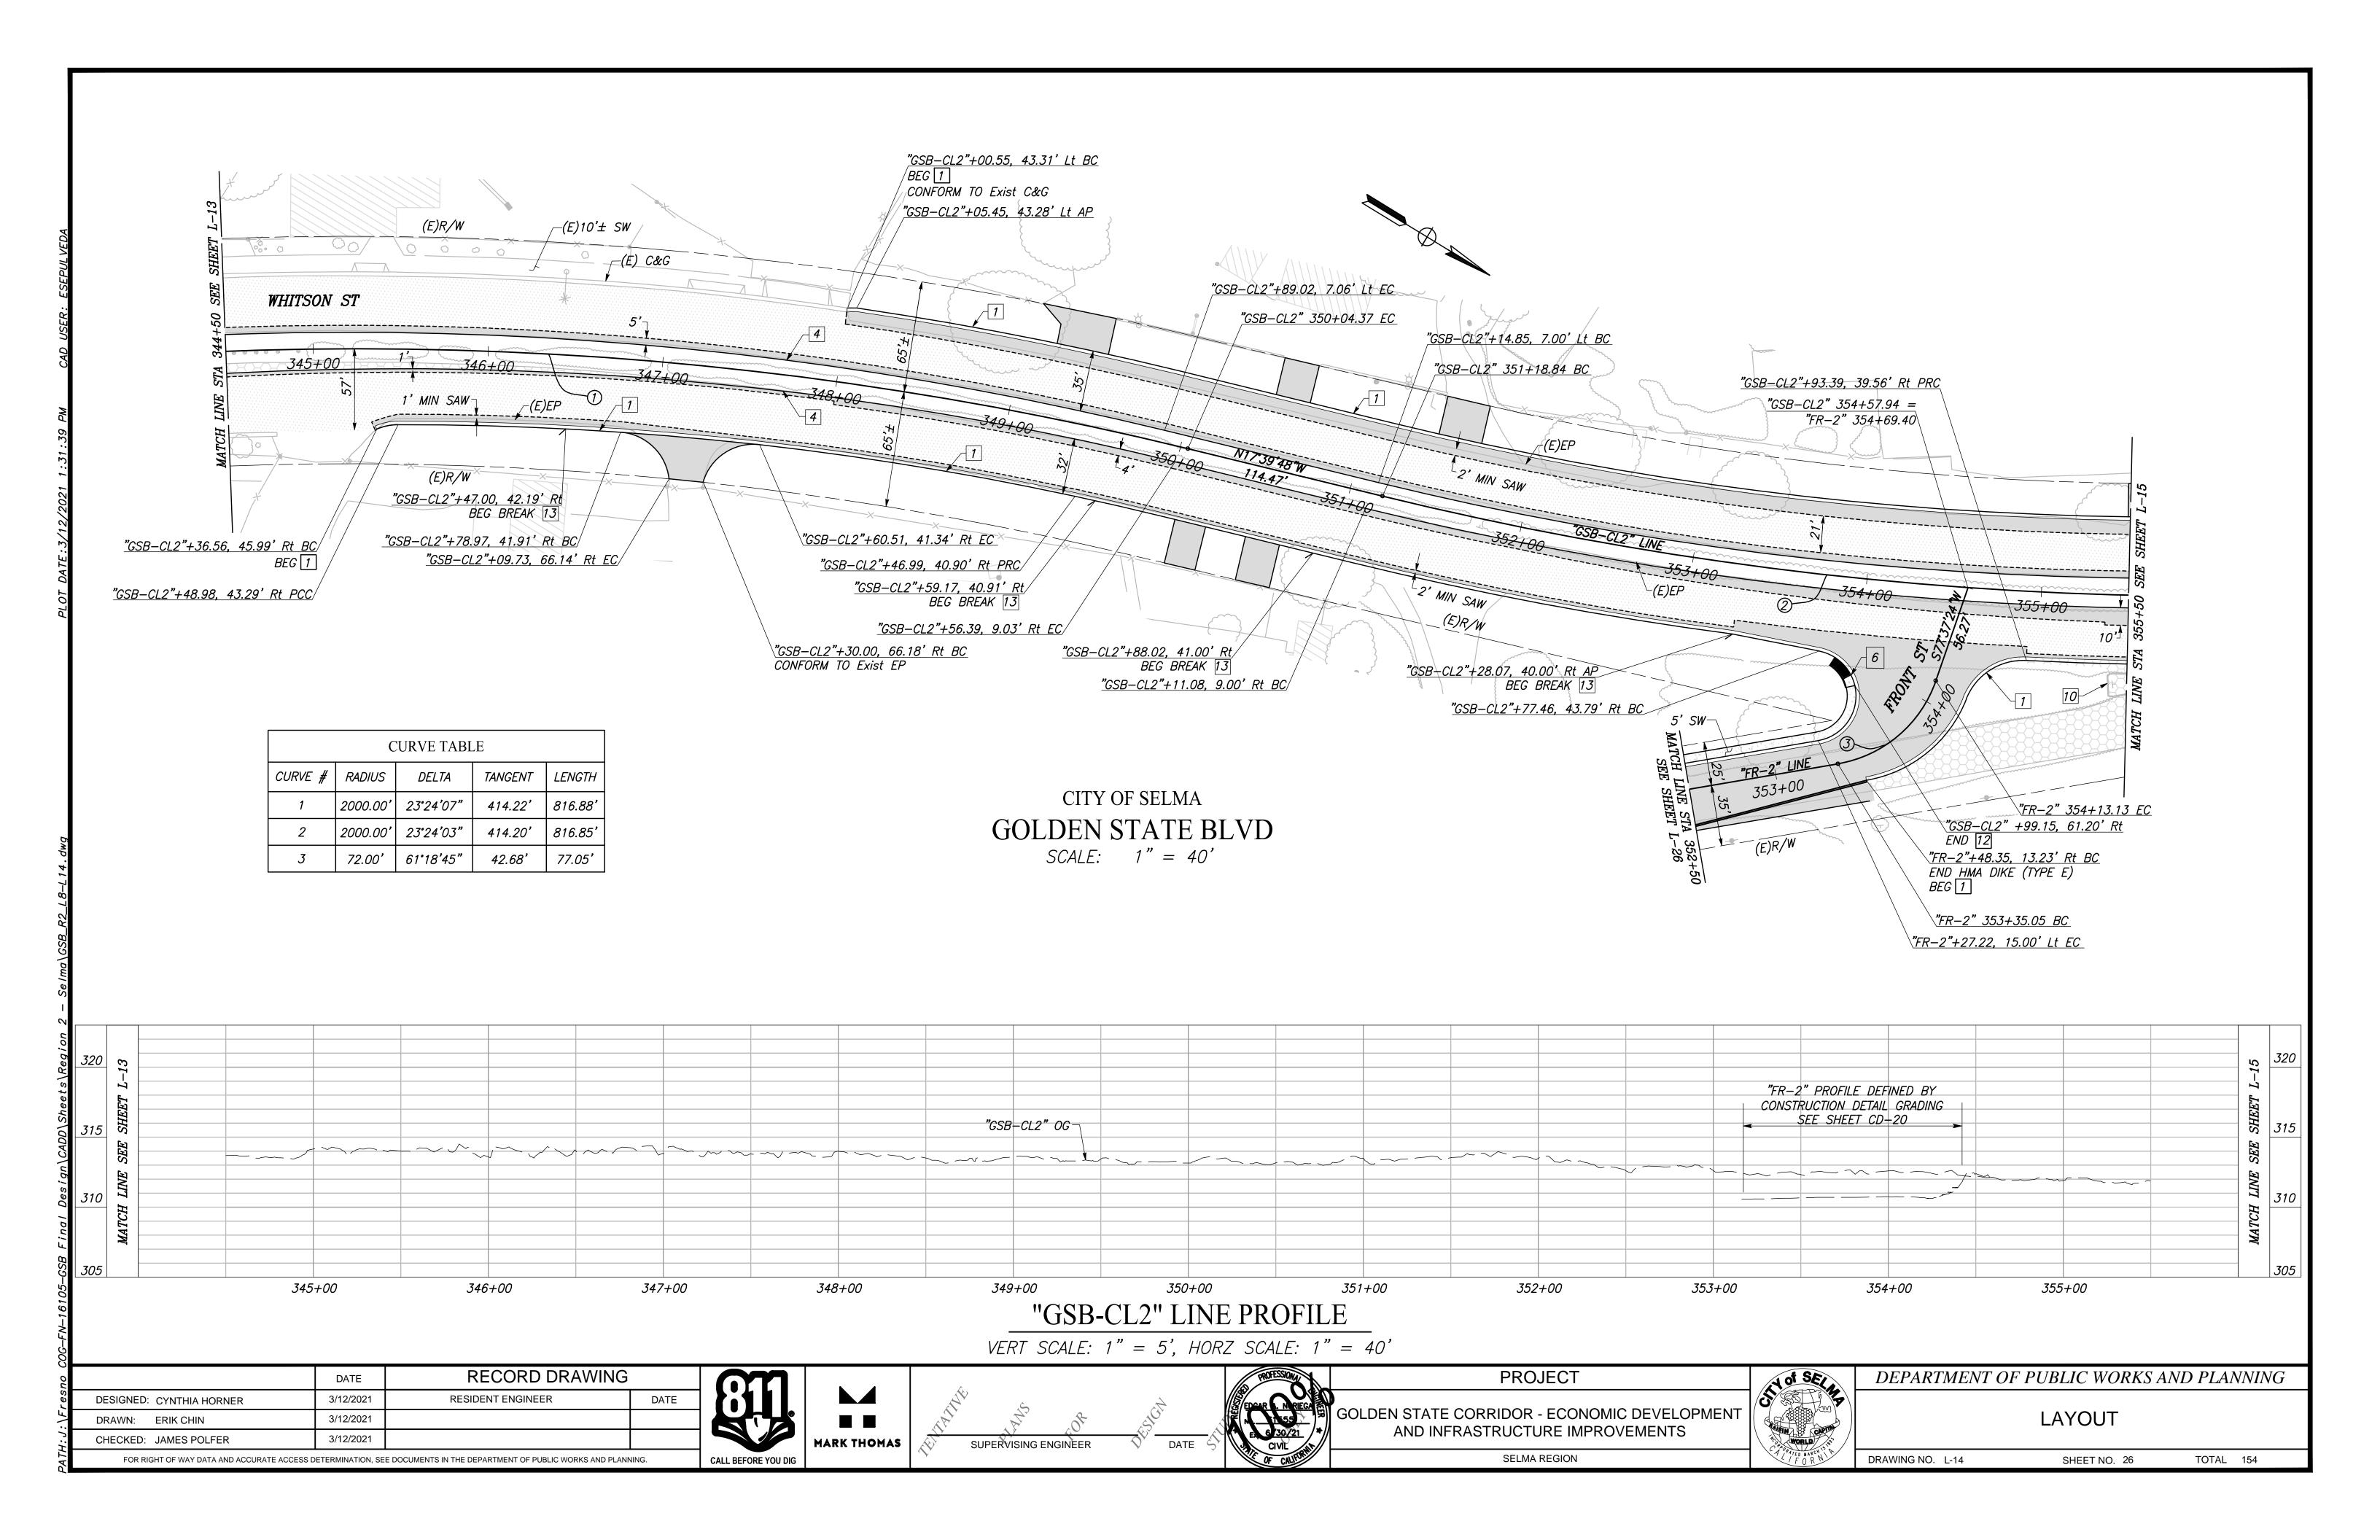


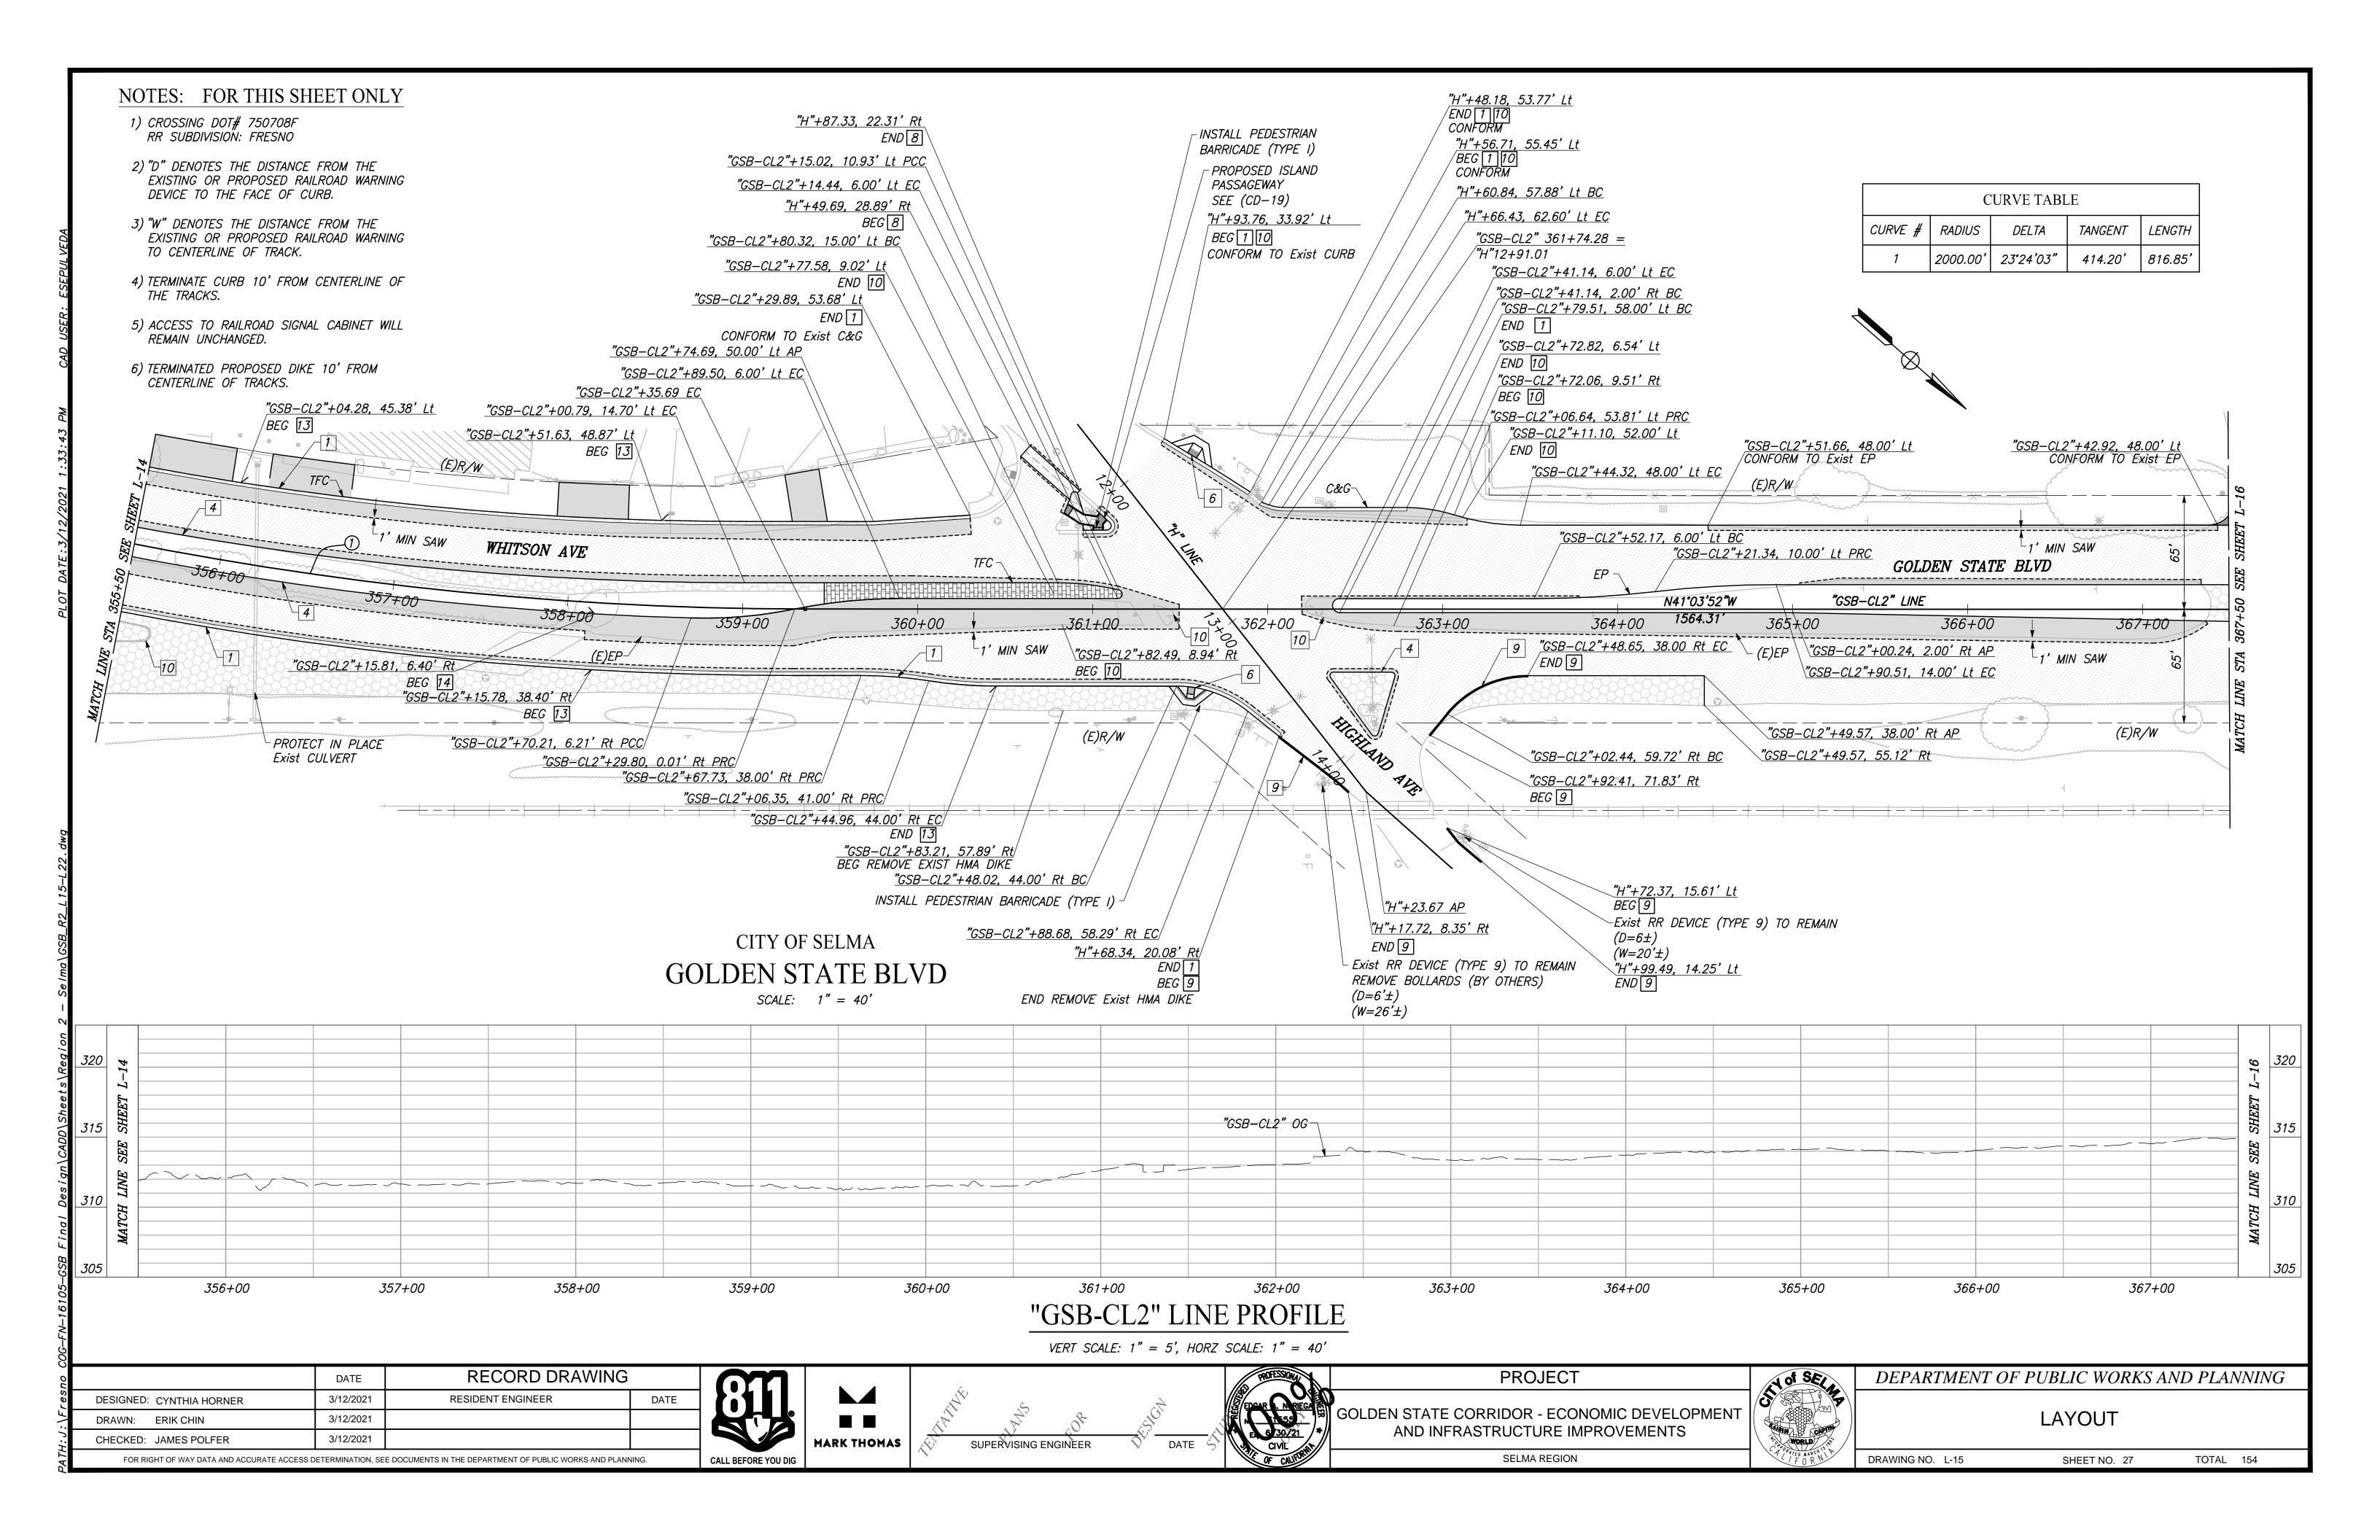


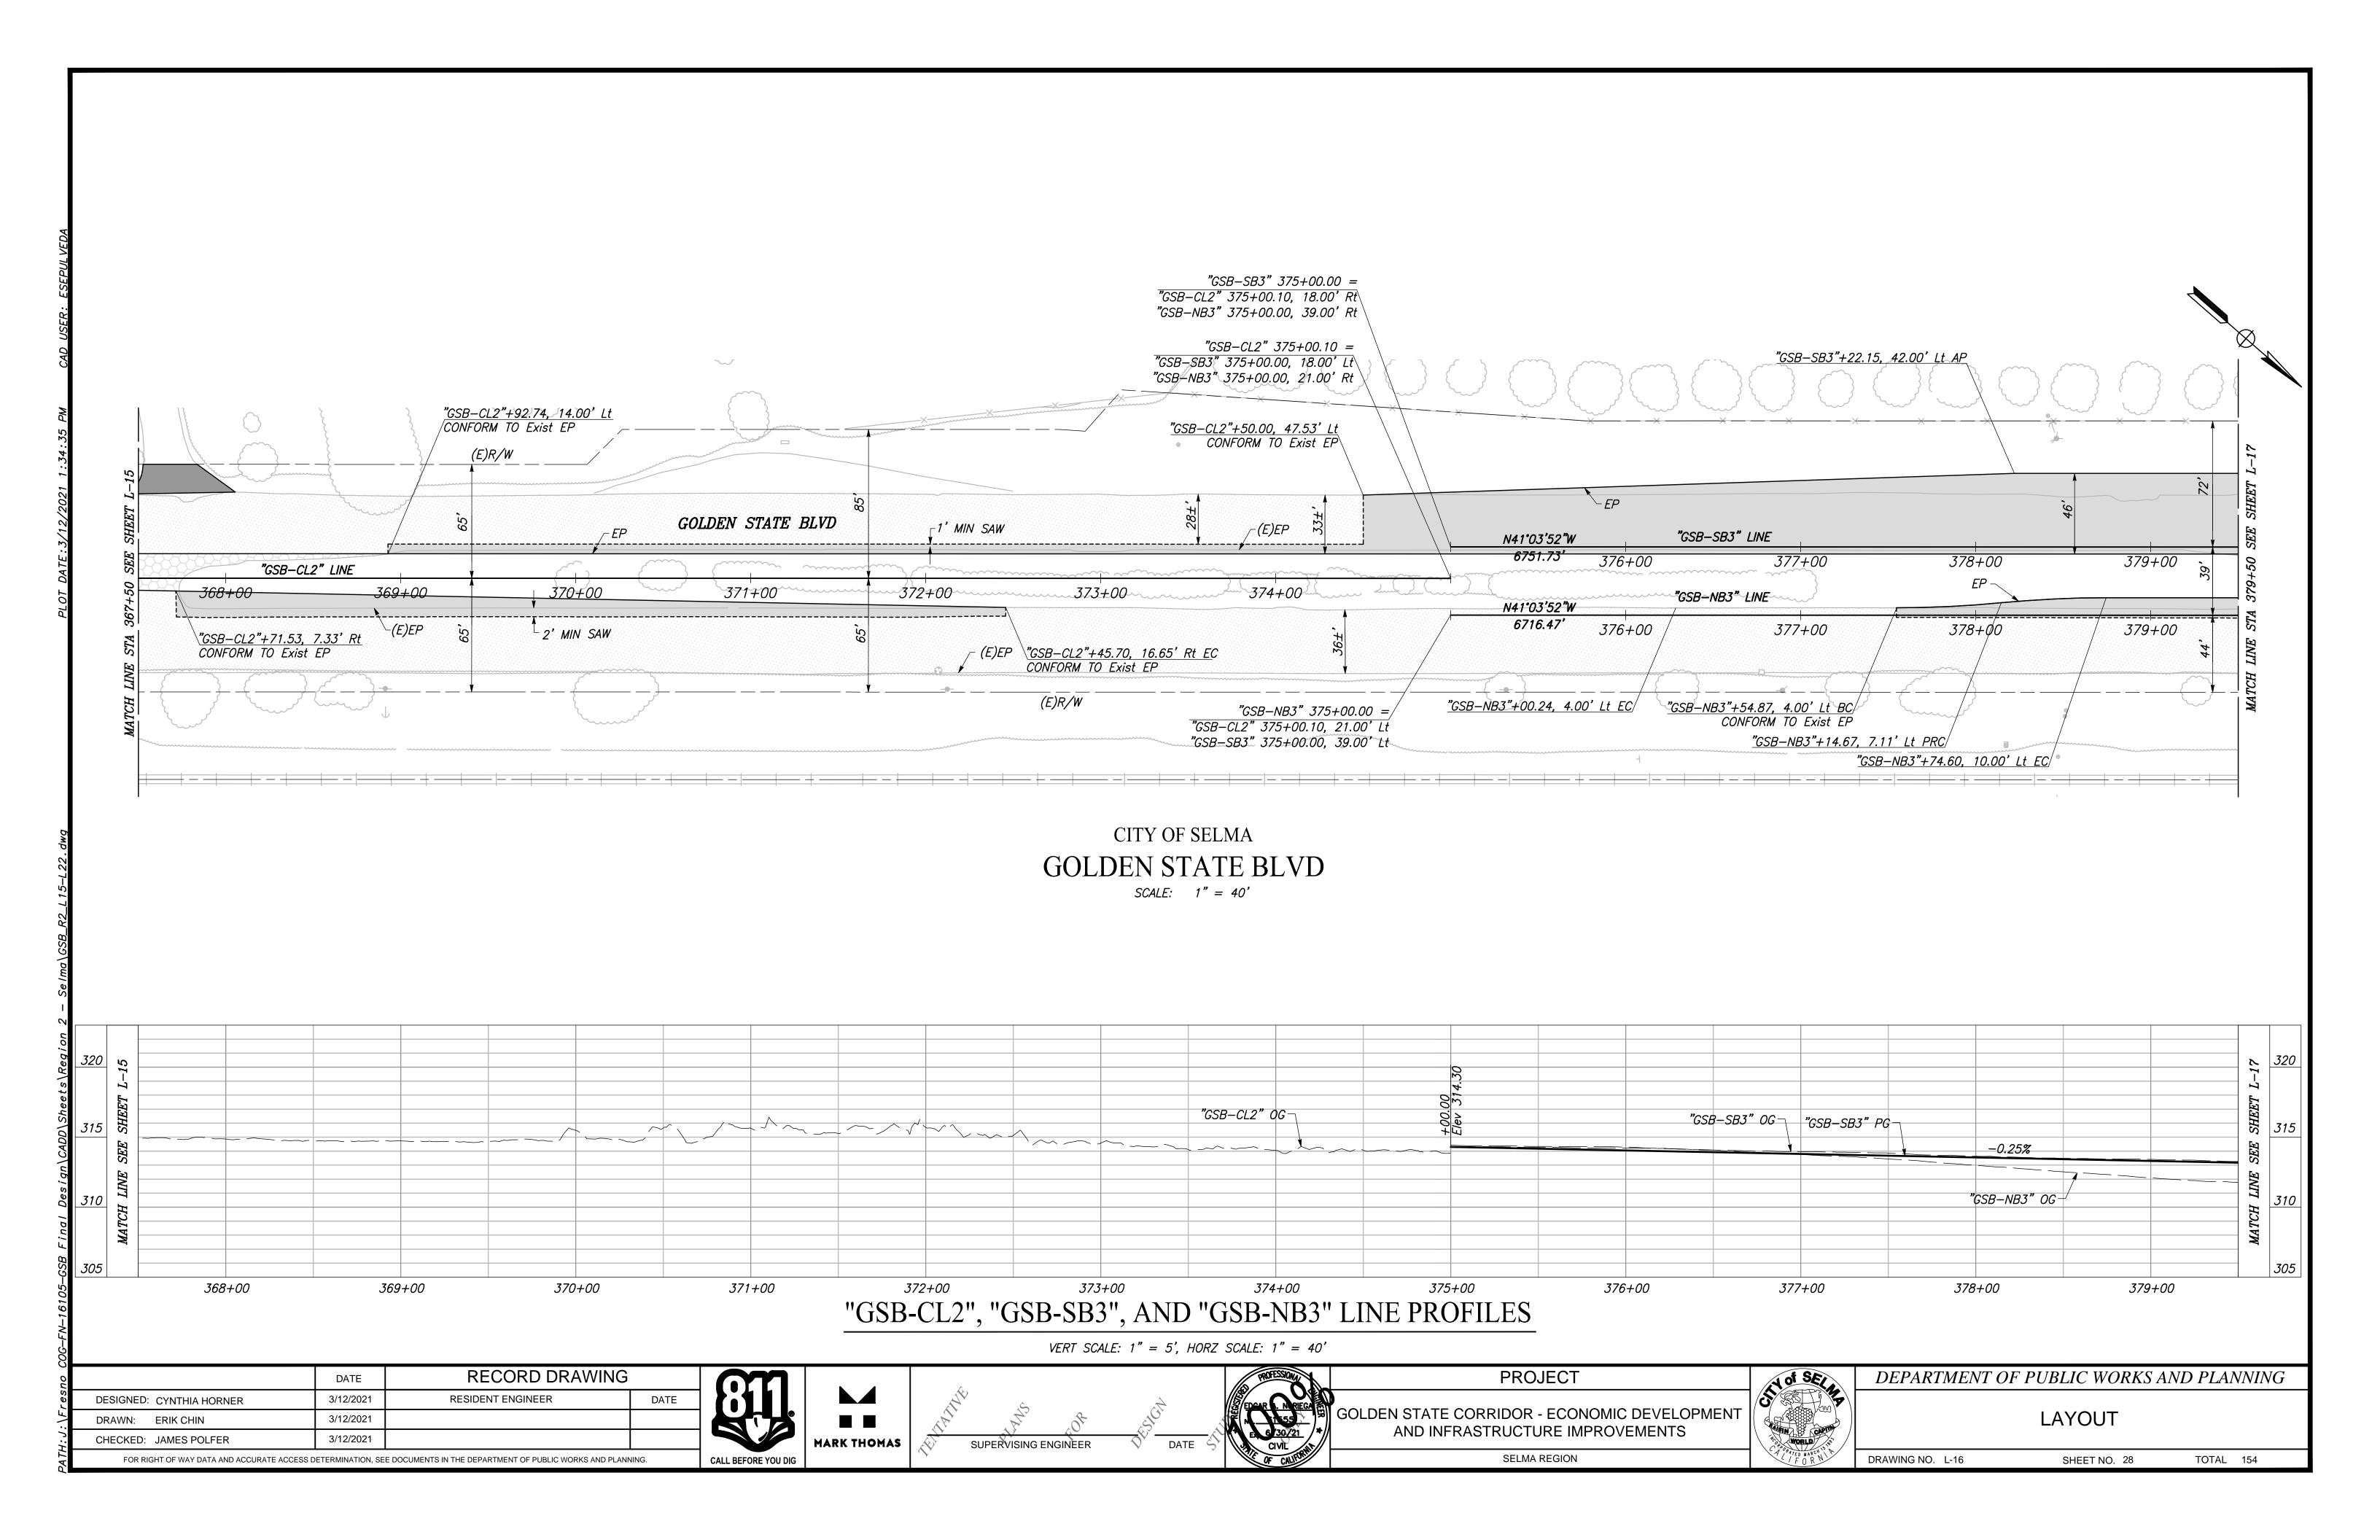


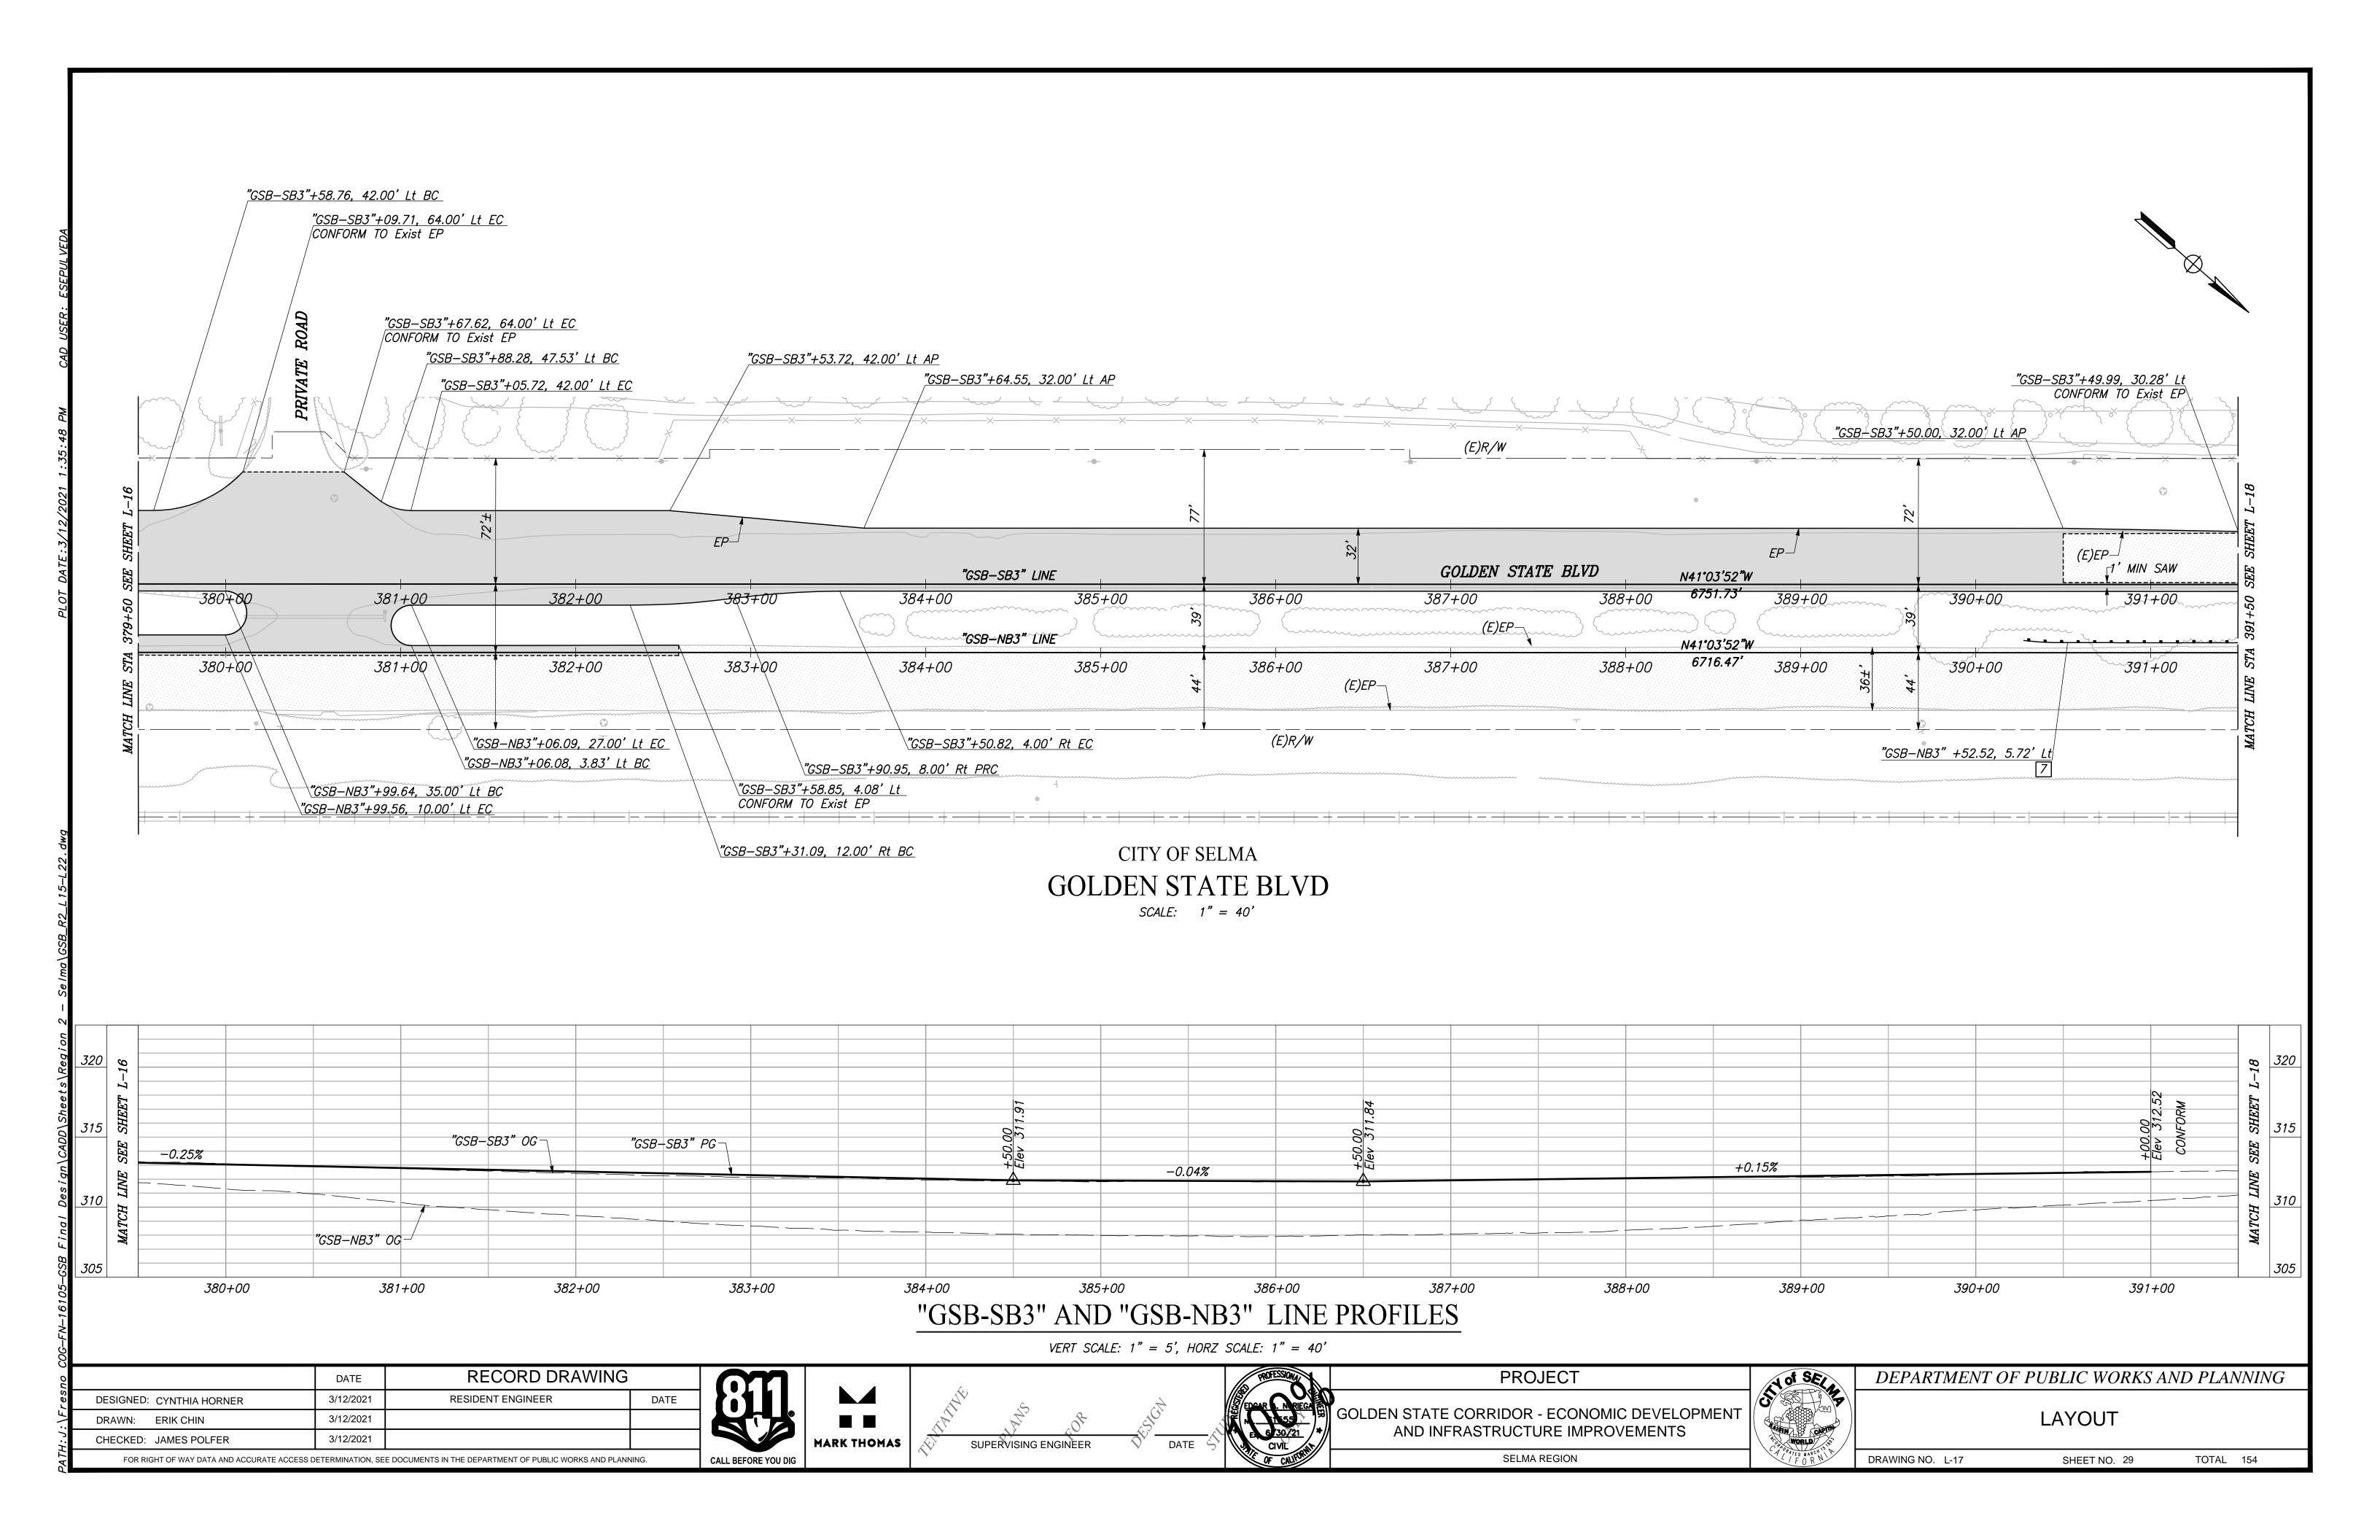


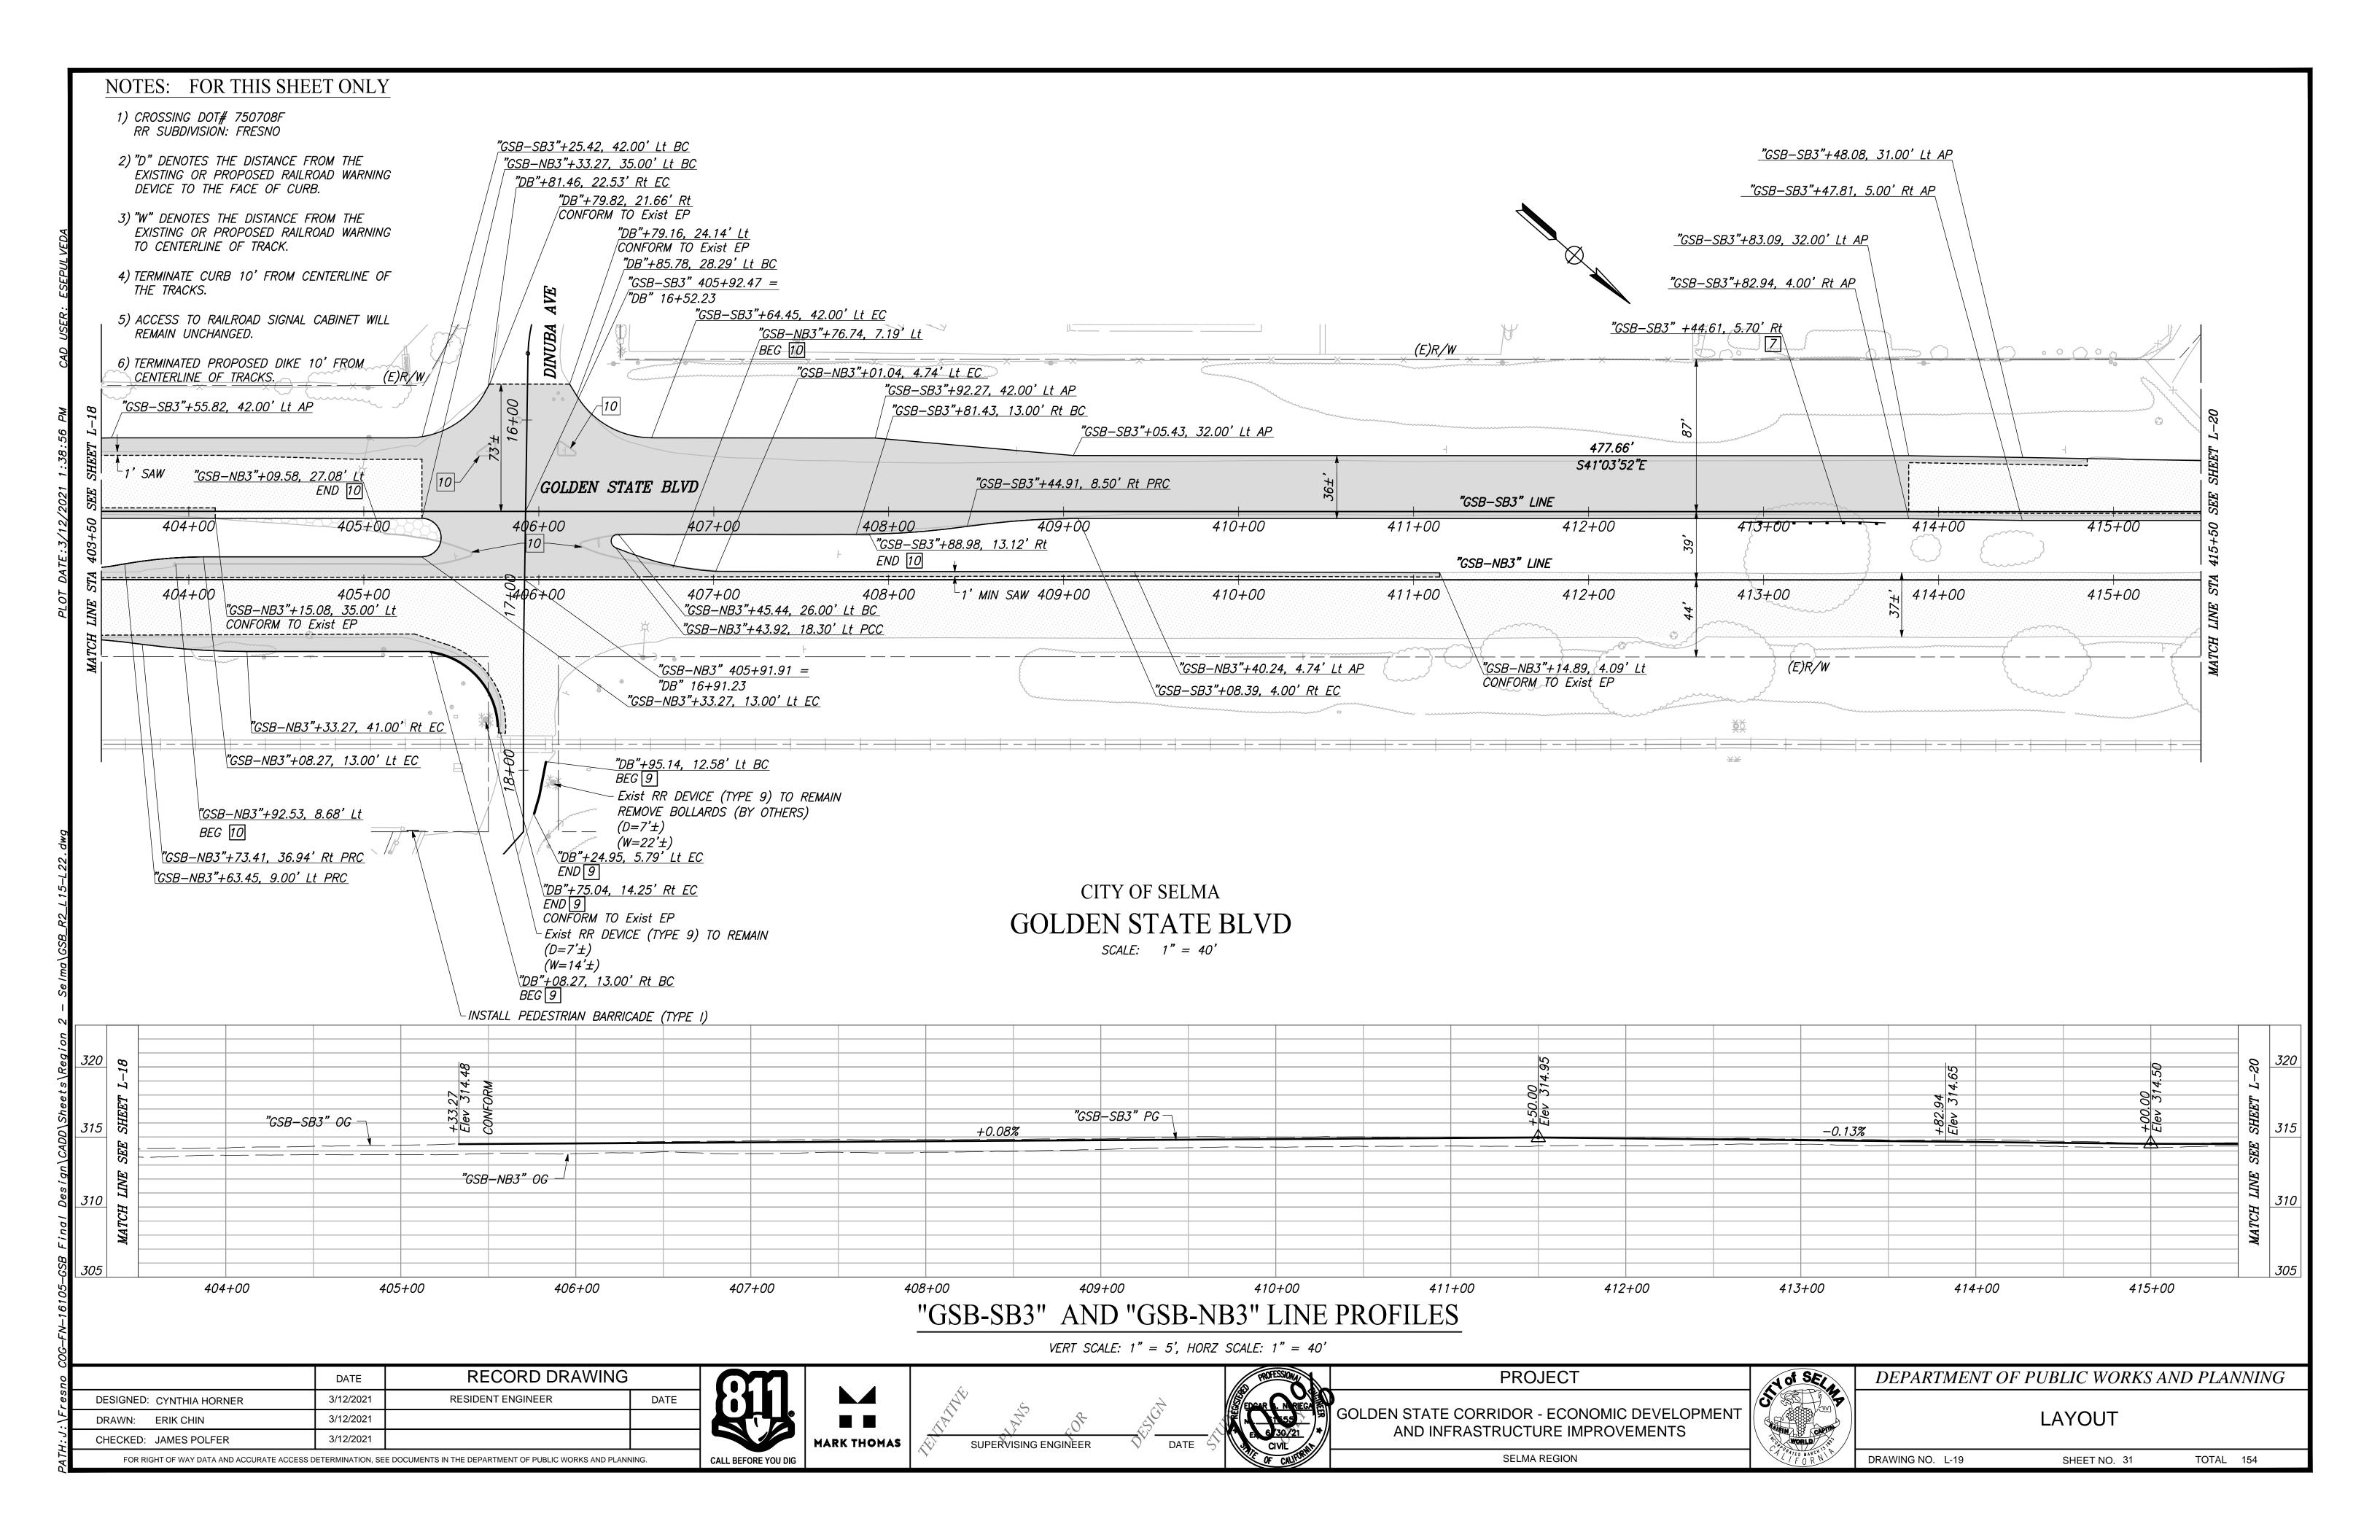


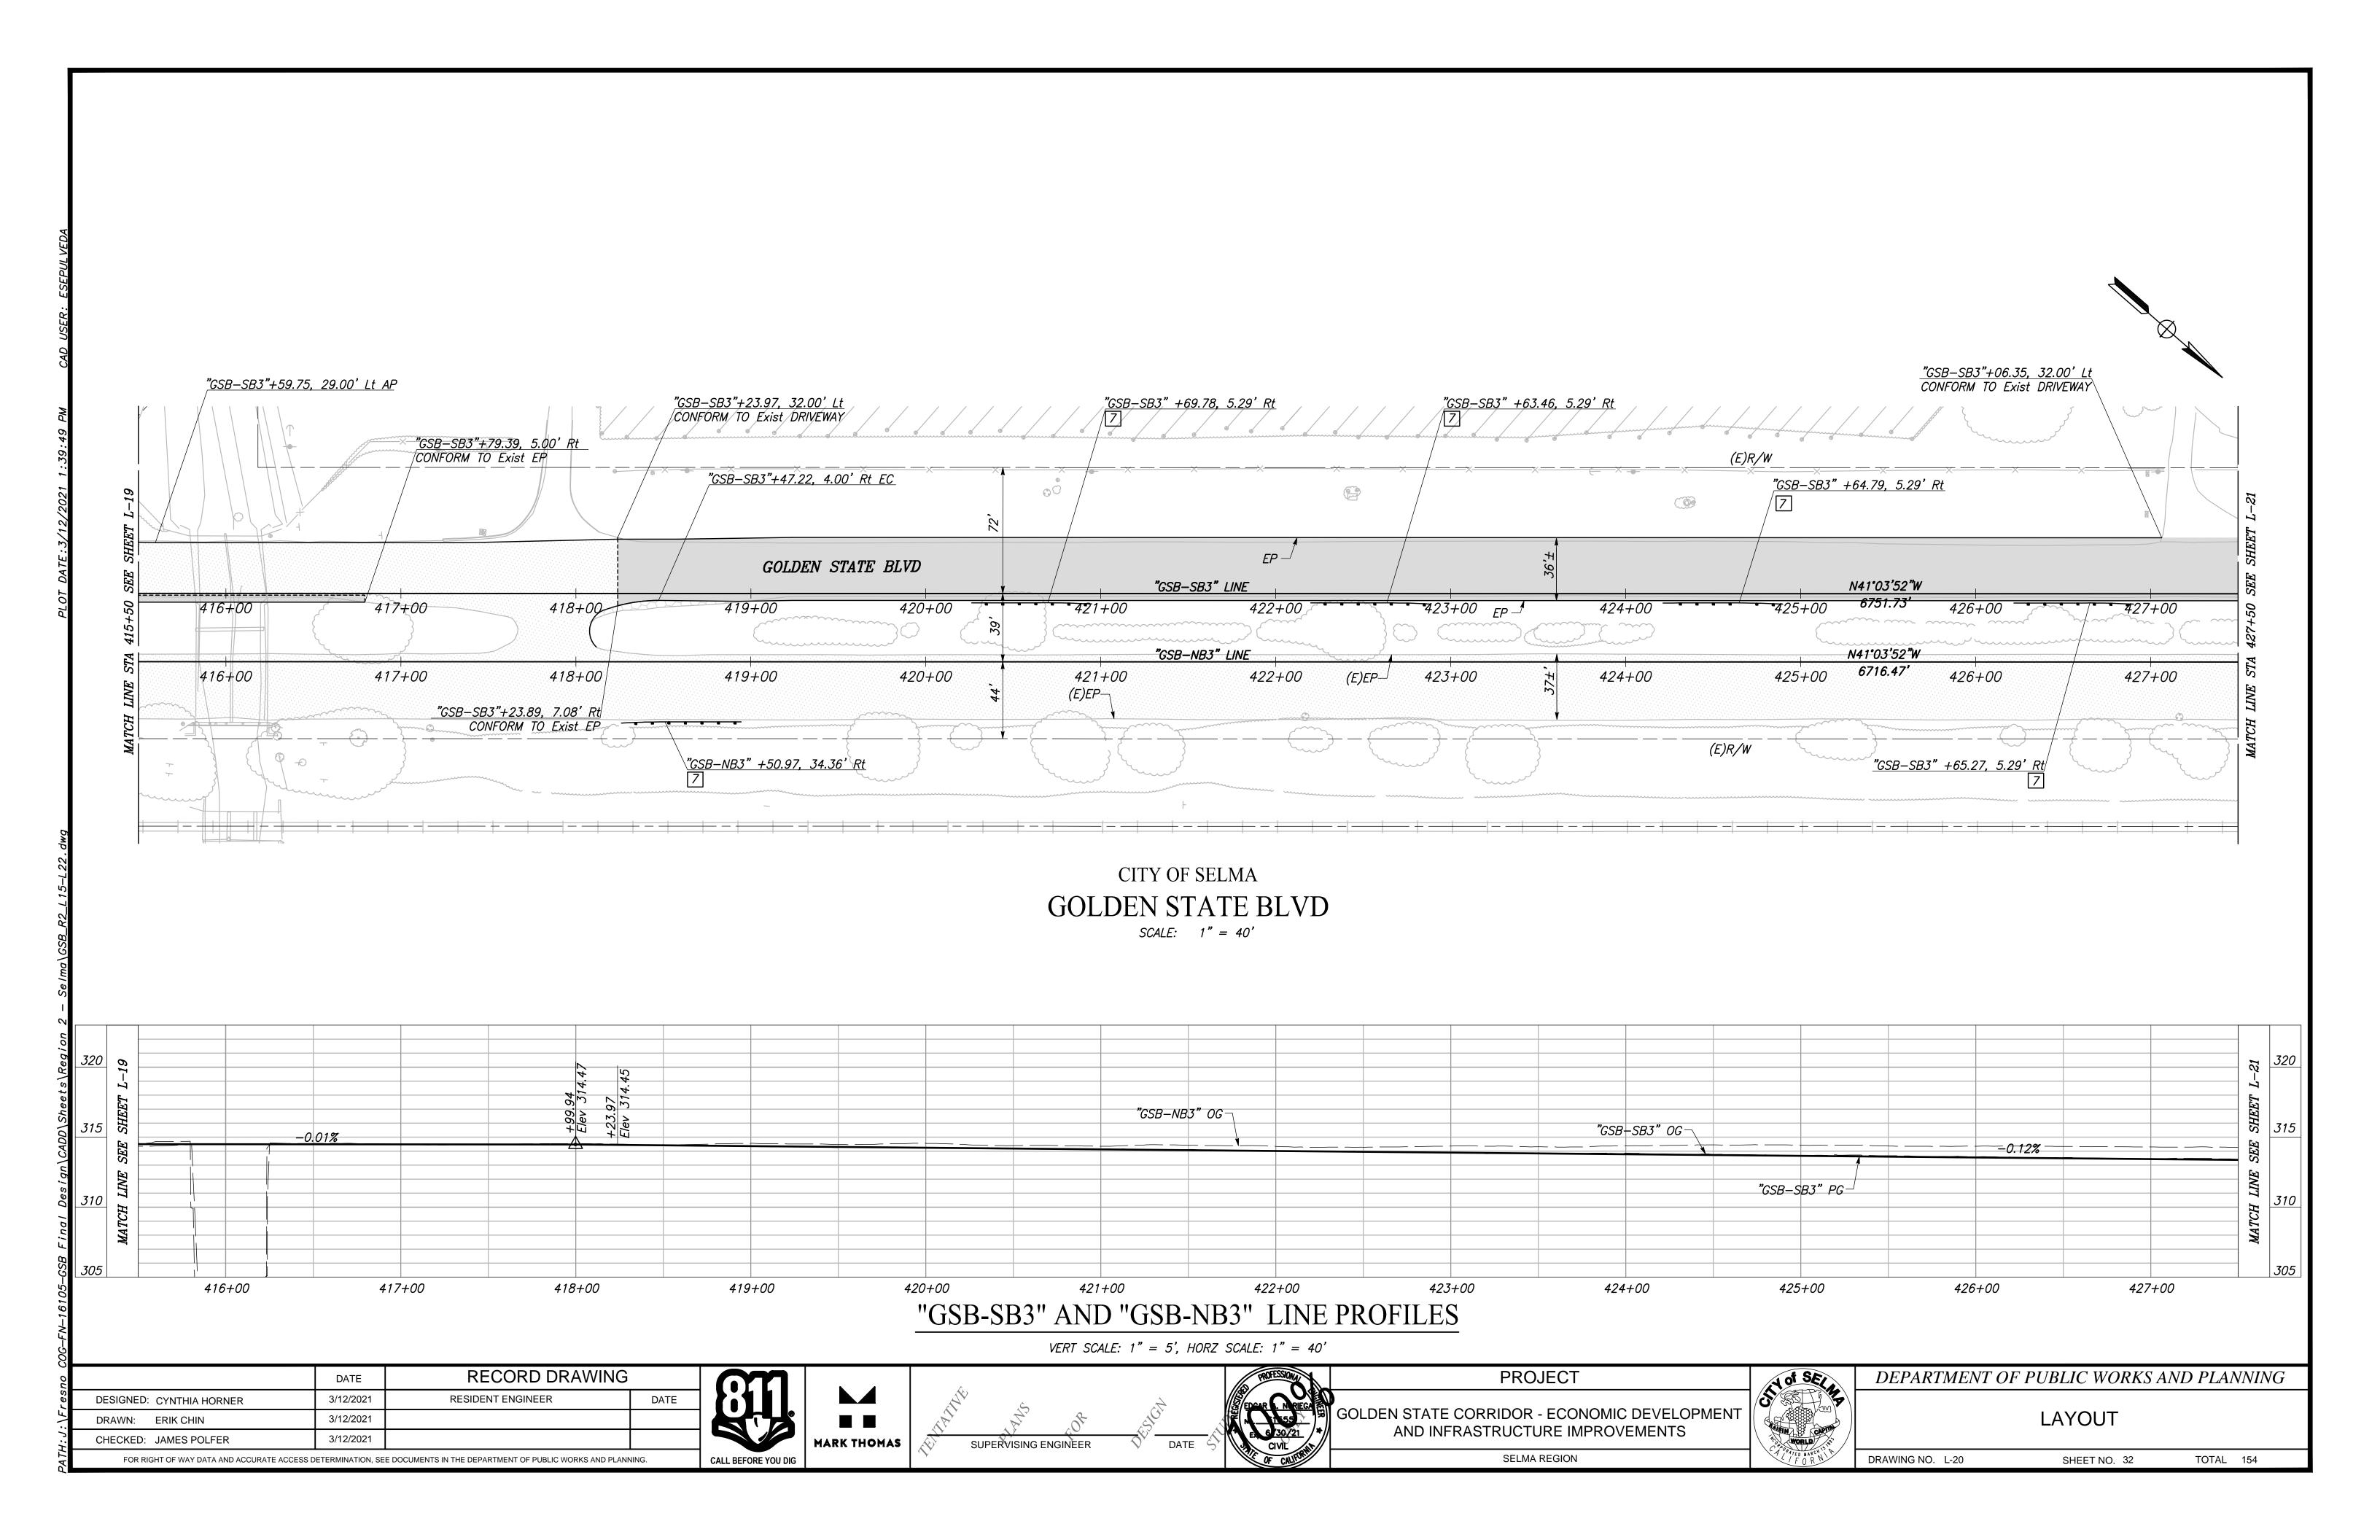

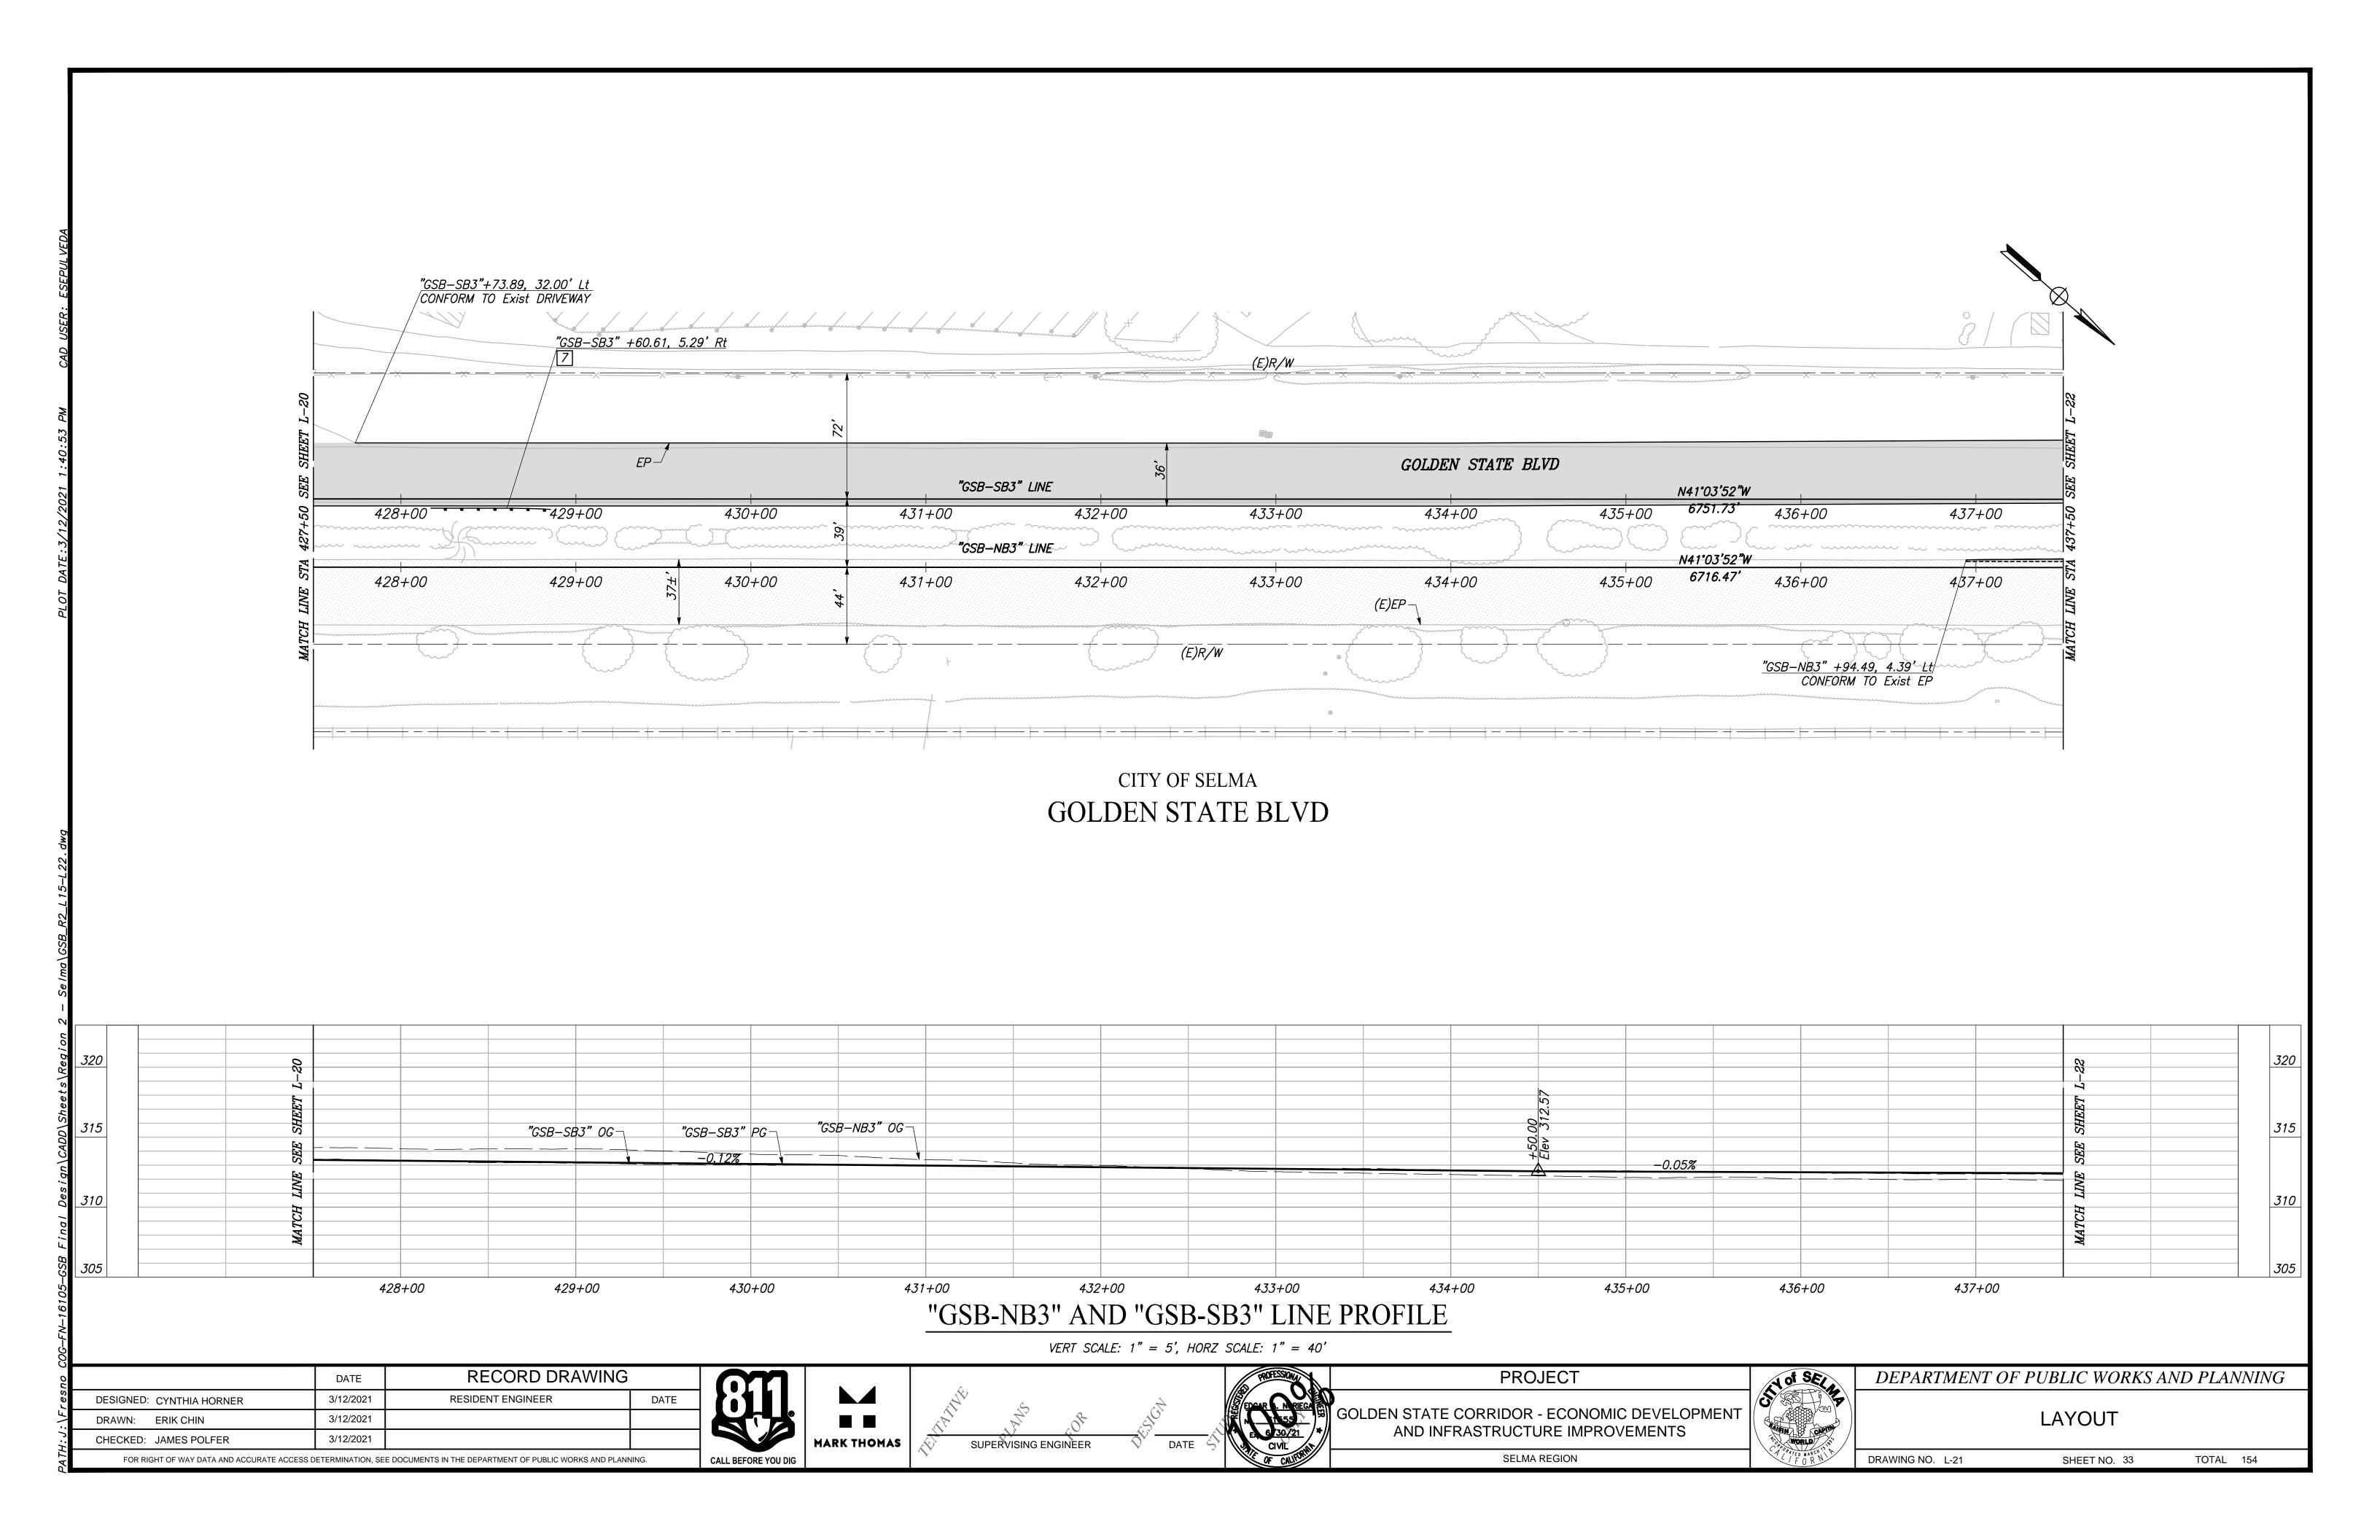

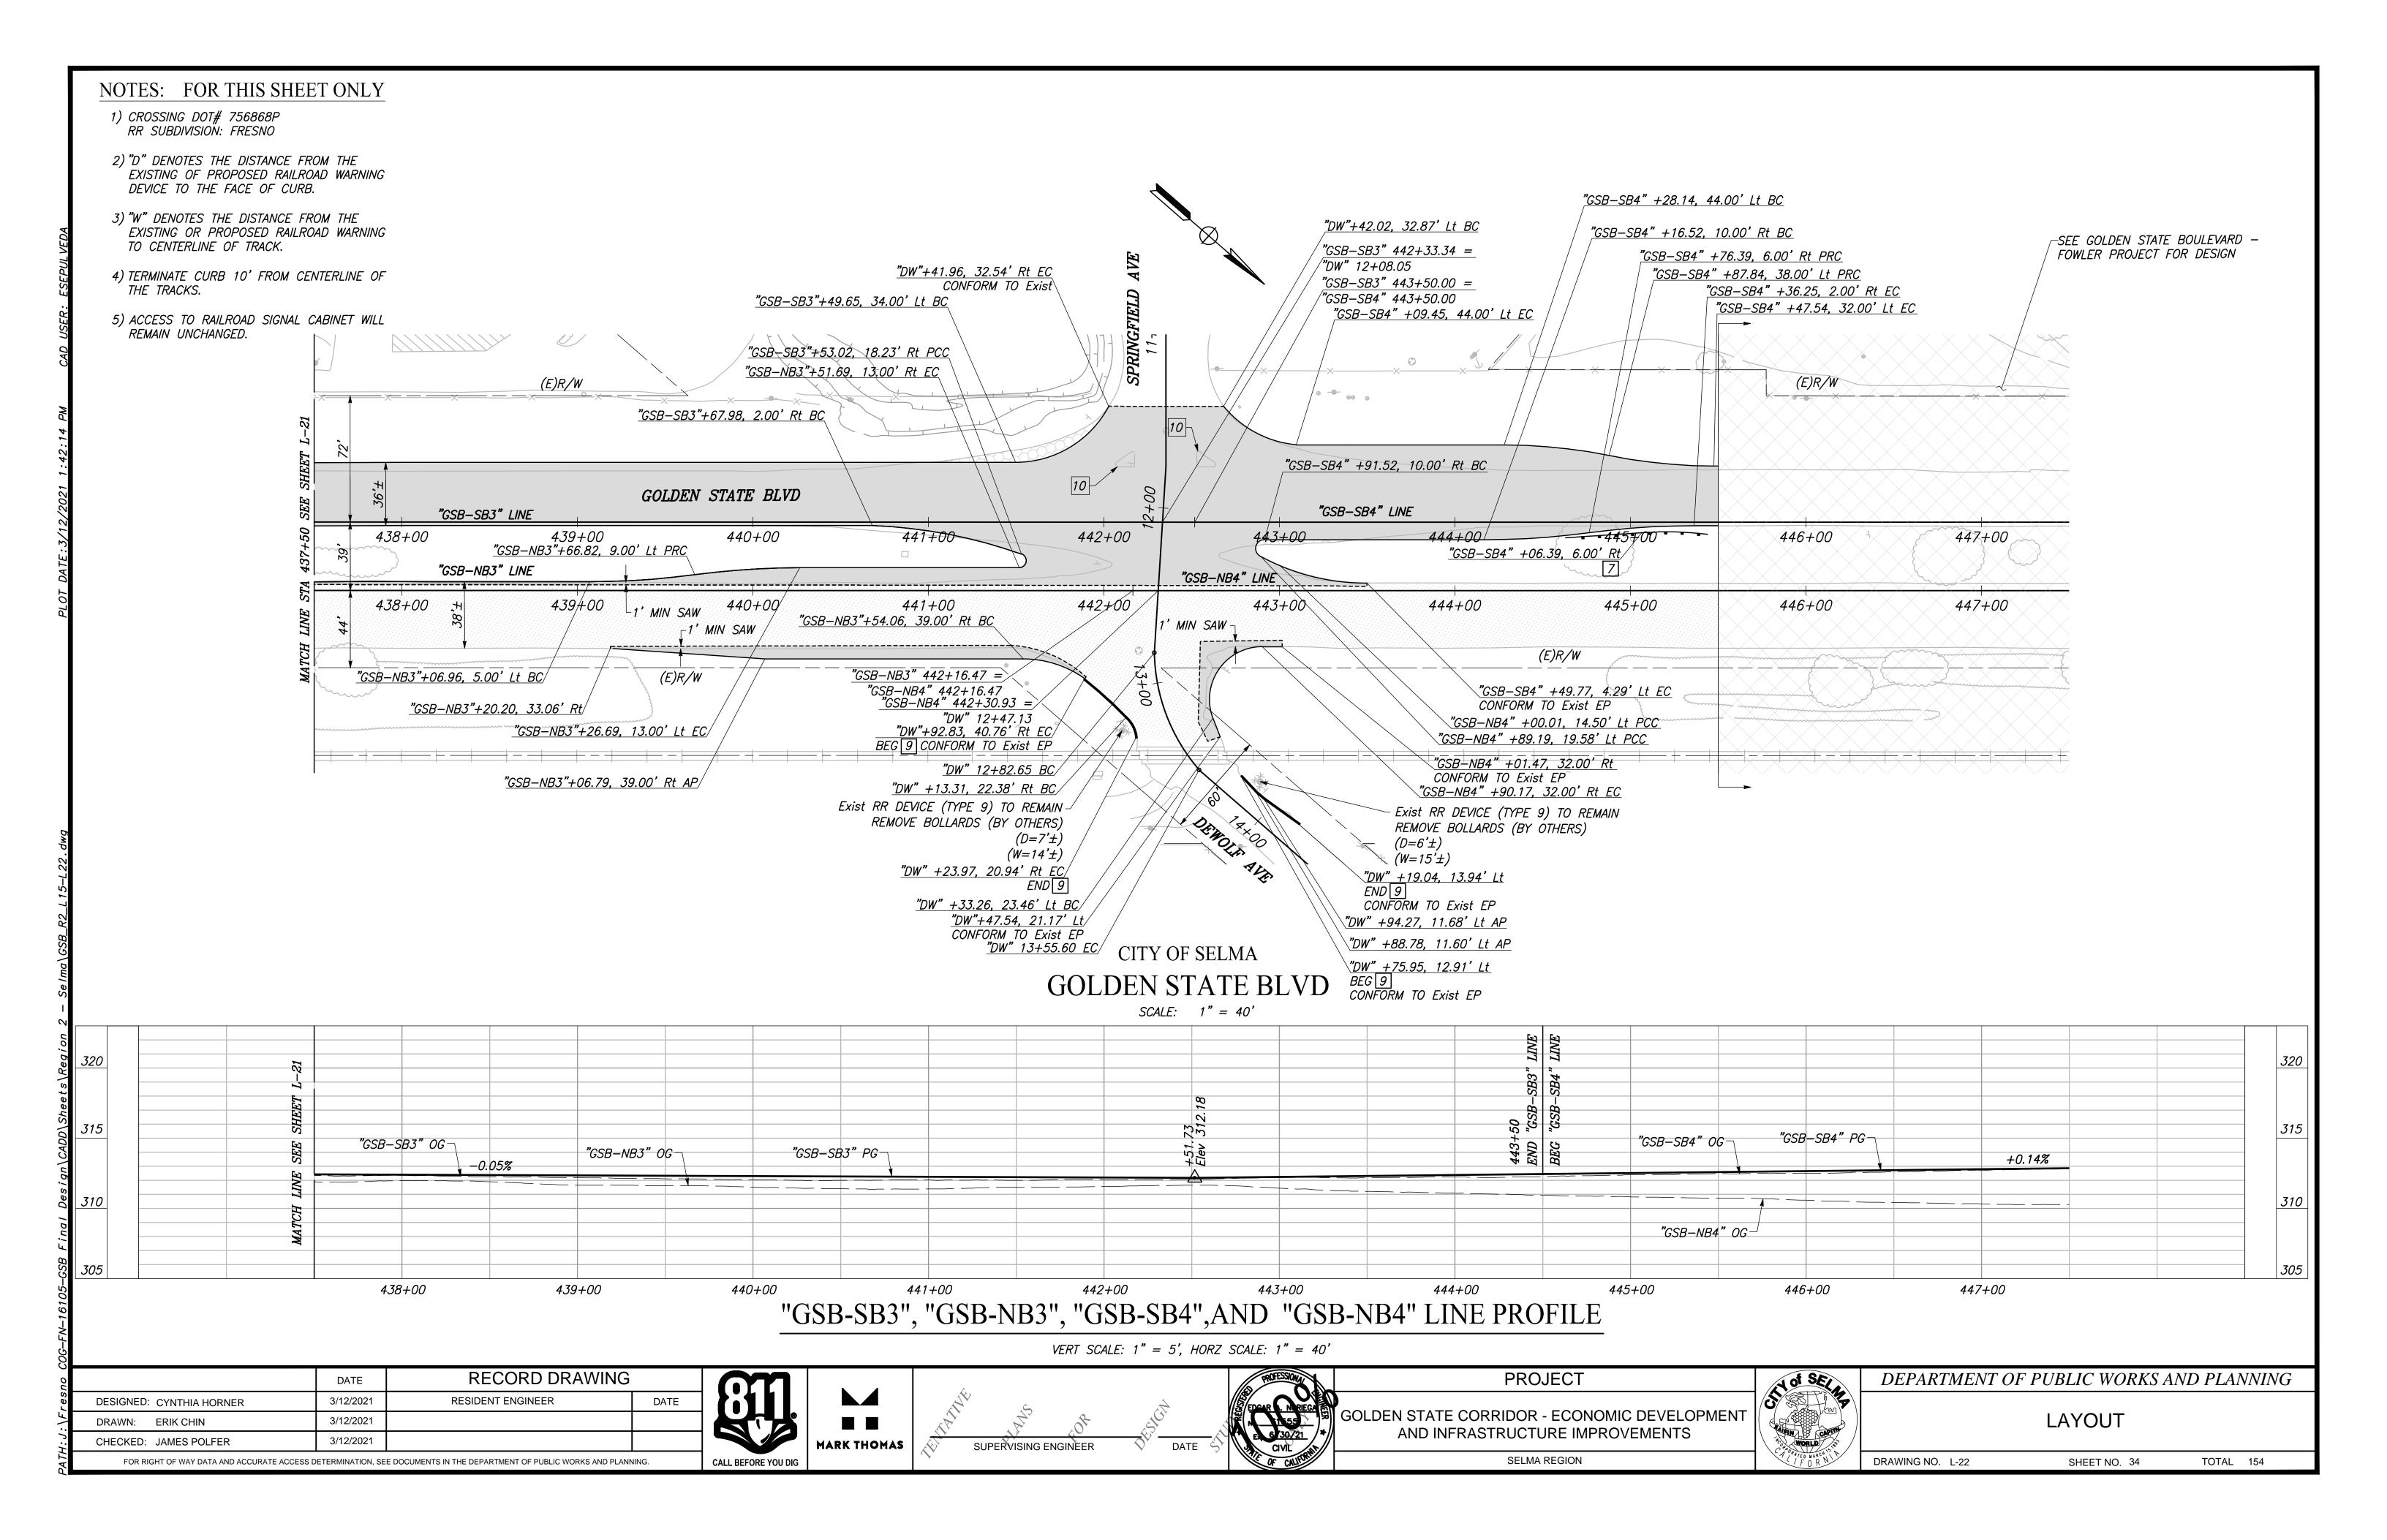

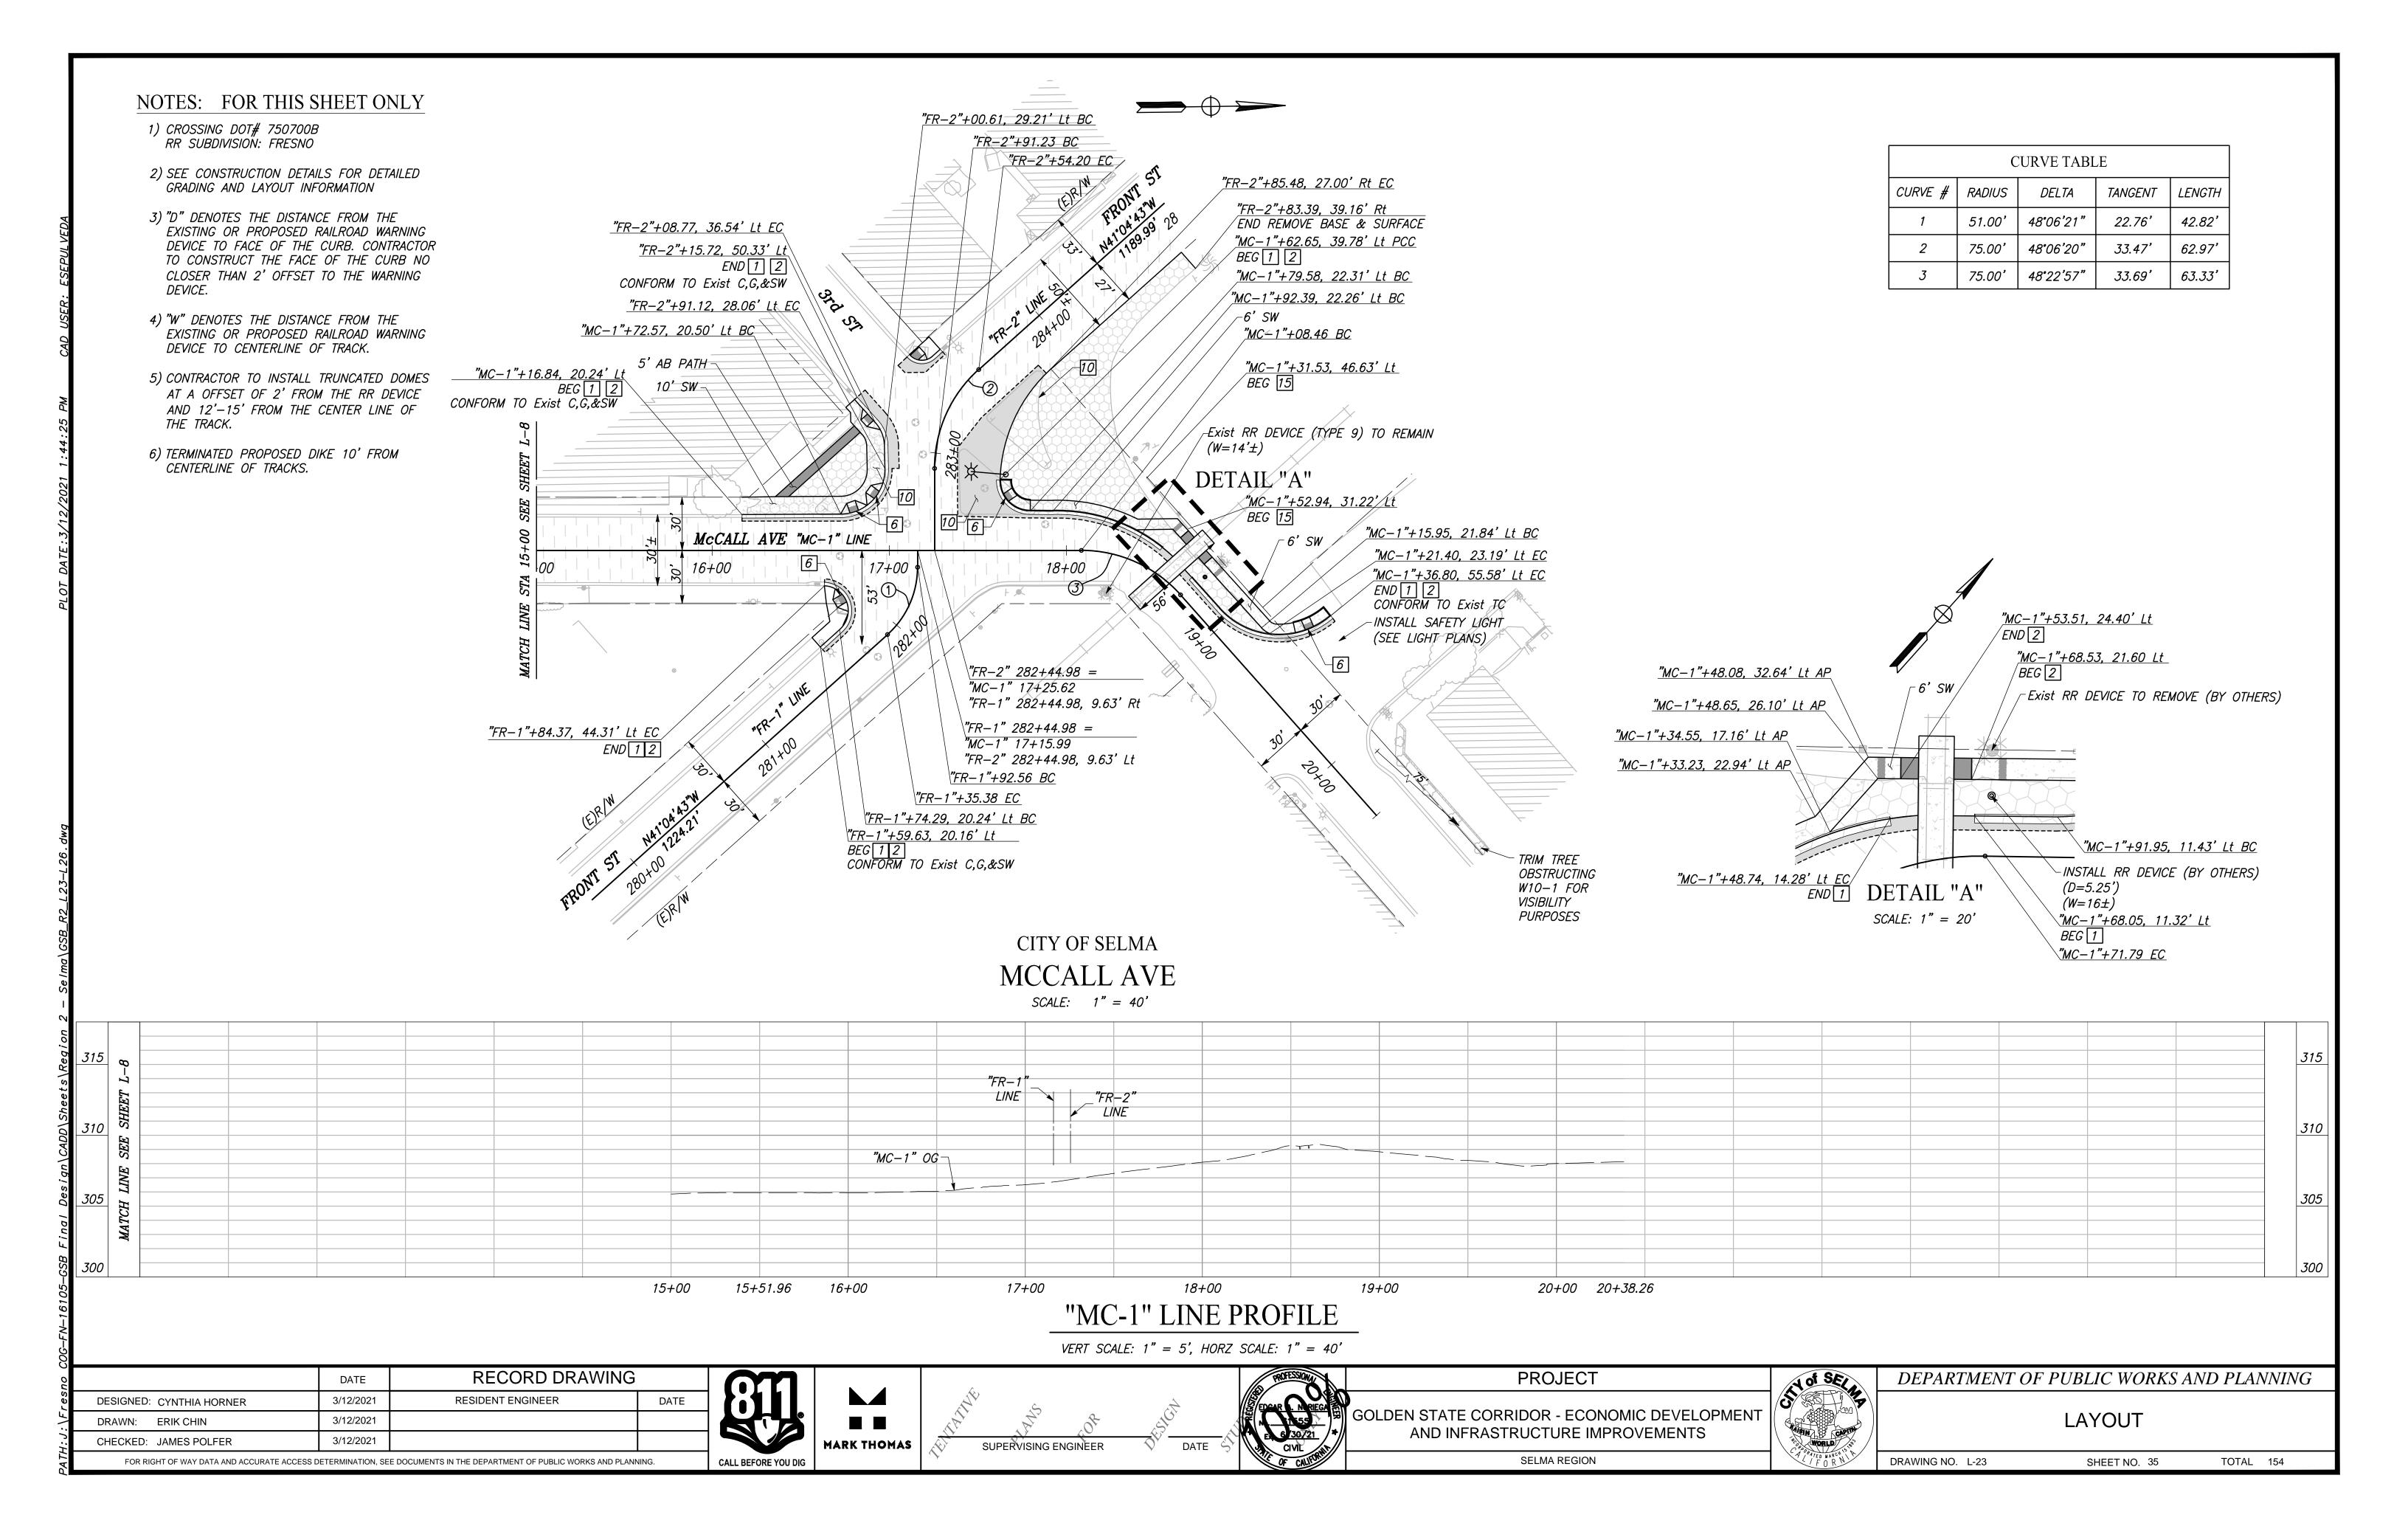

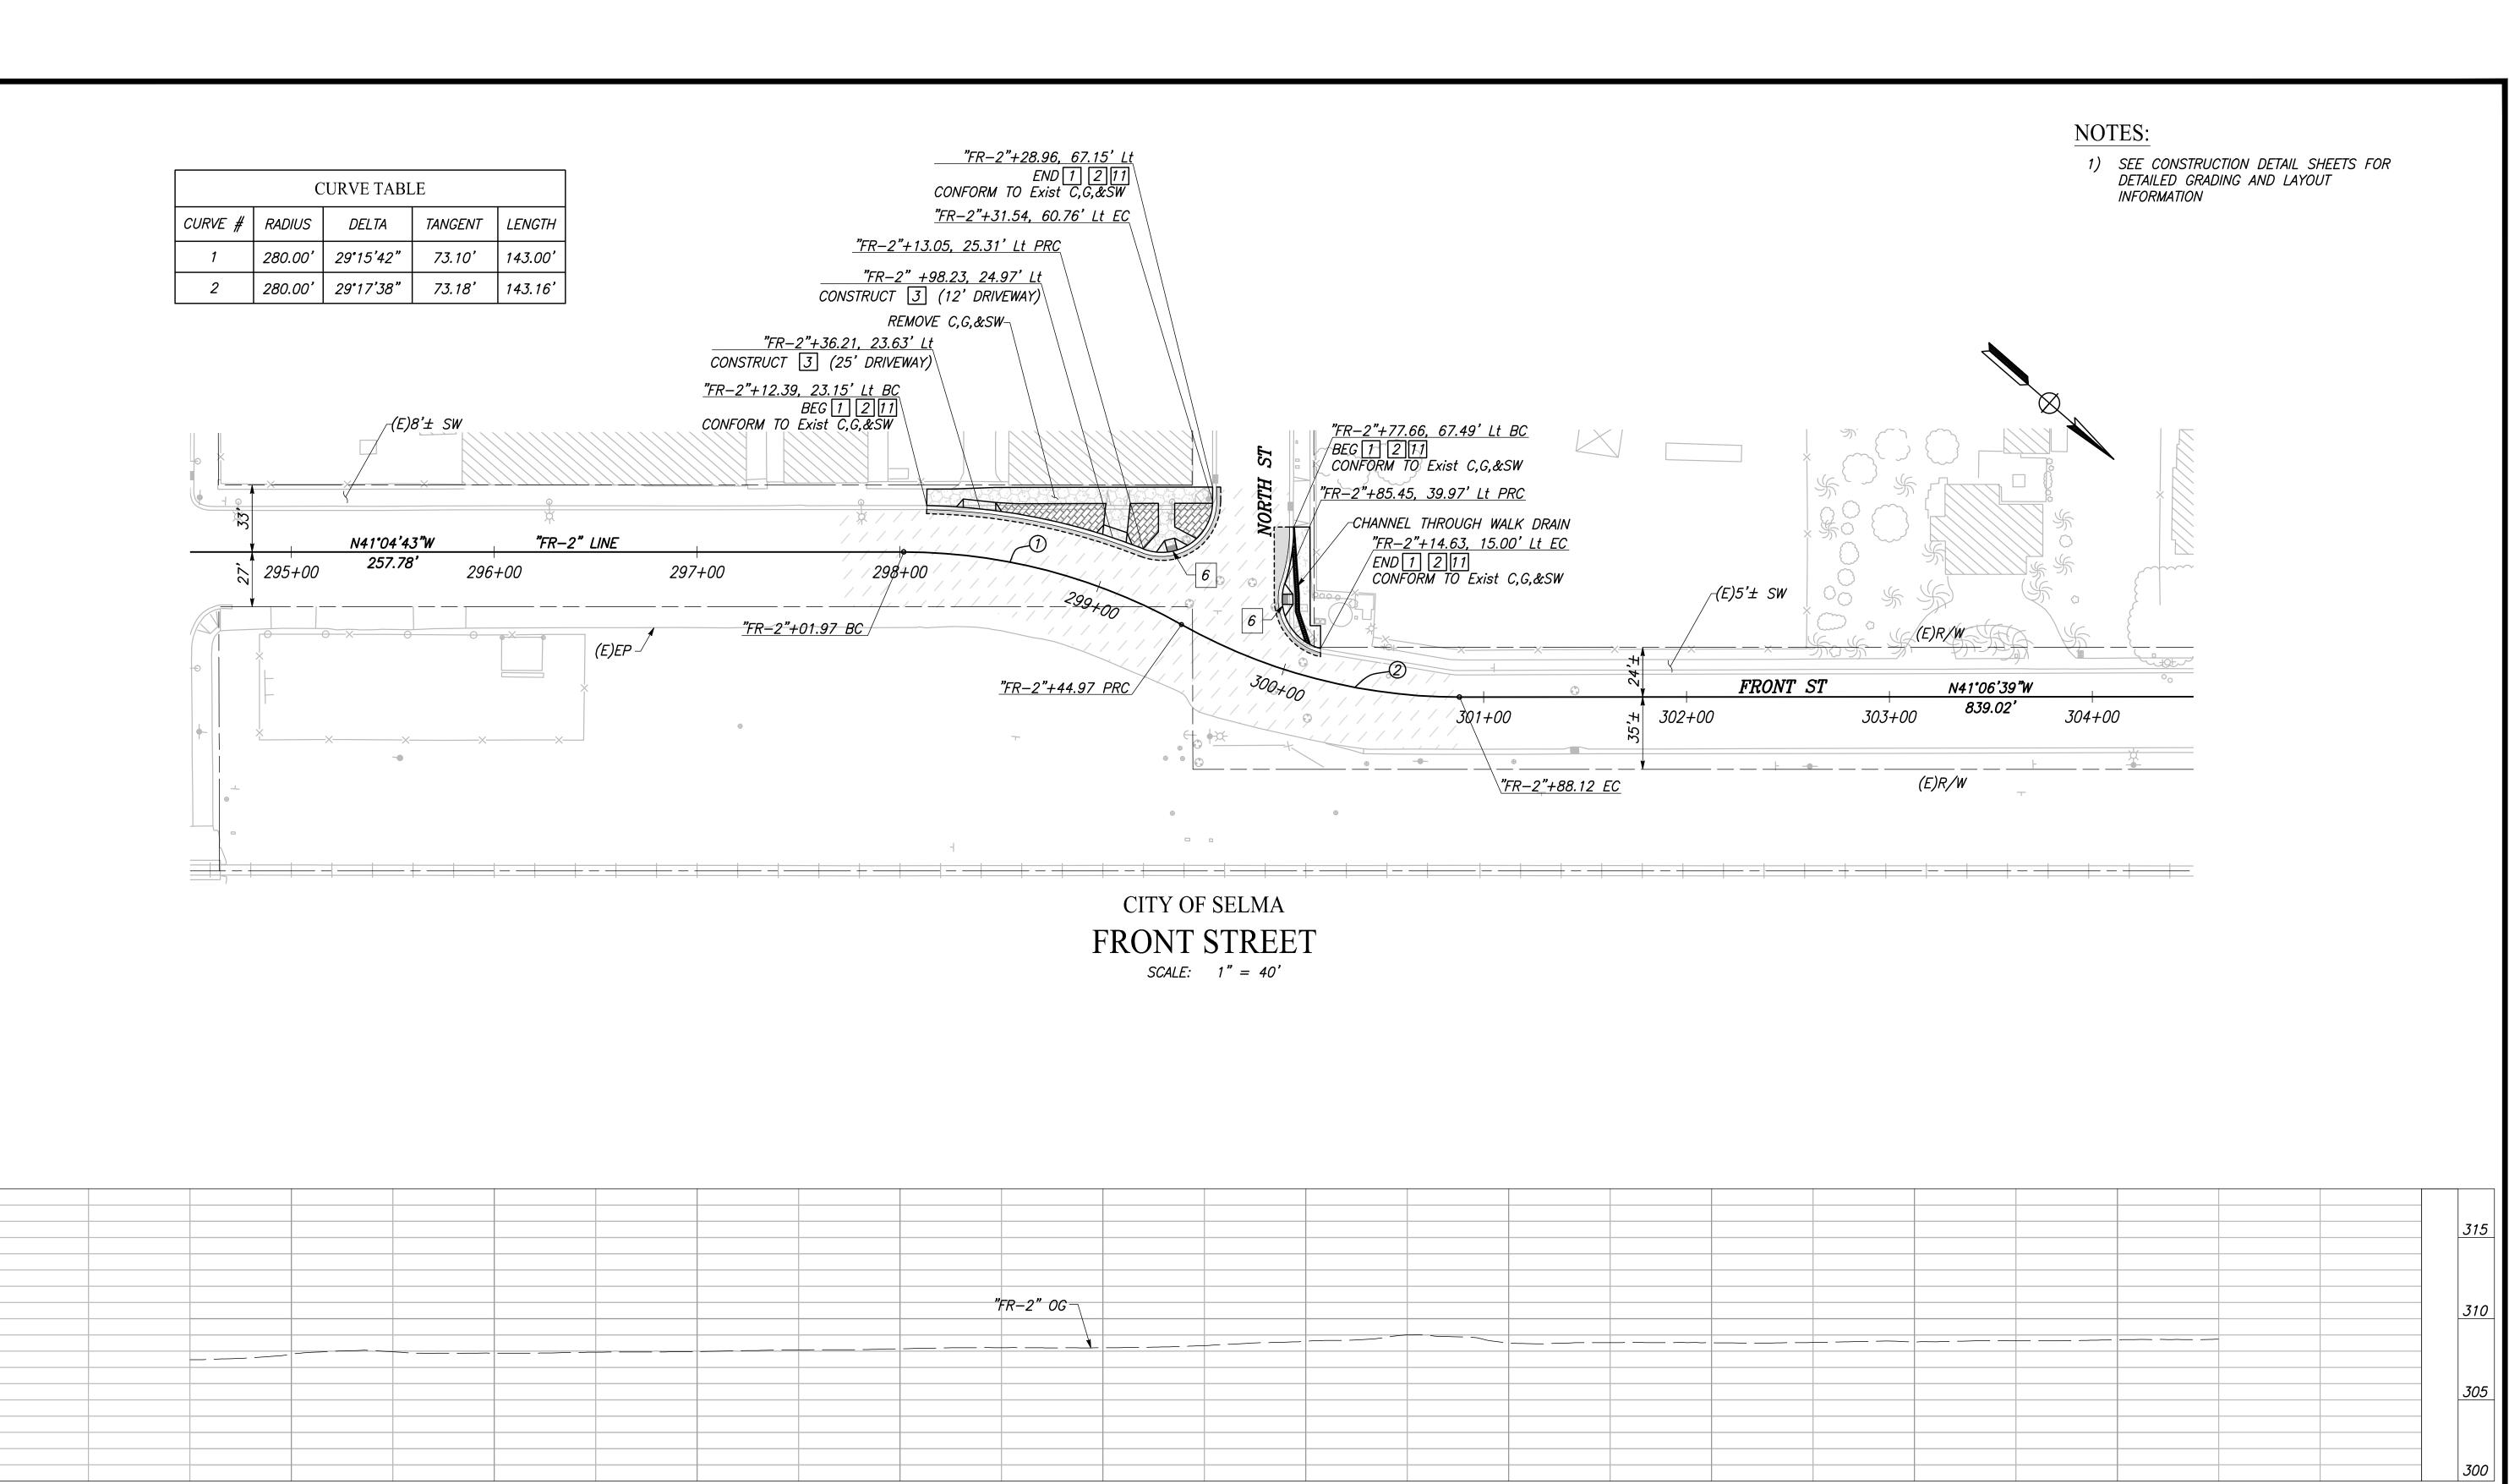

"FRONT ST" LINE PROFILE VERT SCALE: 1" = 5', HORZ SCALE: 1" = 40'

00		DATE	RECORD DRAWING		
res	DESIGNED: CYNTHIA HORNER	3/12/2021	RESIDENT ENGINEER	DATE	
>	DRAWN: ERIK CHIN	3/12/2021			
): h	CHECKED: JAMES POLFER	3/12/2021			
A	FOR RIGHT OF WAY DATA AND ACCURATE ACCESS DETERMINATION, SEE DOCUMENTS IN THE DEPARTMENT OF PUBLIC WORKS AND PLANNING.				

295+00

296+00

294+00


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297+00


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MARK THOMAS

298+00



299+00

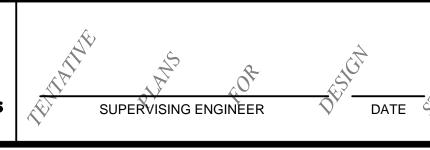

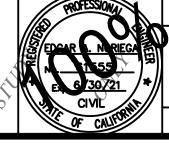300+00

GOLDEN STATE CORRIDOR - ECONOMIC DEVELOPMENT AND INFRASTRUCTURE IMPROVEMENTS

SELMA REGION

PROJECT

302+00

301+00



303+00


DEPARTMENT OF PUBLIC WORKS AND PLANNING


305+00

LAYOUT

304+00

DRAWING NO. L-24 SHEET NO. 36 TOTAL 154

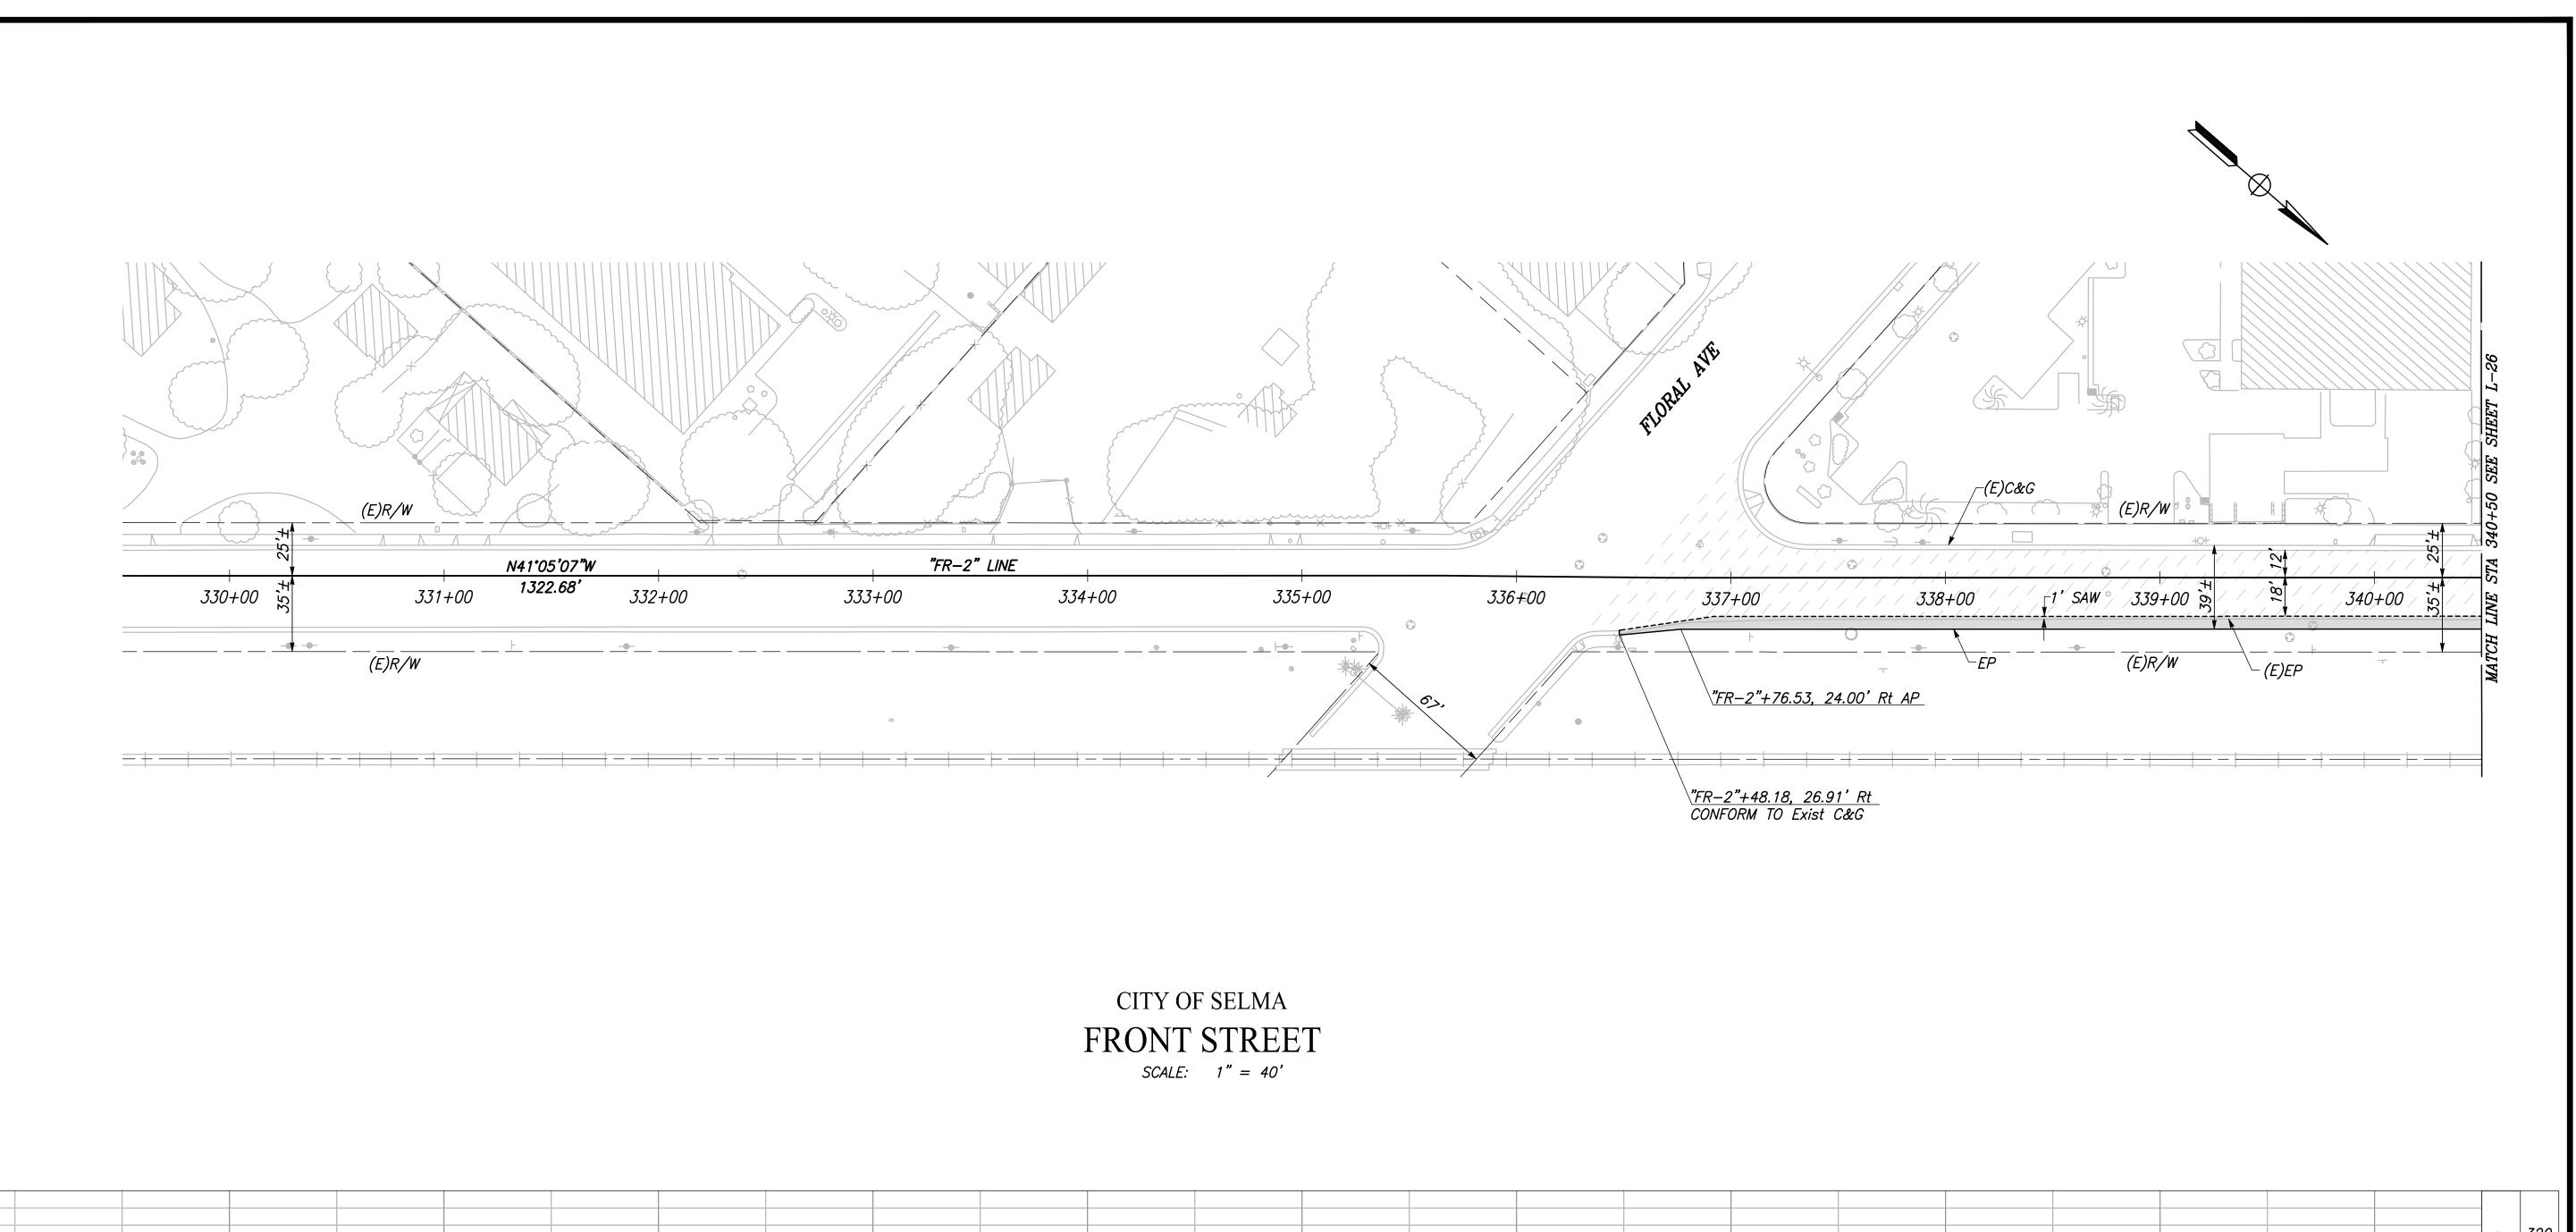

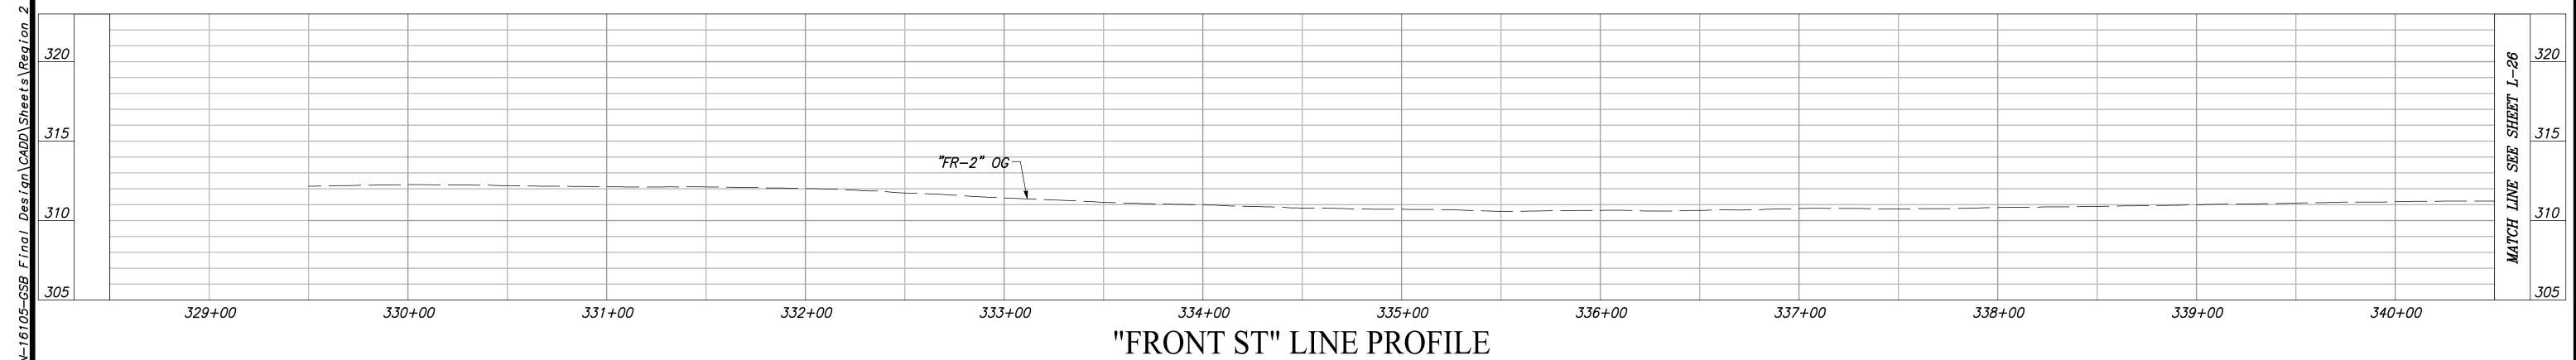

VERT SCALE: 1" = 5', HORZ SCALE: 1" = 40'


ა 				
p DATE RECORD DRAWING				
ပ မ	DESIGNED: CYNTHIA HORNER	3/12/2021	RESIDENT ENGINEER	DATE
<u> </u>	DRAWN: ERIK CHIN	3/12/2021		
): L	CHECKED: JAMES POLFER	3/12/2021		
_				

FOR RIGHT OF WAY DATA AND ACCURATE ACCESS DETERMINATION, SEE DOCUMENTS IN THE DEPARTMENT OF PUBLIC WORKS AND PLANNING.



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MARK THOMAS



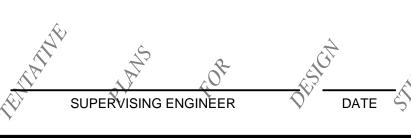

GOLDEN STATE CORRIDOR - ECONOMIC DEVELOPMENT AND INFRASTRUCTURE IMPROVEMENTS


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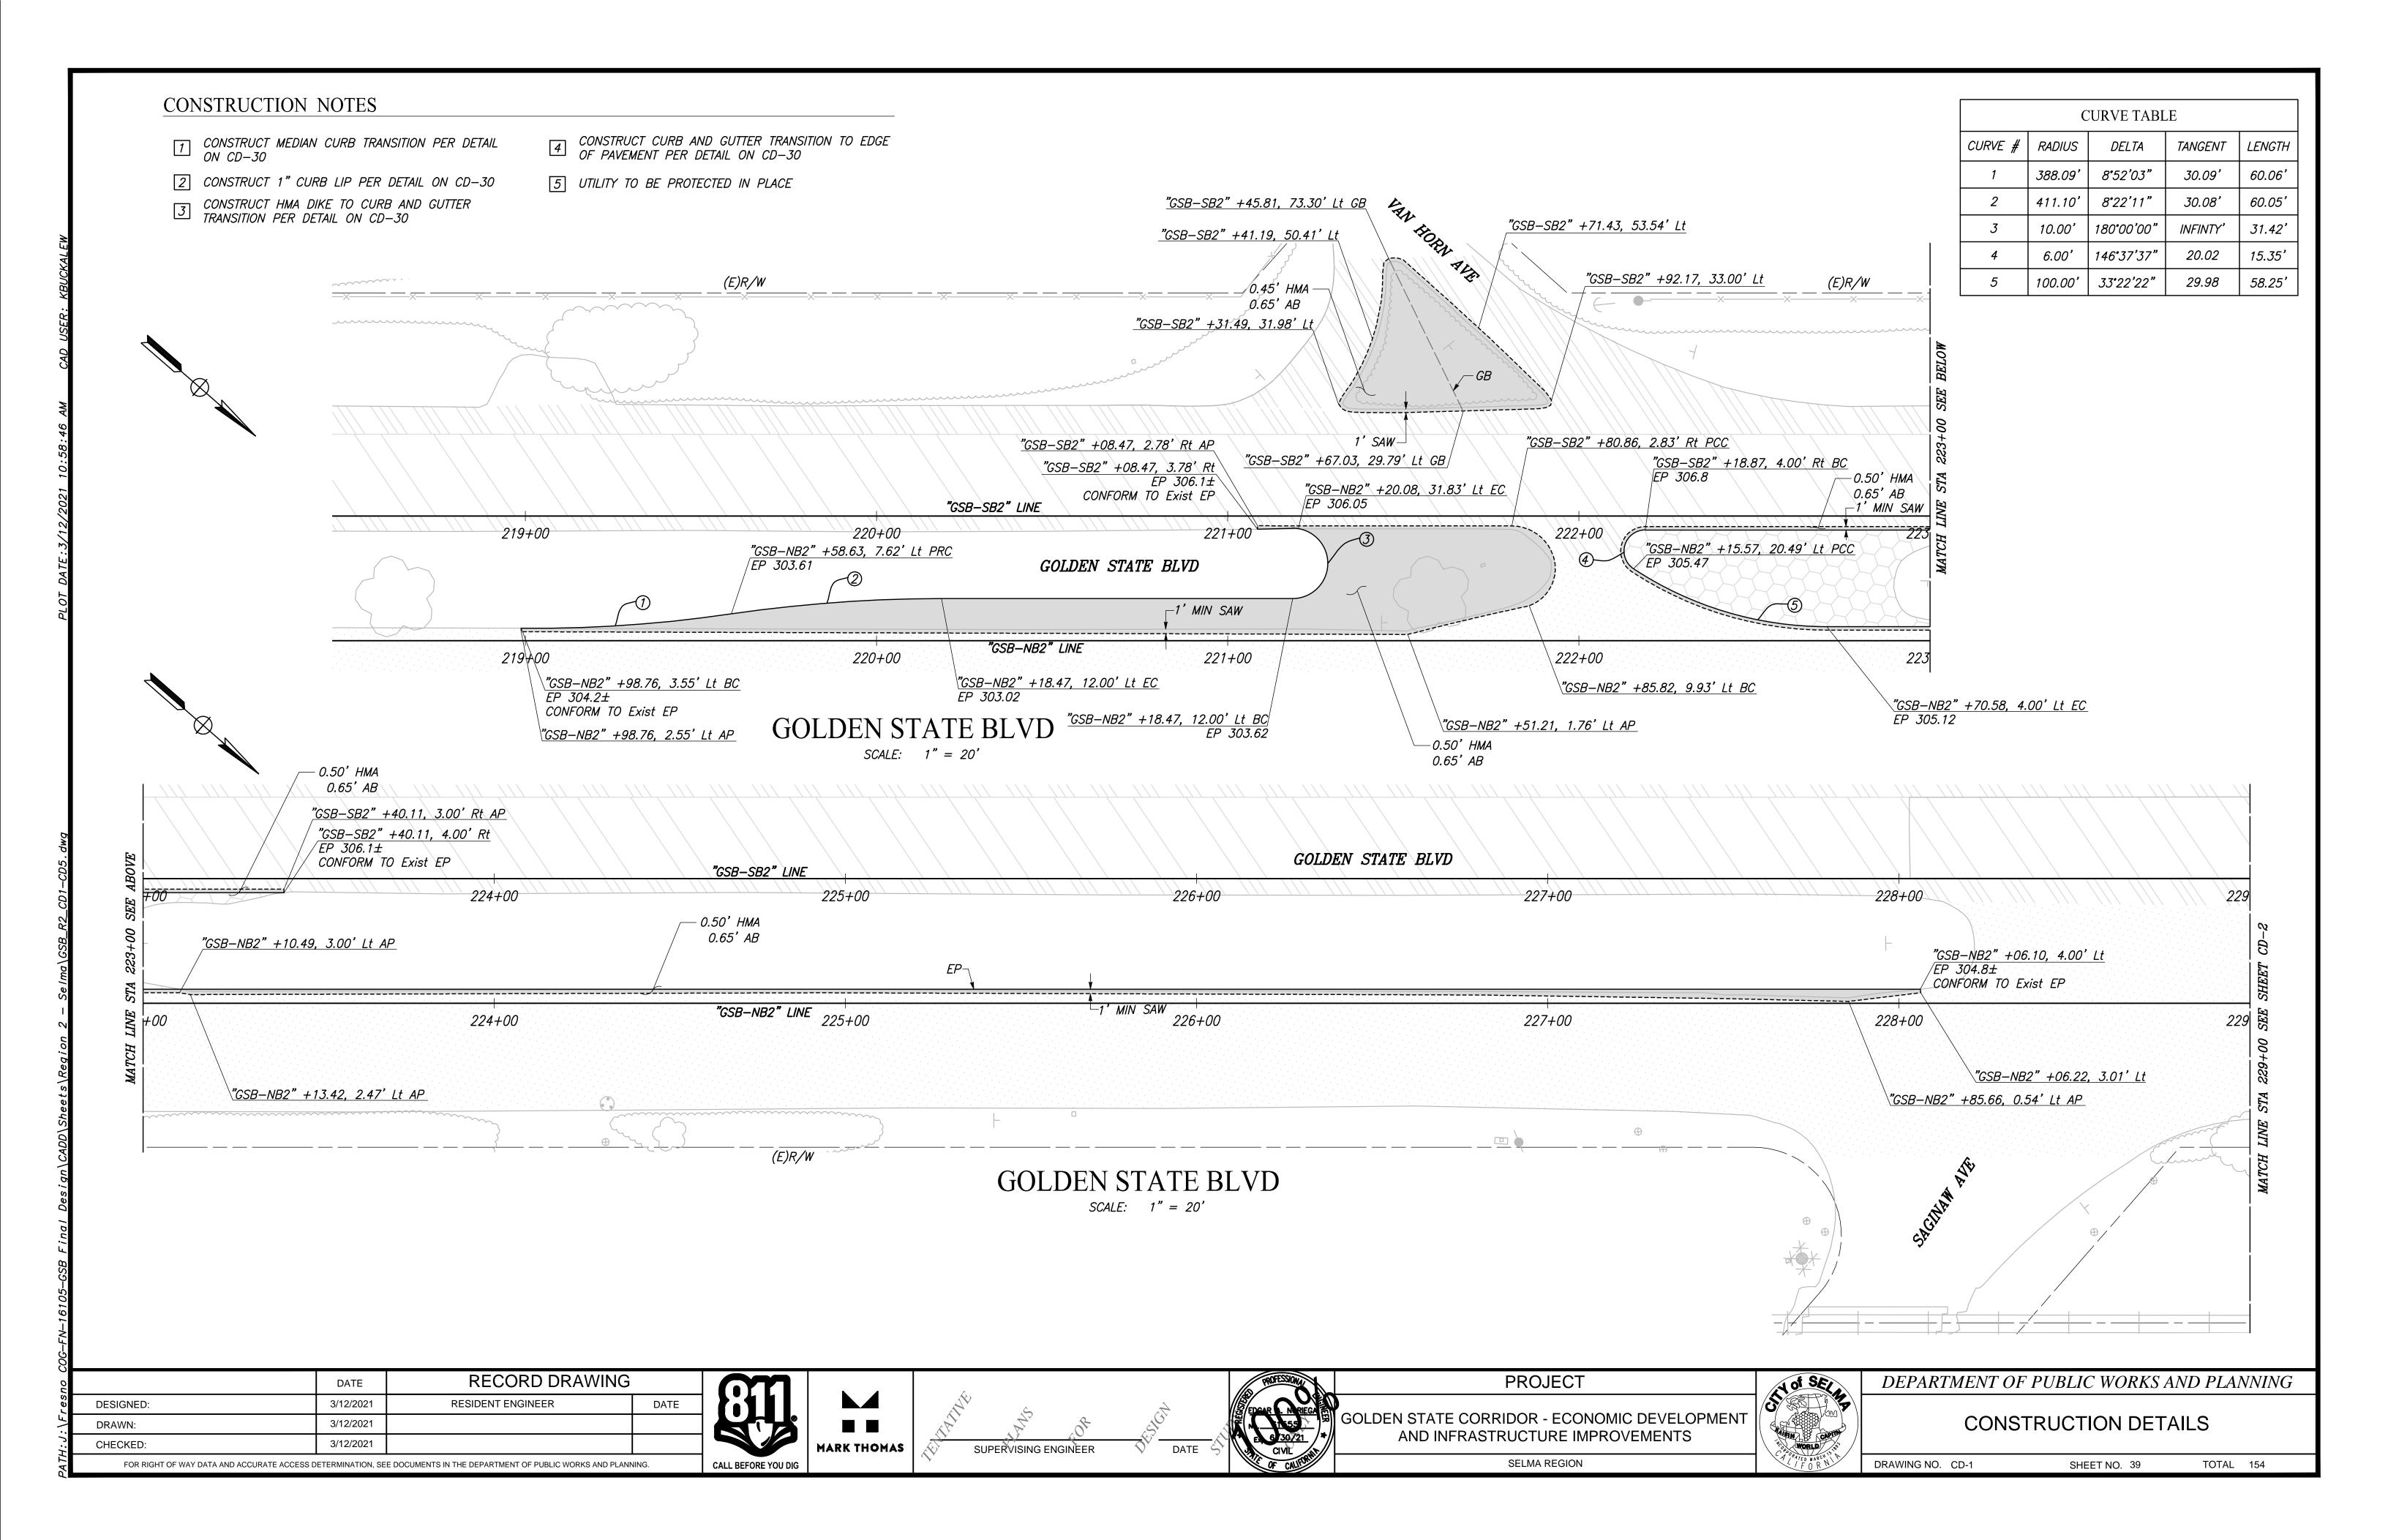
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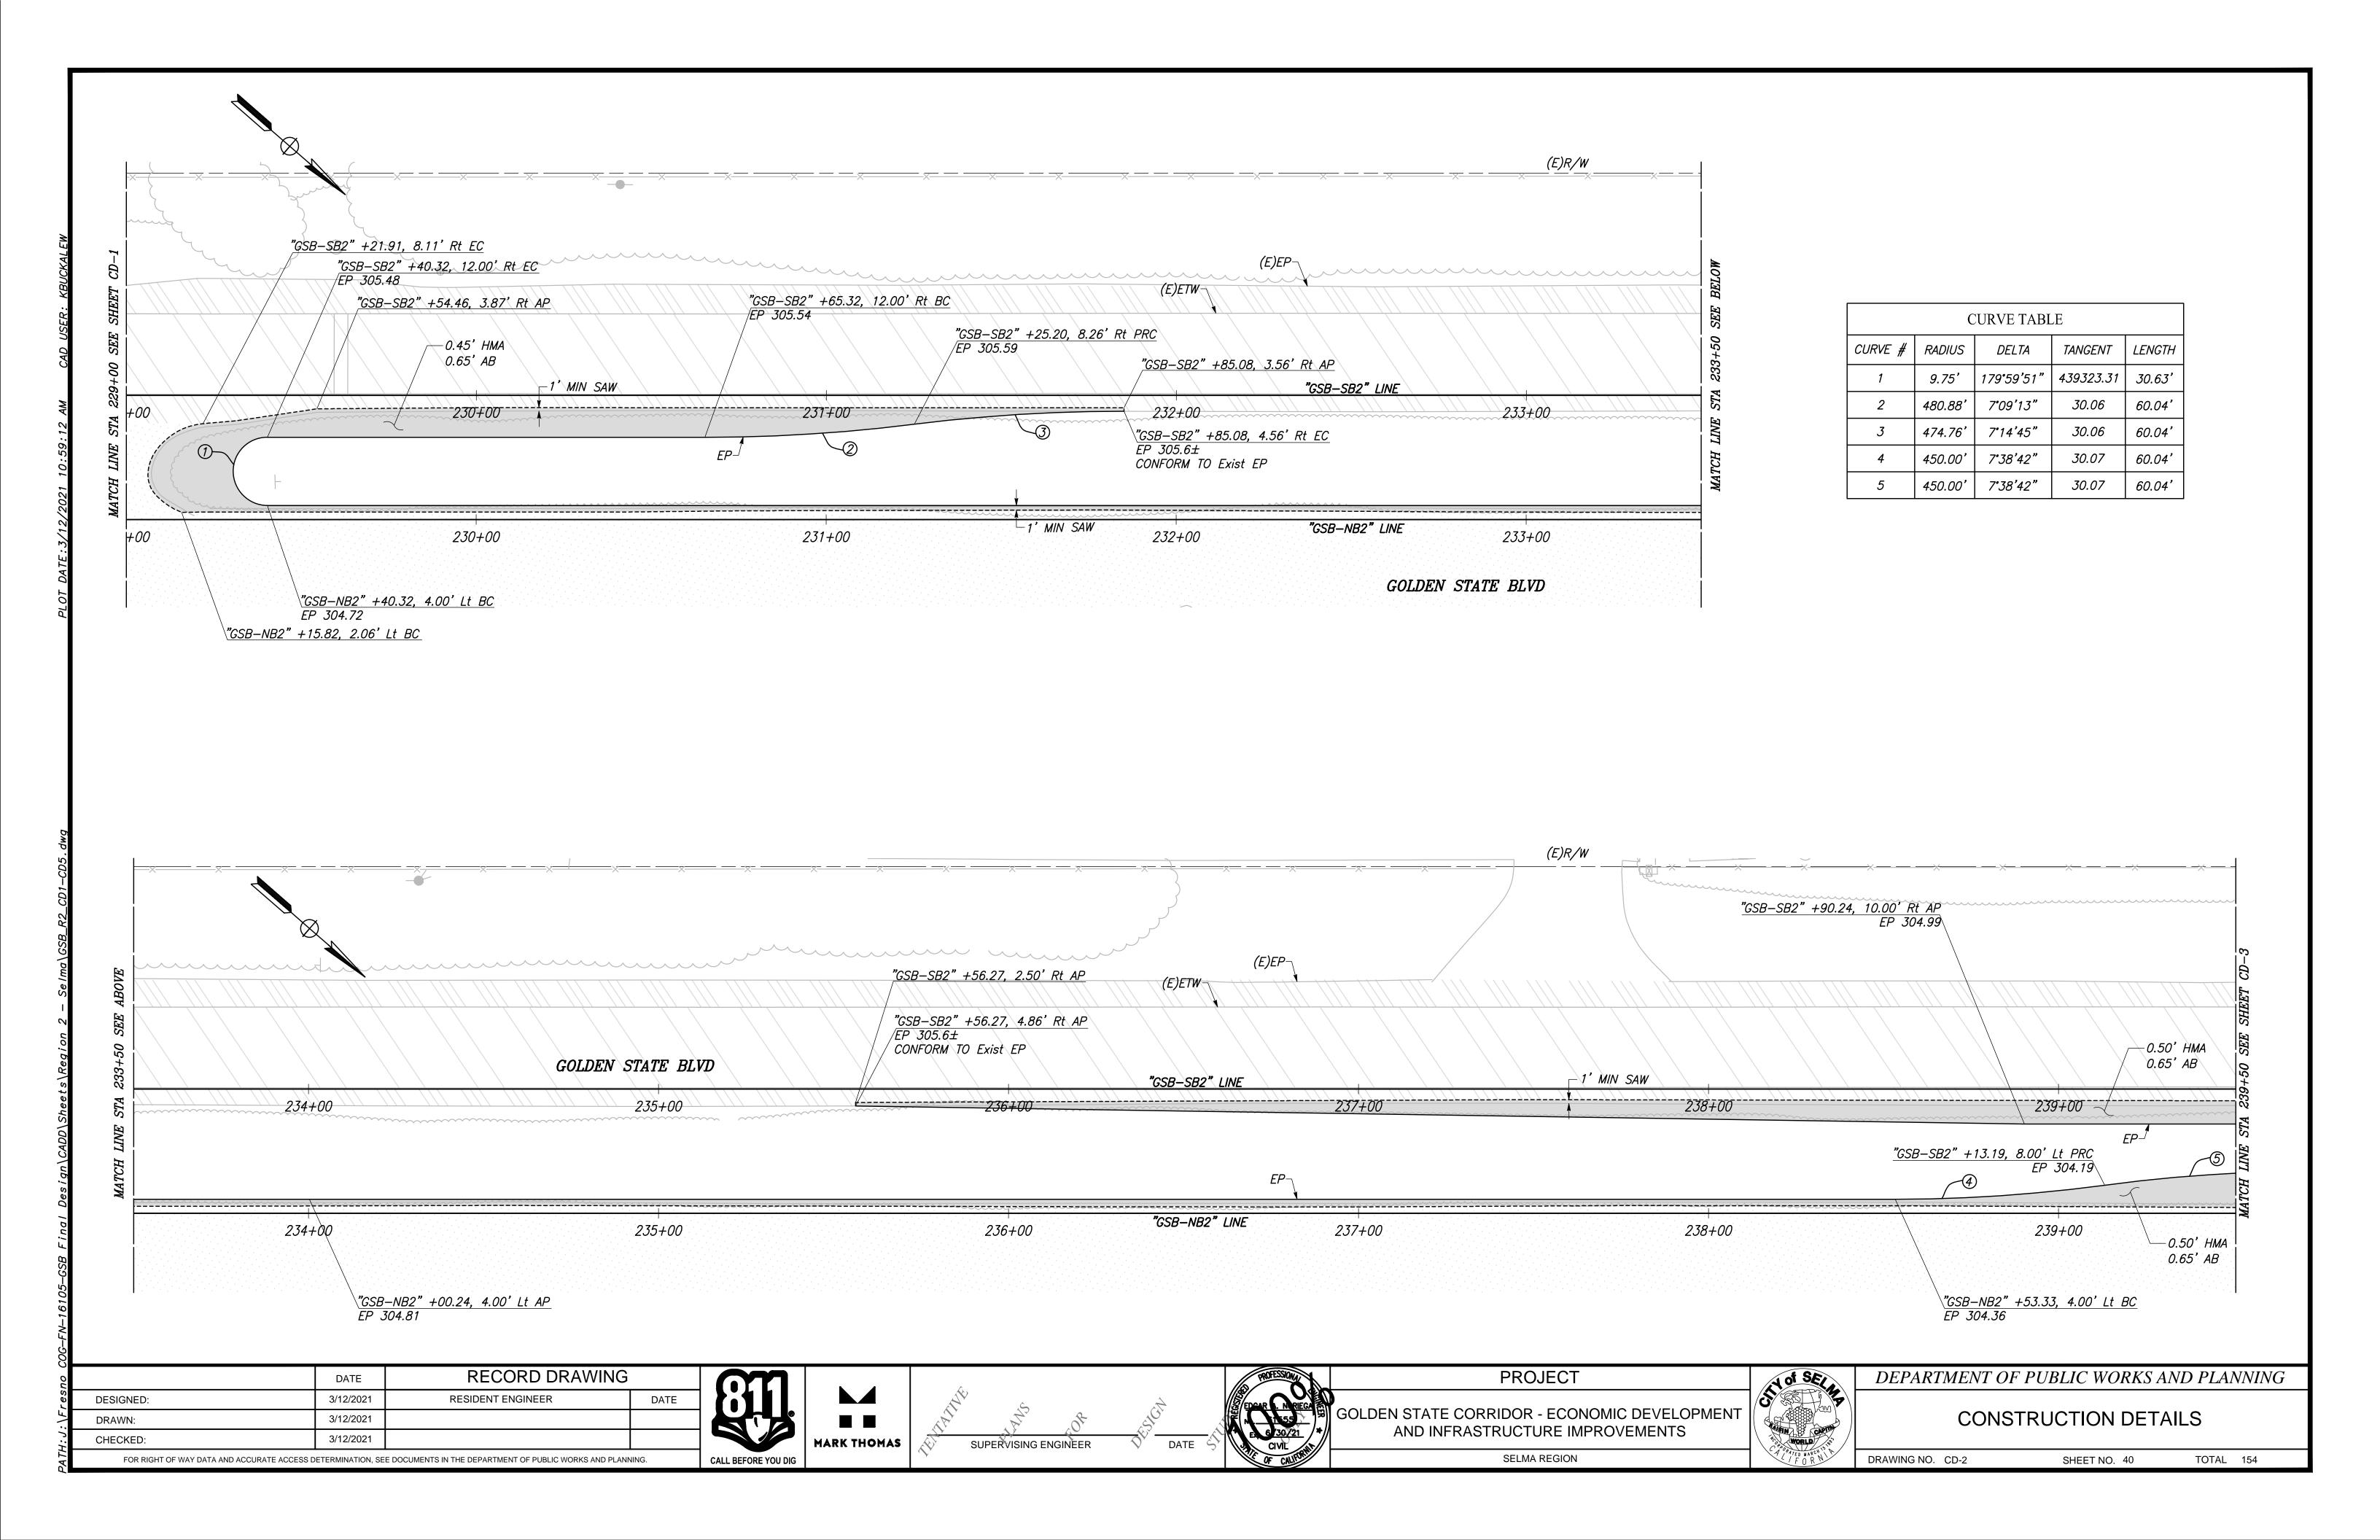



DEPARTMENT OF PUBLIC WORKS AND PLANNING


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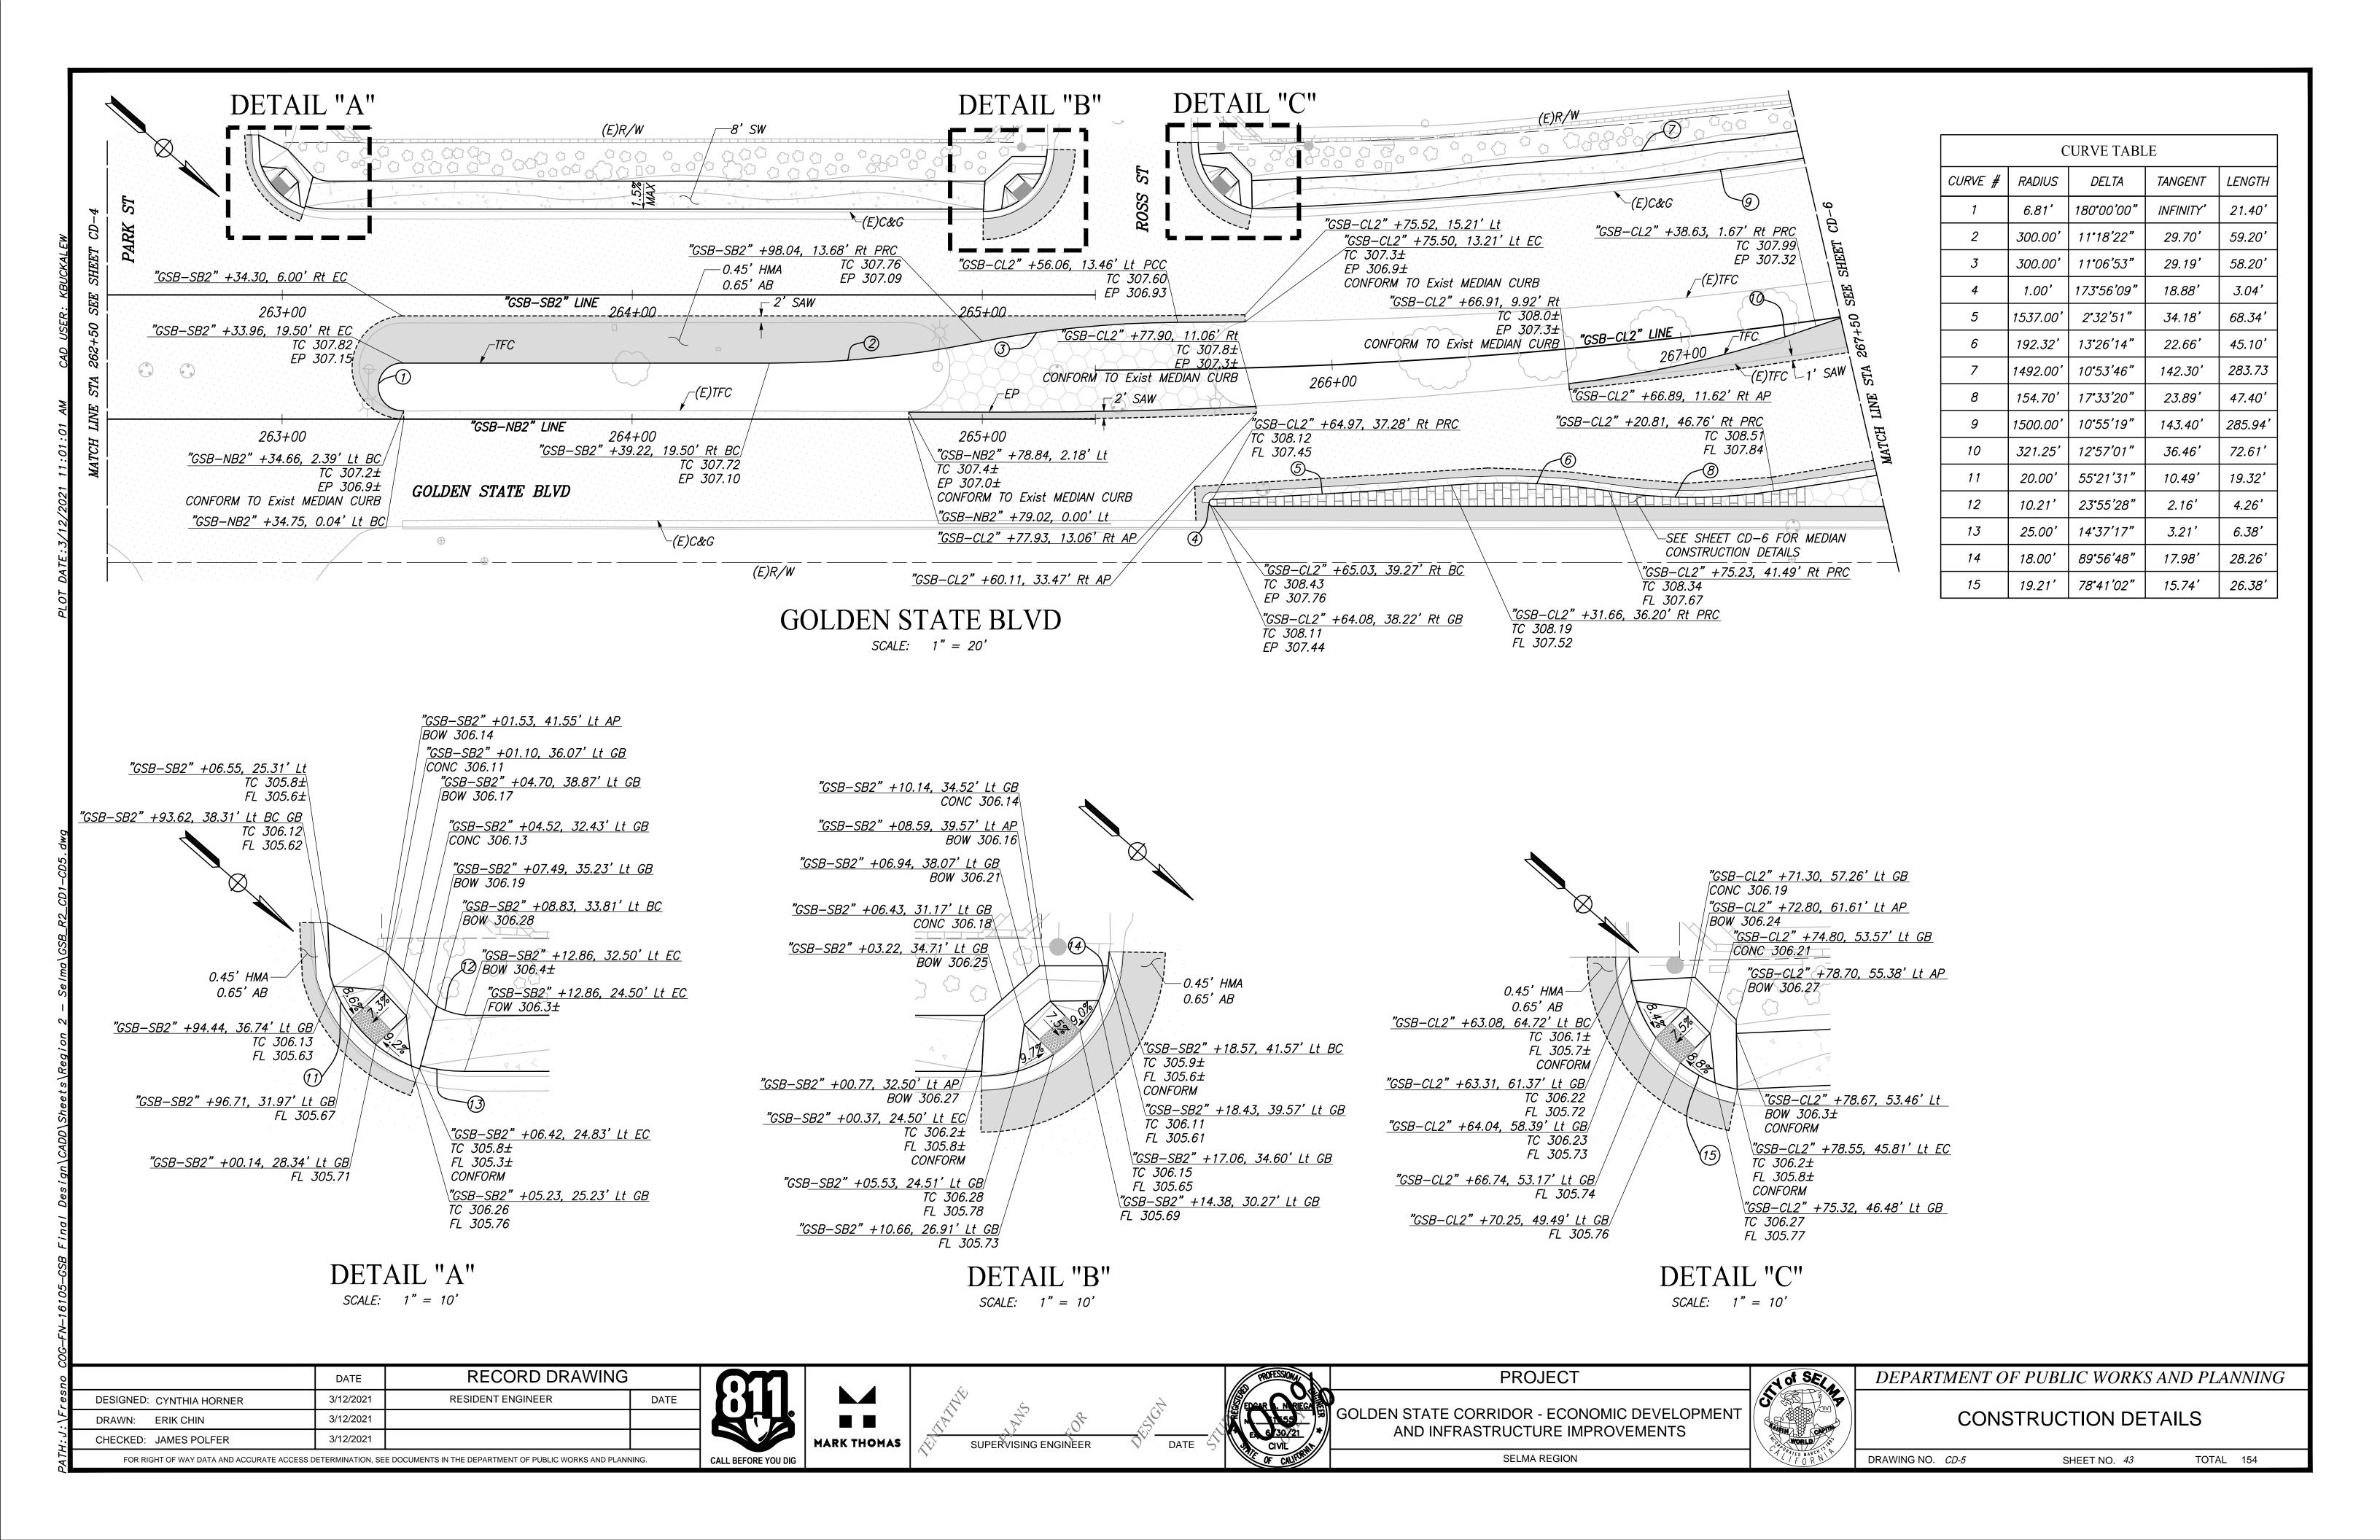







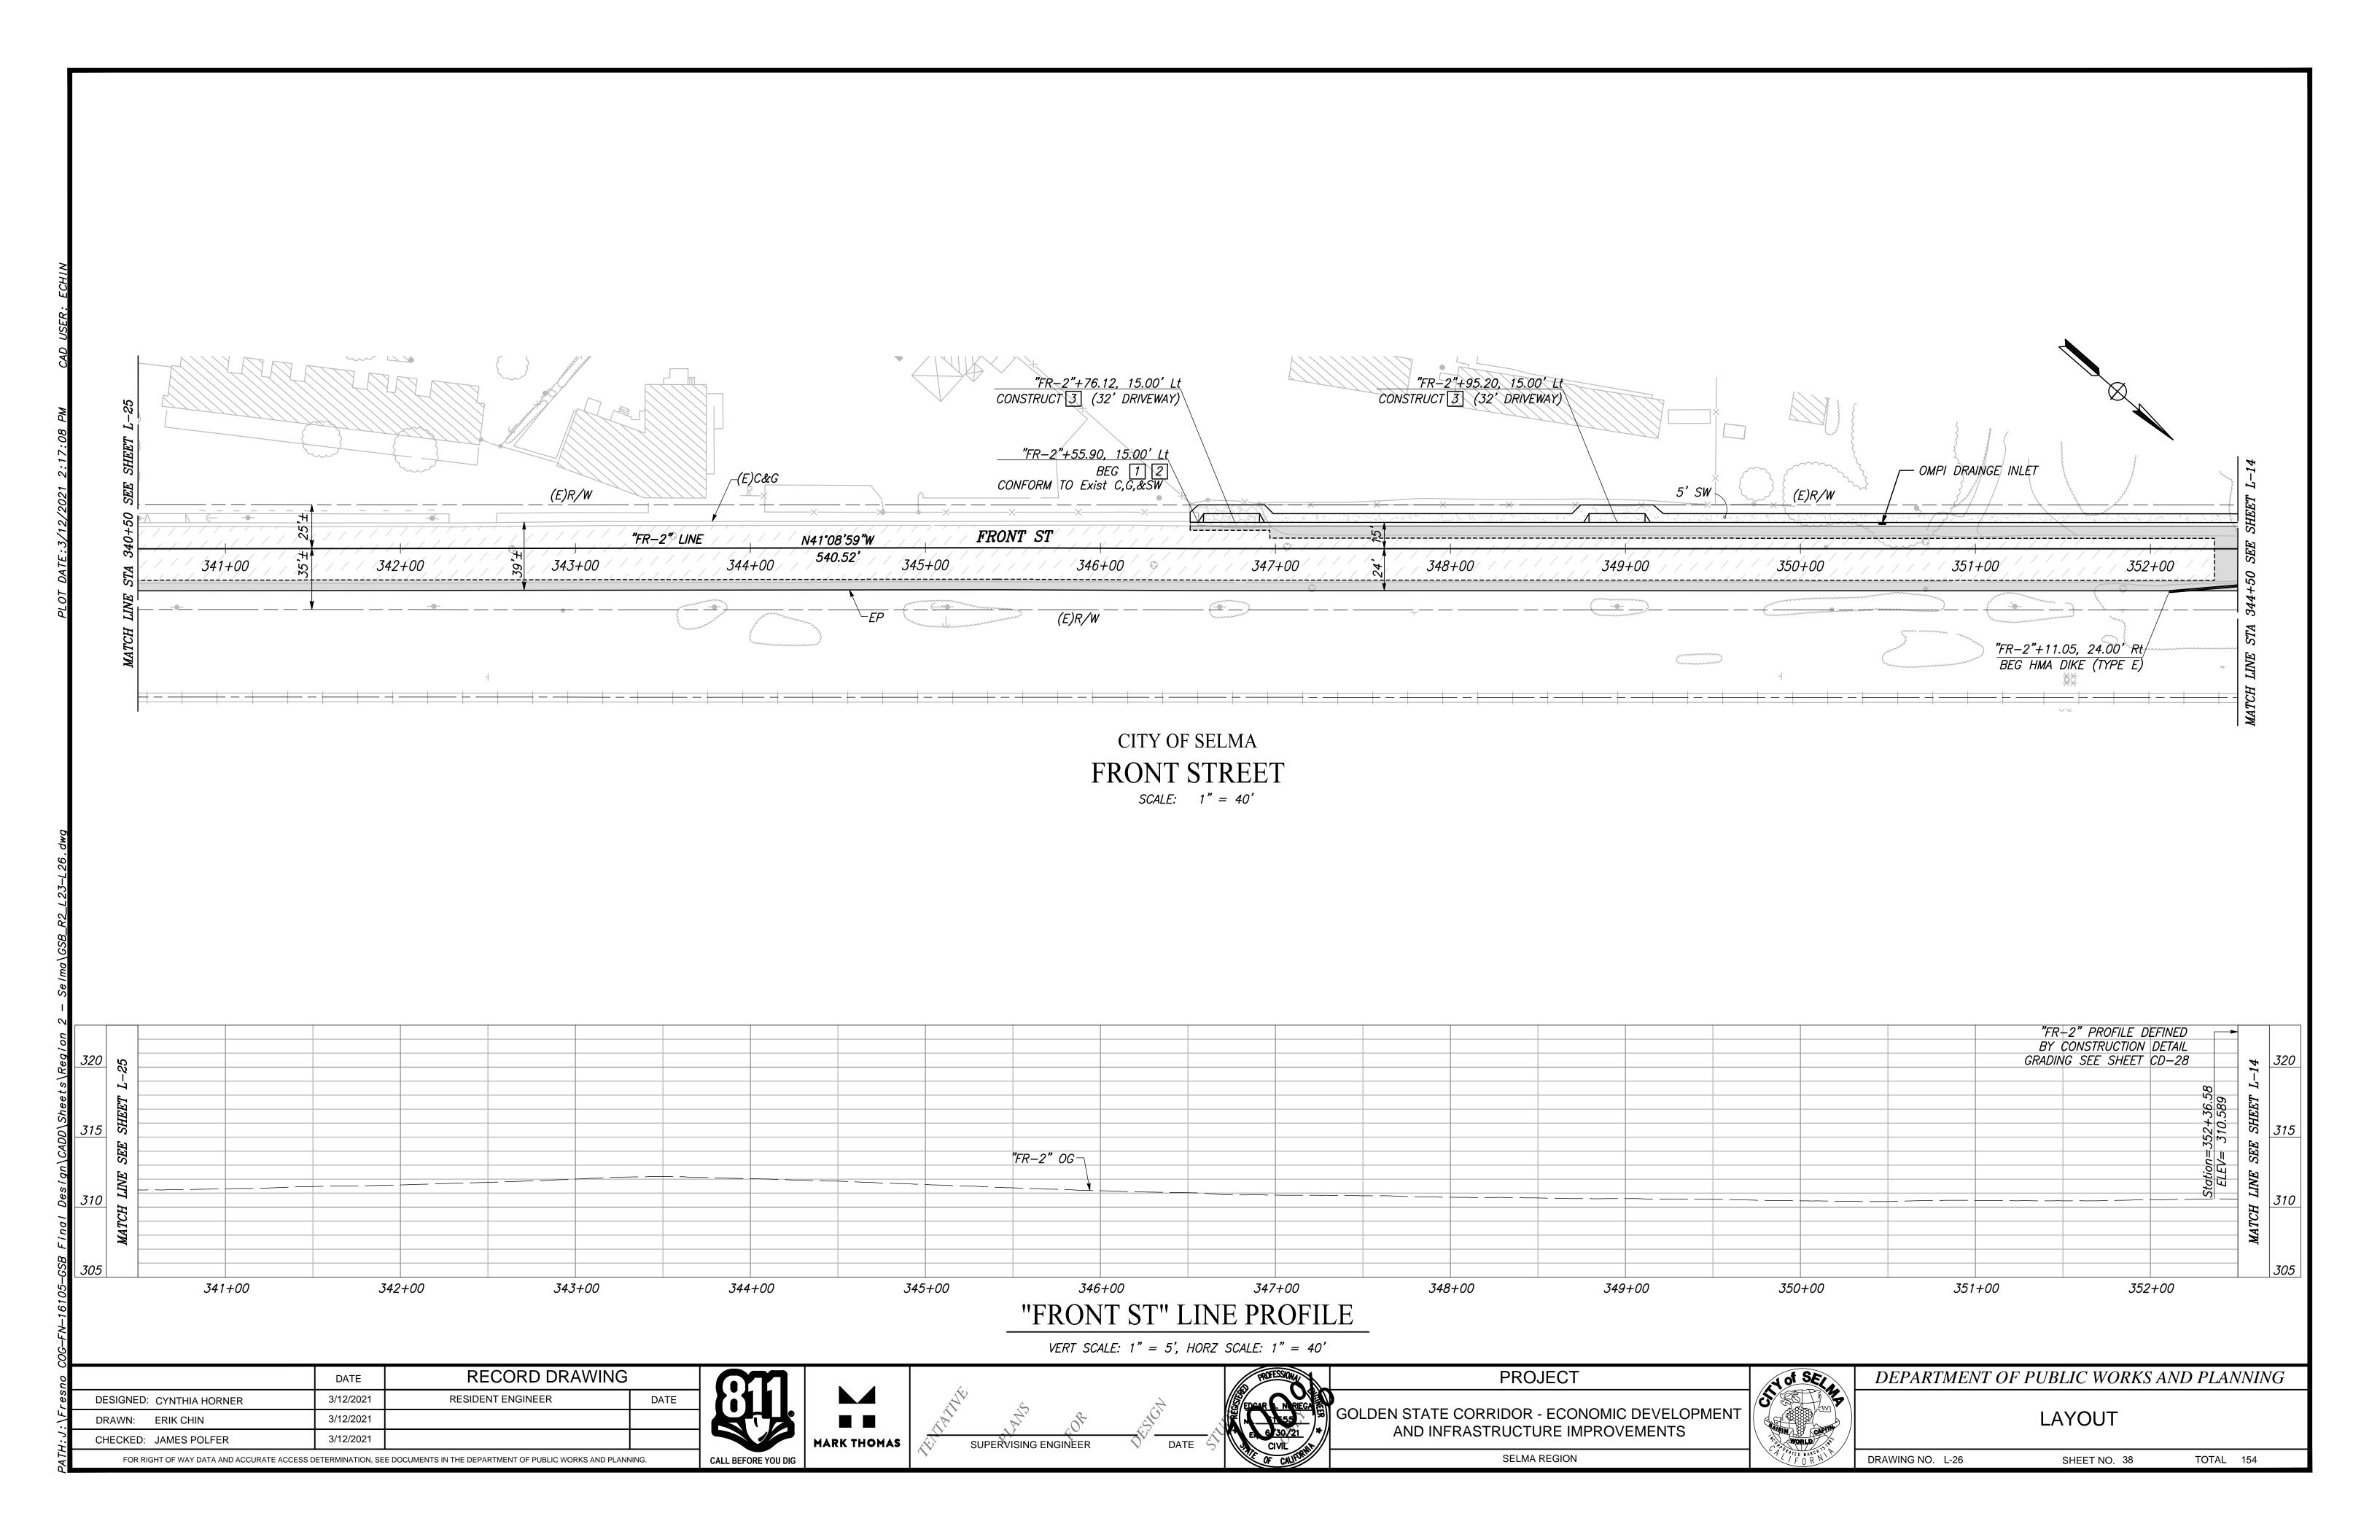

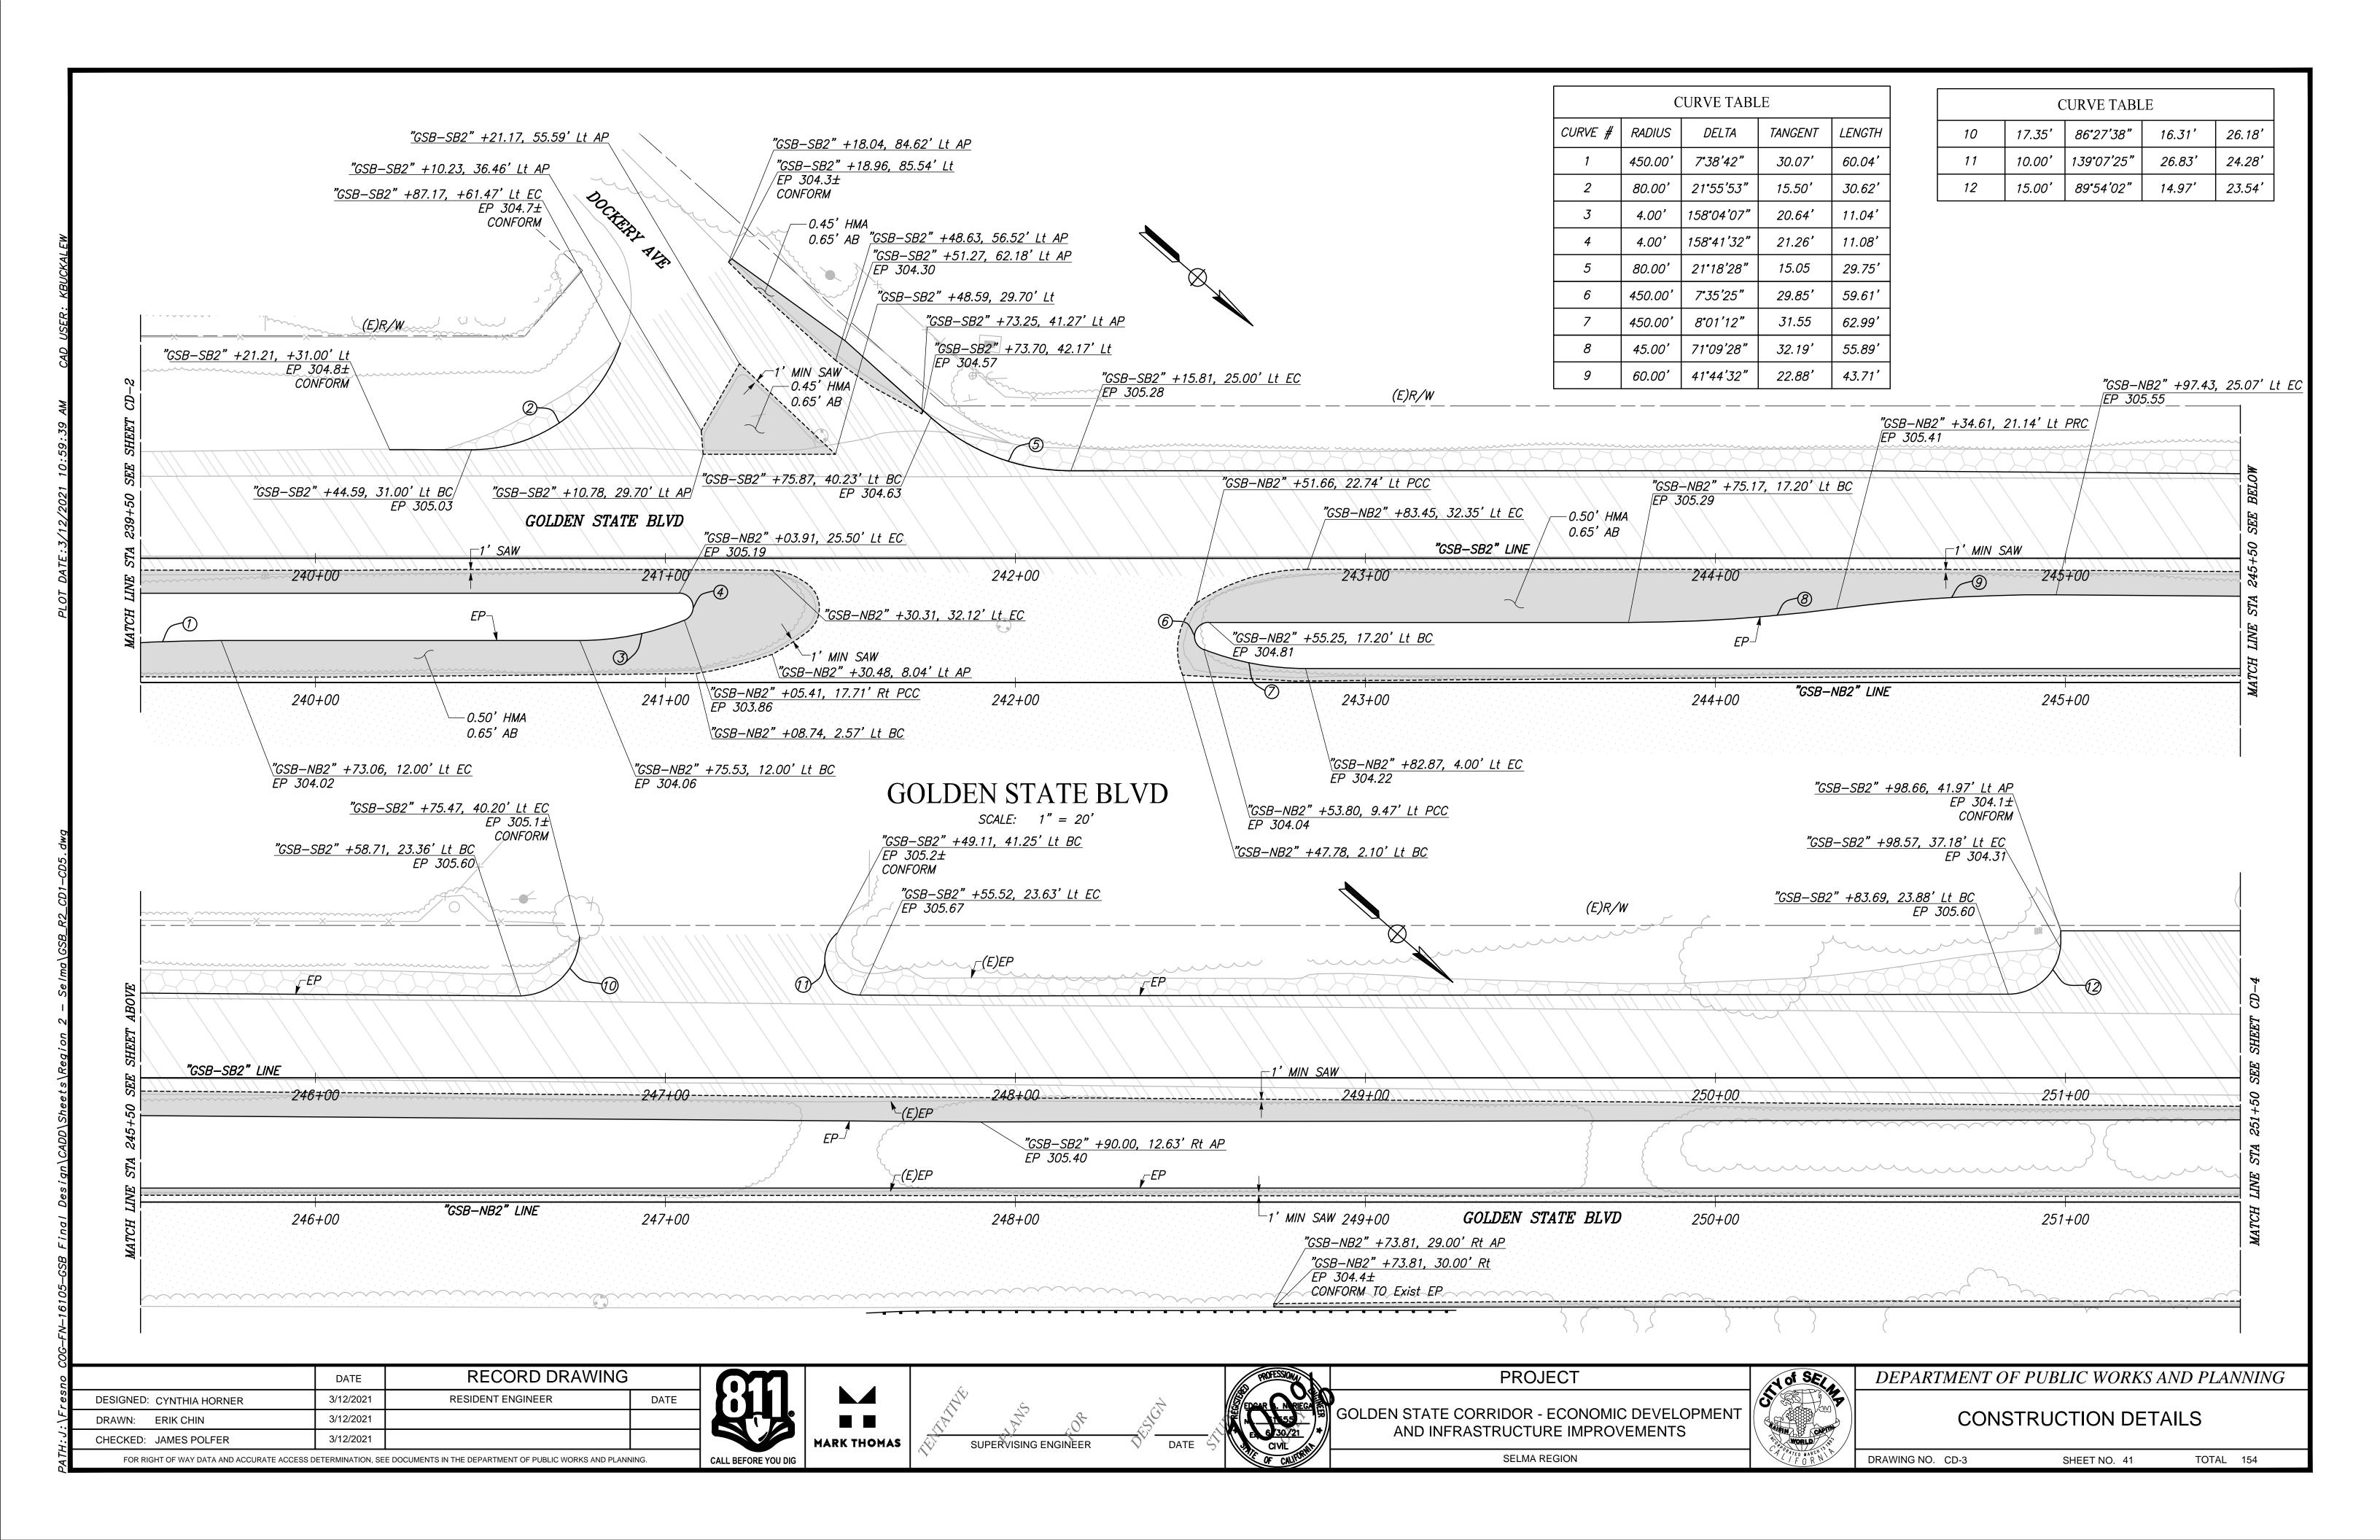

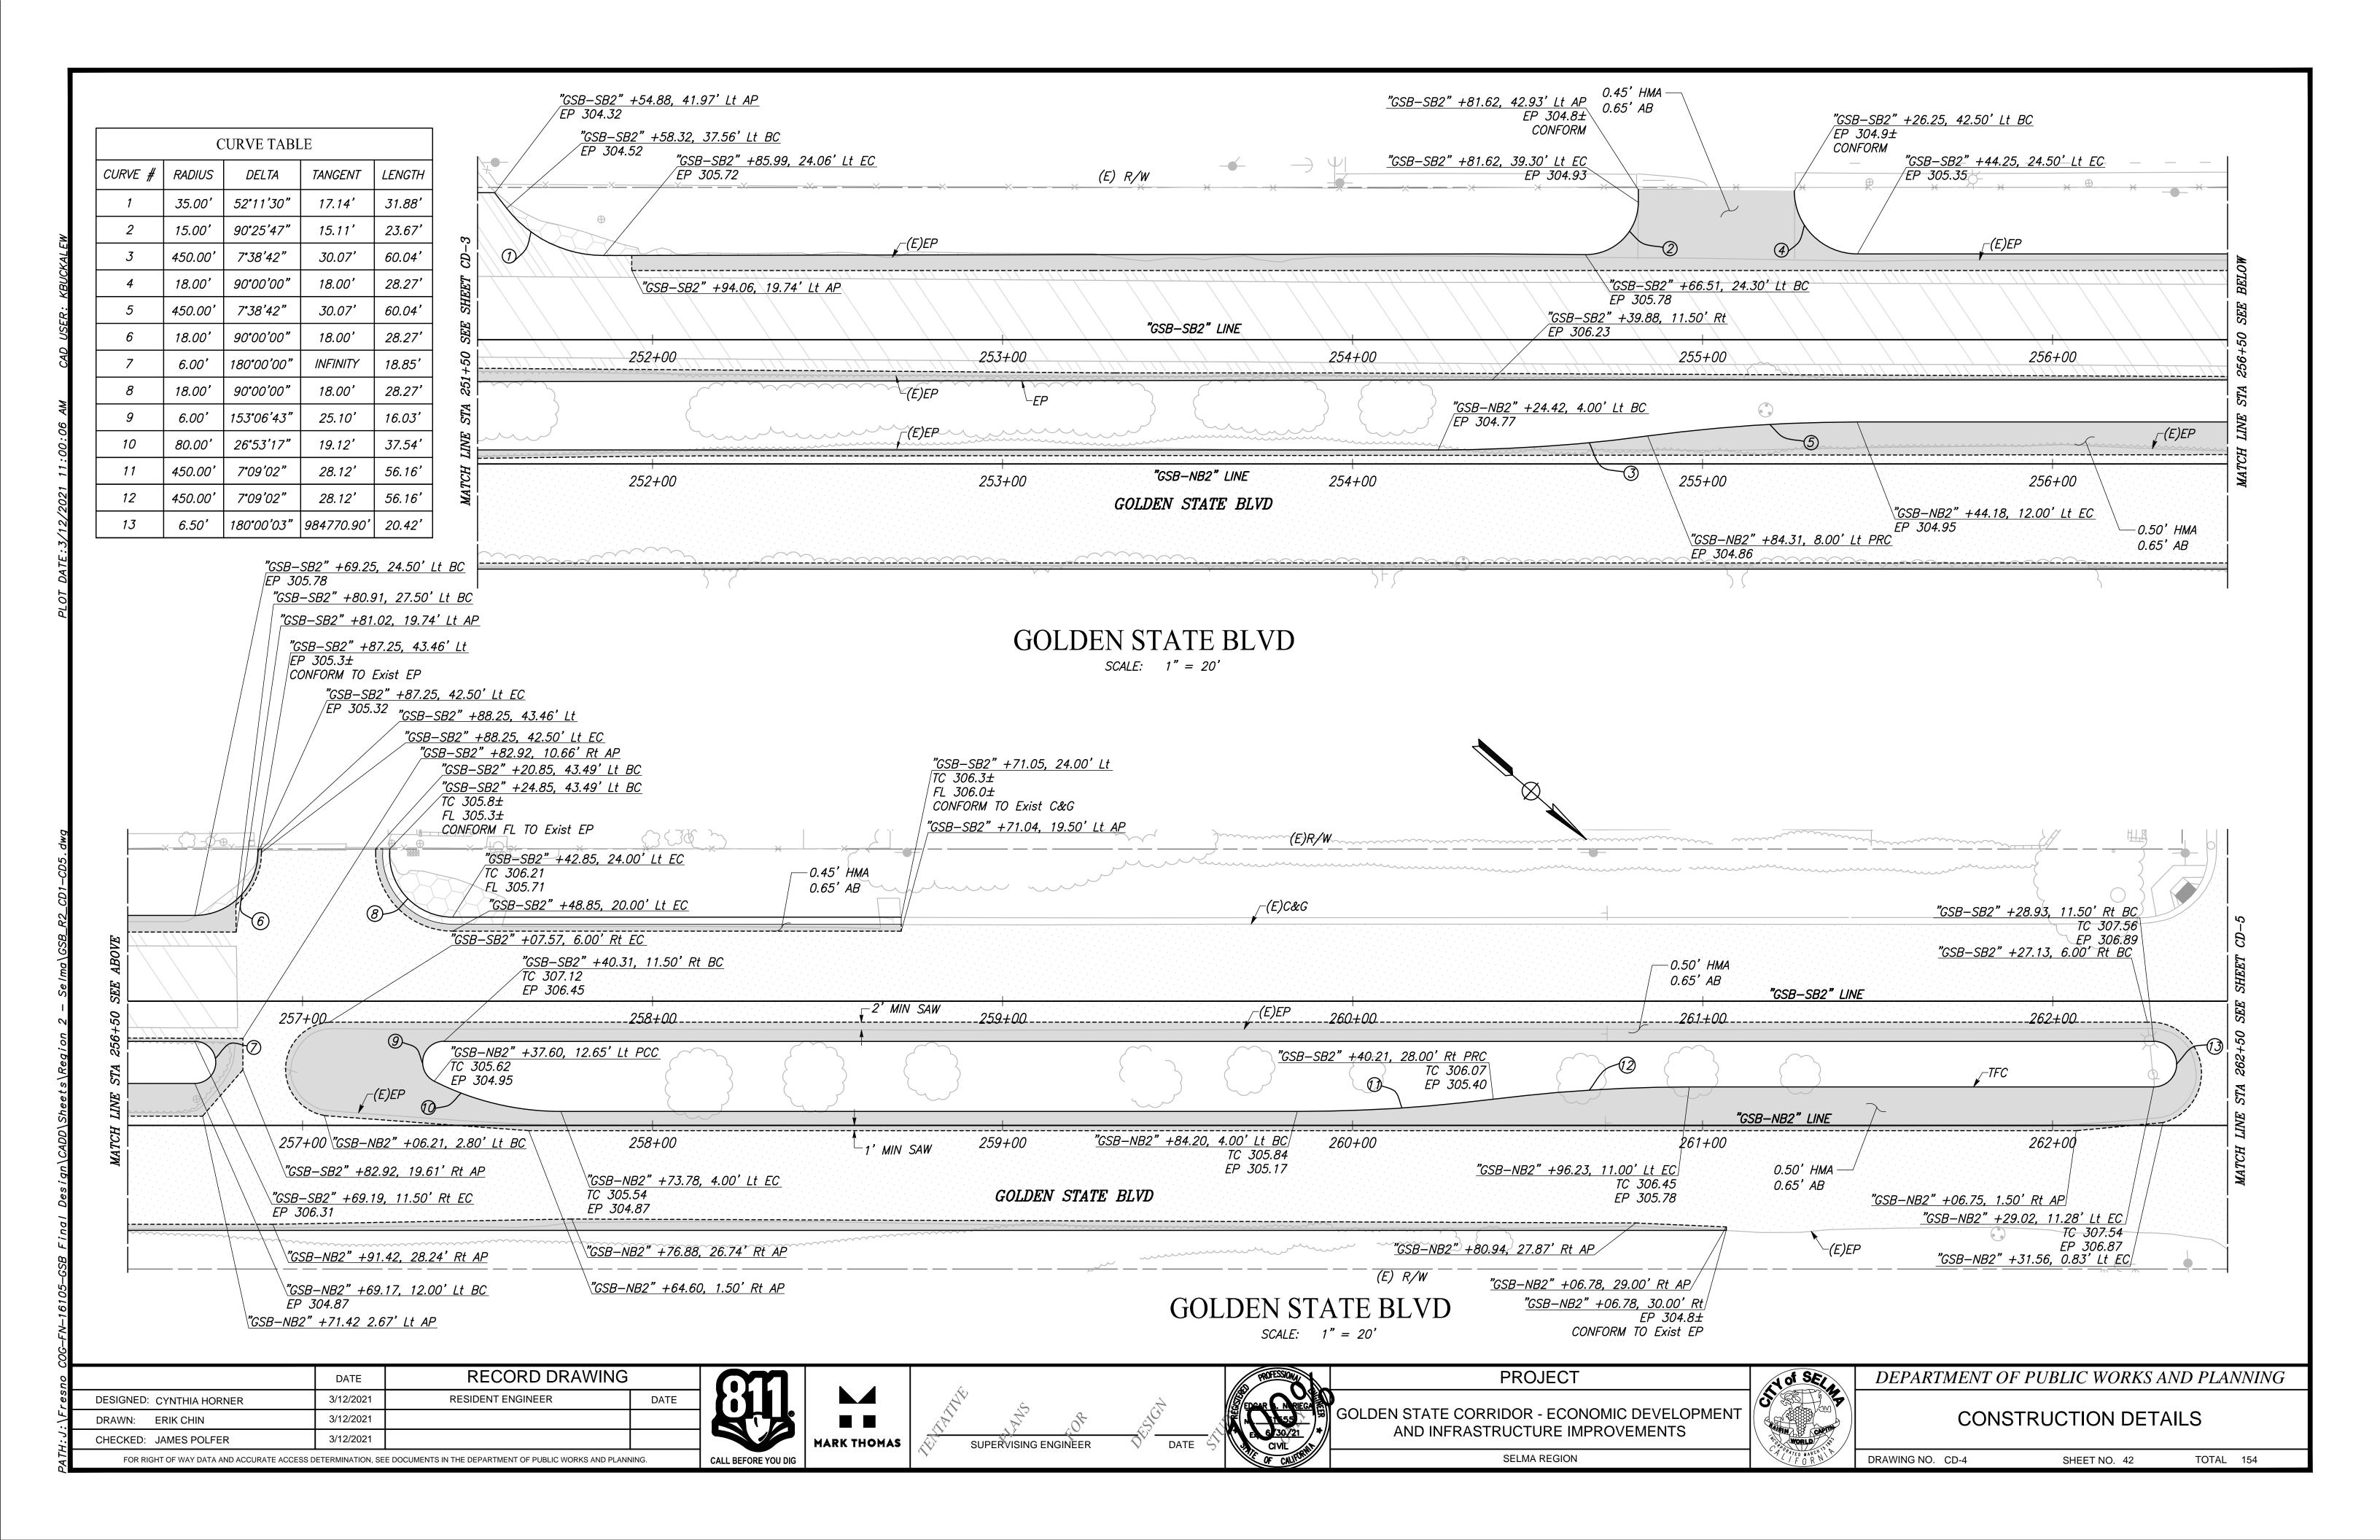


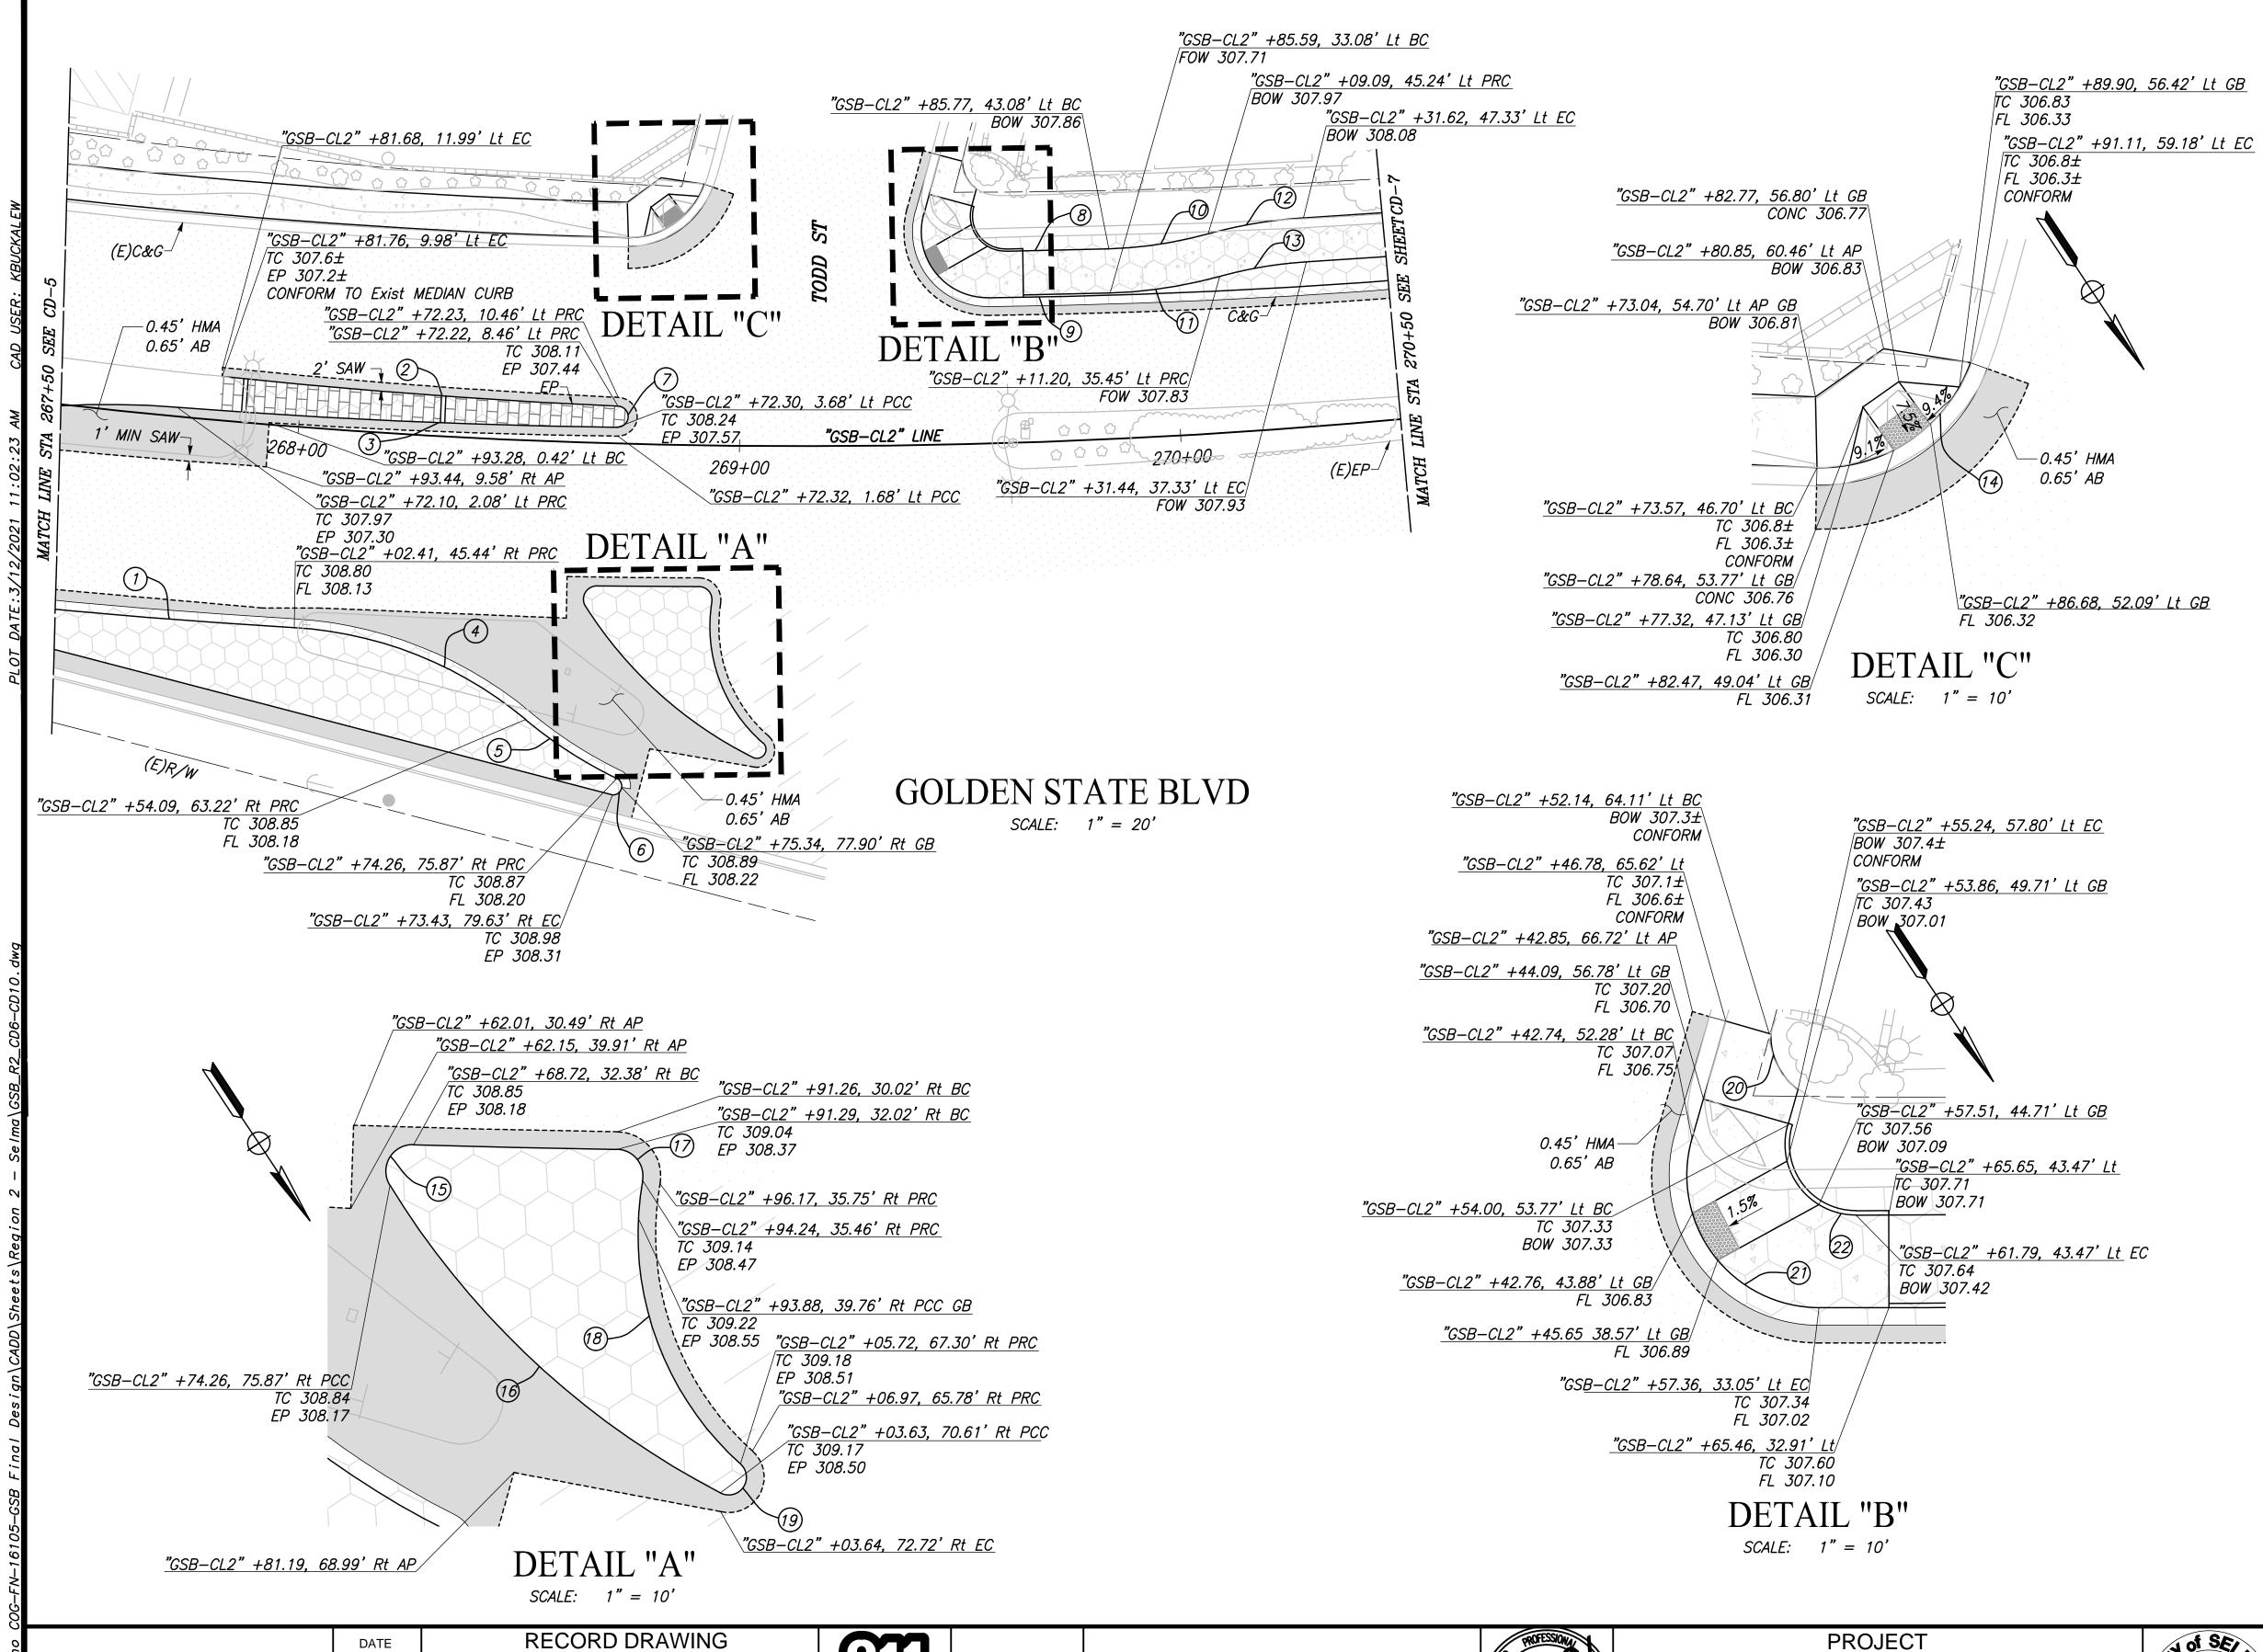


CURVE TABLE						
1	1549.00	<i>3*06'42"</i>	42.07'	84.12'		
2	1487.00'	<i>3°28'01"</i>	45.00'	89.98'		
3	1501.00'	<i>3°49'04"</i>	50.03'	100.02		
4	90.00'	<i>36</i> ° <i>32'</i> 10"	29.71	57.39'		
5	100.00	14°07'50"	12.39'	24.66		
6	1.97'	157*02'50"	9.71	5.40'		
7	2.39'	180°00'00"	INFINITY'	7.51		
8	1450.50	0*55'11"	11.64	23.28'		
9	1461.00'	10°04'32"	128.79	256.92'		
10	95.00'	13°44'47"	11.45'	22.79'		
11	105.00'	13°44'47"	12.66'	25.19		
12	105.00'	11°59'23"	11.03	21.97'		
13	95.00'	11*59'23"	9.98'	19.88		
14	18.00'	71°28′31″	12.95'	22.45		
15	3.00'	123*08'16"	5.54'	6.45		
16	95.00'	31°14'13"	26.56'	51.79'		
17	3.00'	99*08'43"	3.52'	5.19'		
18	35.00'	58°04'44"	19.43'	35.48'		
19	2.00'	165°25'06"	15.63'	5.77'		
20	7.47'	<i>55°42'45"</i>	3.95'	5.77'		
21	15.00'	105°42'55"	19.80'	27.68'		
22	8.00'	105 ° 52'42"	10.59	14.78'		
	•			•		

	DATE	RECORD DRAWING	
DESIGNED:	3/12/2021	RESIDENT ENGINEER	DATE
DRAWN:	3/12/2021		
CHECKED:	3/12/2021		
FOR RIGHT OF WAY DATA AND ACCURATE ACCESS DETERMINATION, SEE DOCUMENTS IN THE DEPARTMENT OF PUBLIC WORKS AND PLANNING.			



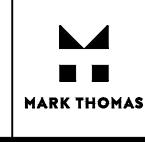

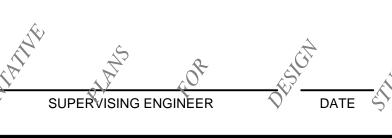



GOLDEN STATE CORRIDOR - ECONOMIC DEVELOPMENT AND INFRASTRUCTURE IMPROVEMENTS


SELMA REGION





DEPARTMENT OF PUBLIC WORKS AND PLANNING

CONSTRUCTION DETAILS

DRAWING NO. *CD-6* SHEET NO. *44* TOTAL 154

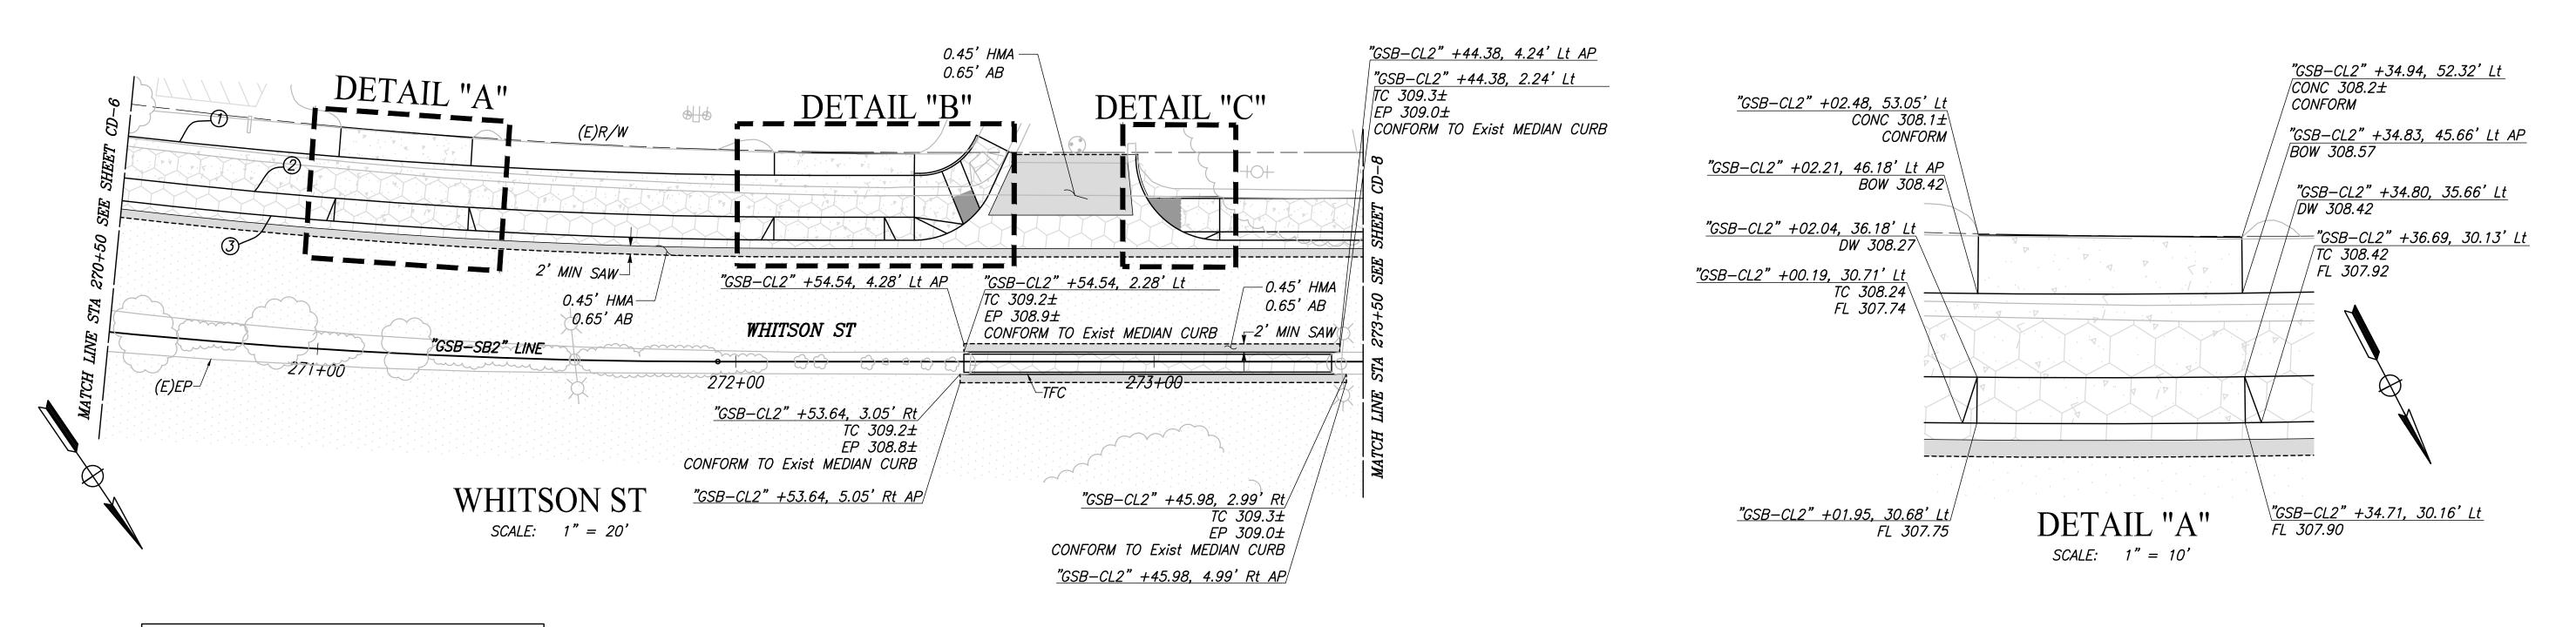

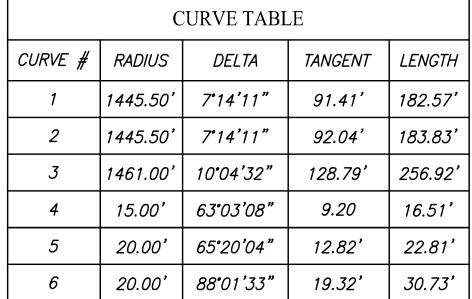


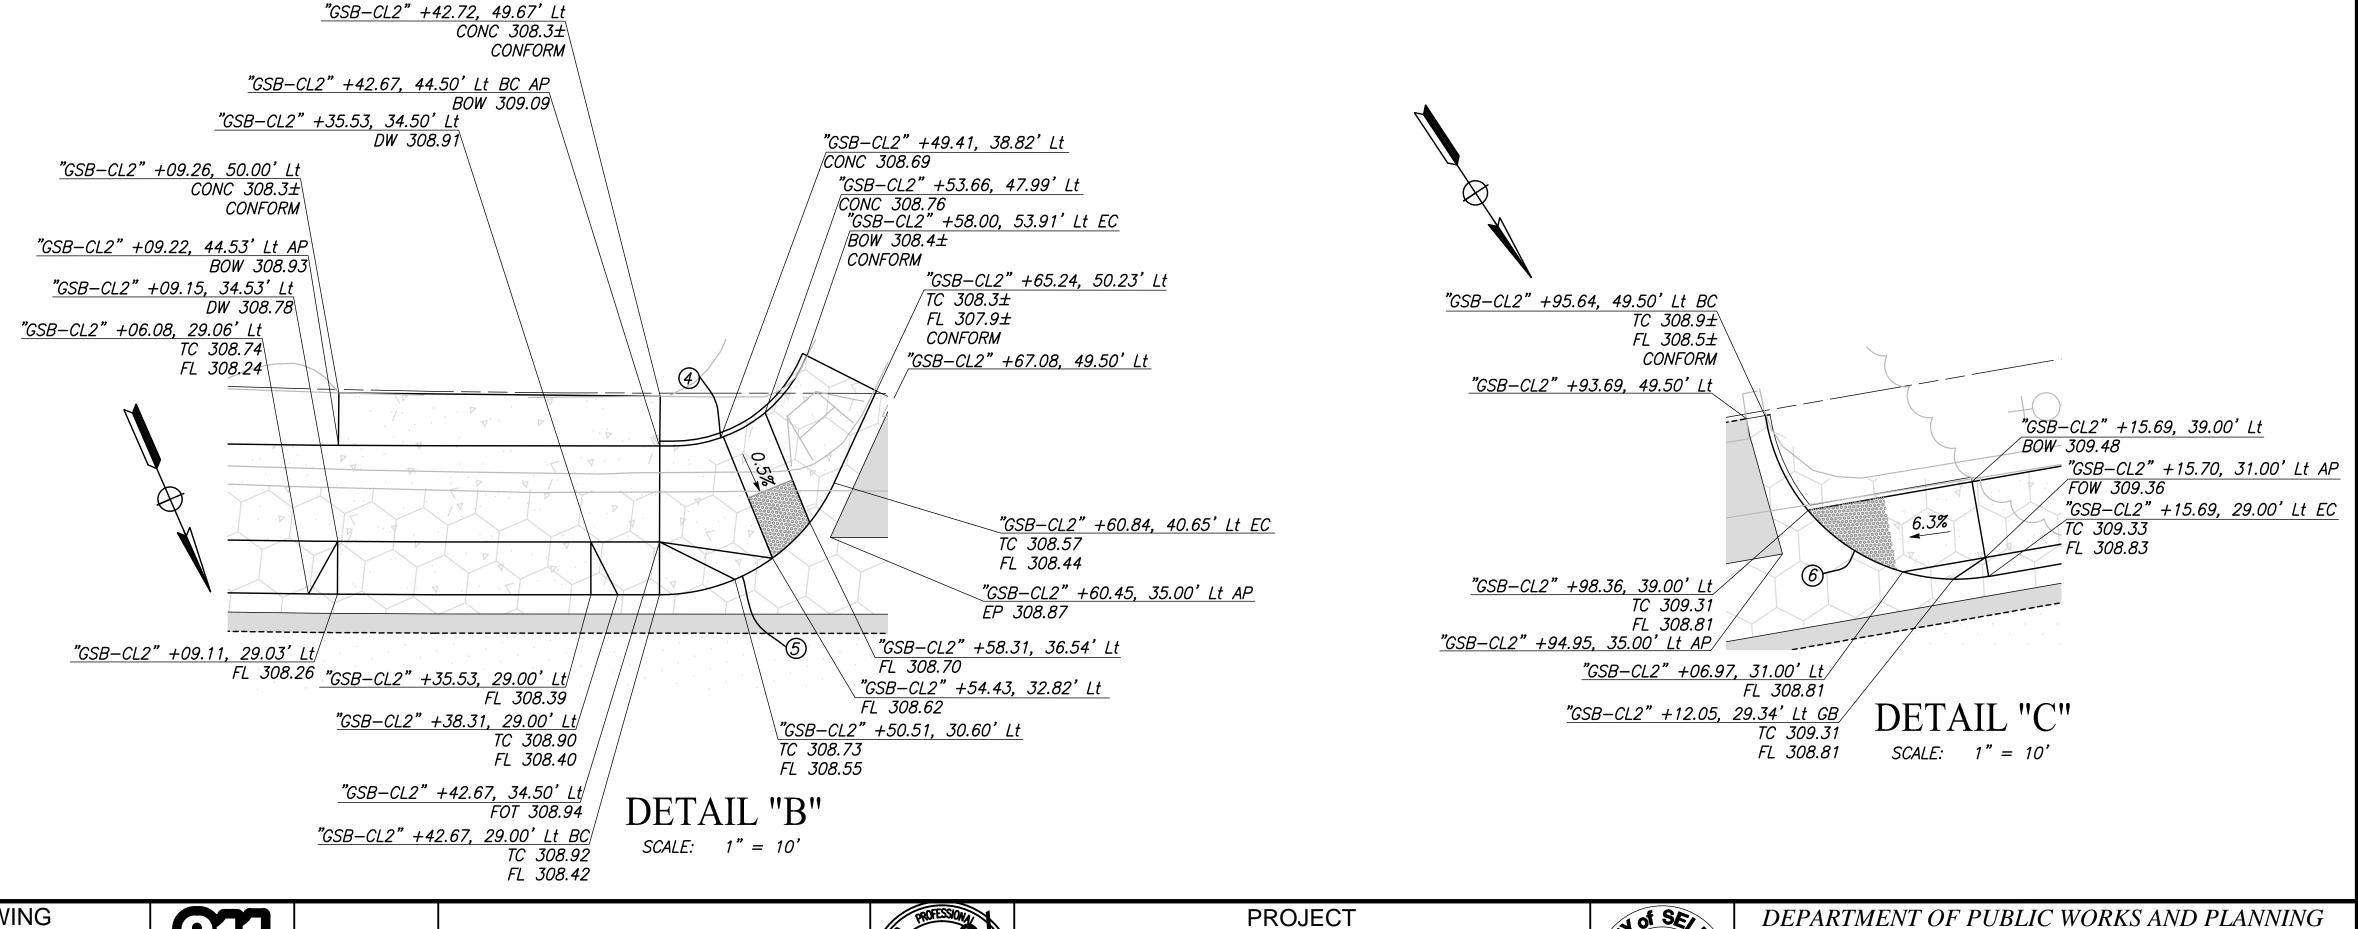


	DATE	RECORD DRAWING	
DESIGNED:	3/12/2021	RESIDENT ENGINEER	DATE
DRAWN:	3/12/2021		
CHECKED:	3/12/2021		
FOR RIGHT OF WAY DATA AND ACCURATE ACCESS DETERMINATION, SEE DOCUMENTS IN THE DEPARTMENT OF PUBLIC WORKS AND PLANNING.			




MARK THOMAS

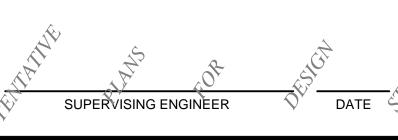

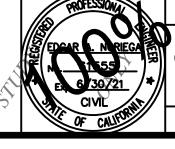


GOLDEN STATE CORRIDOR - ECONOMIC DEVELOPMENT AND INFRASTRUCTURE IMPROVEMENTS **SELMA REGION**

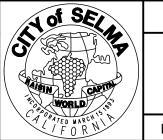



DEPARTMENT OF PUBLIC WORKS AND PLANNING

CONSTRUCTION DETAILS

DRAWING NO. CD-7 SHEET NO. 45 TOTAL 154

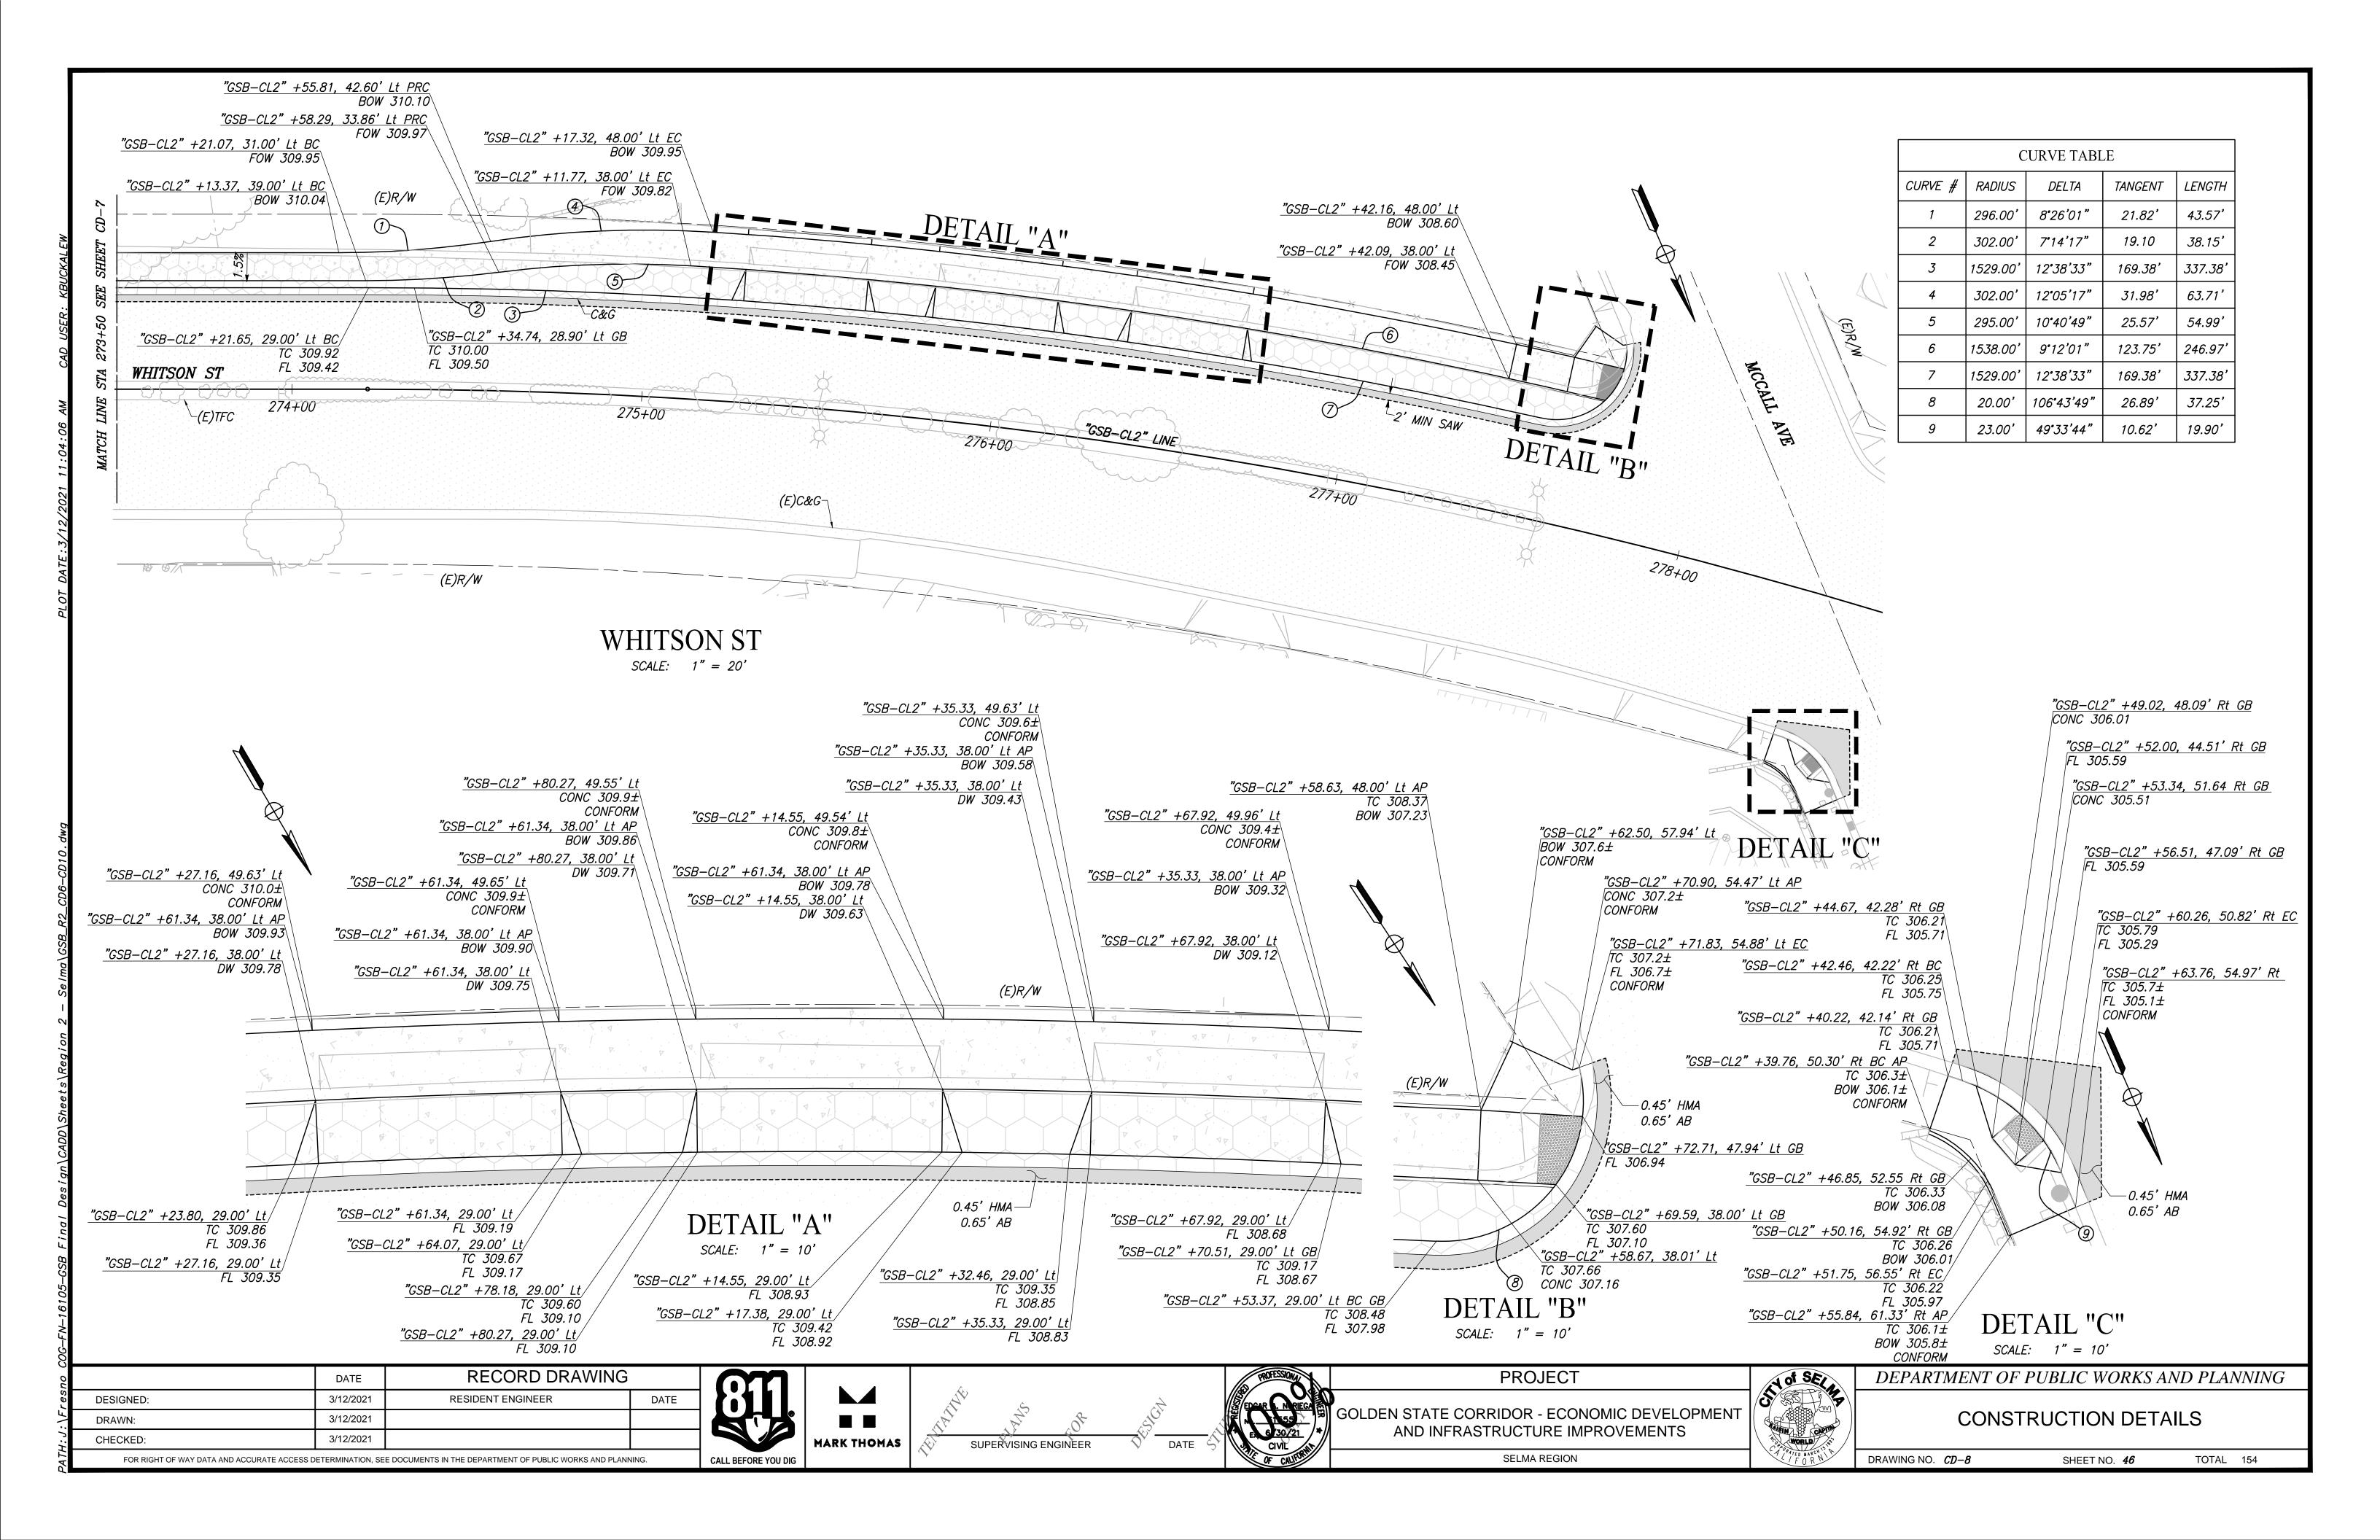


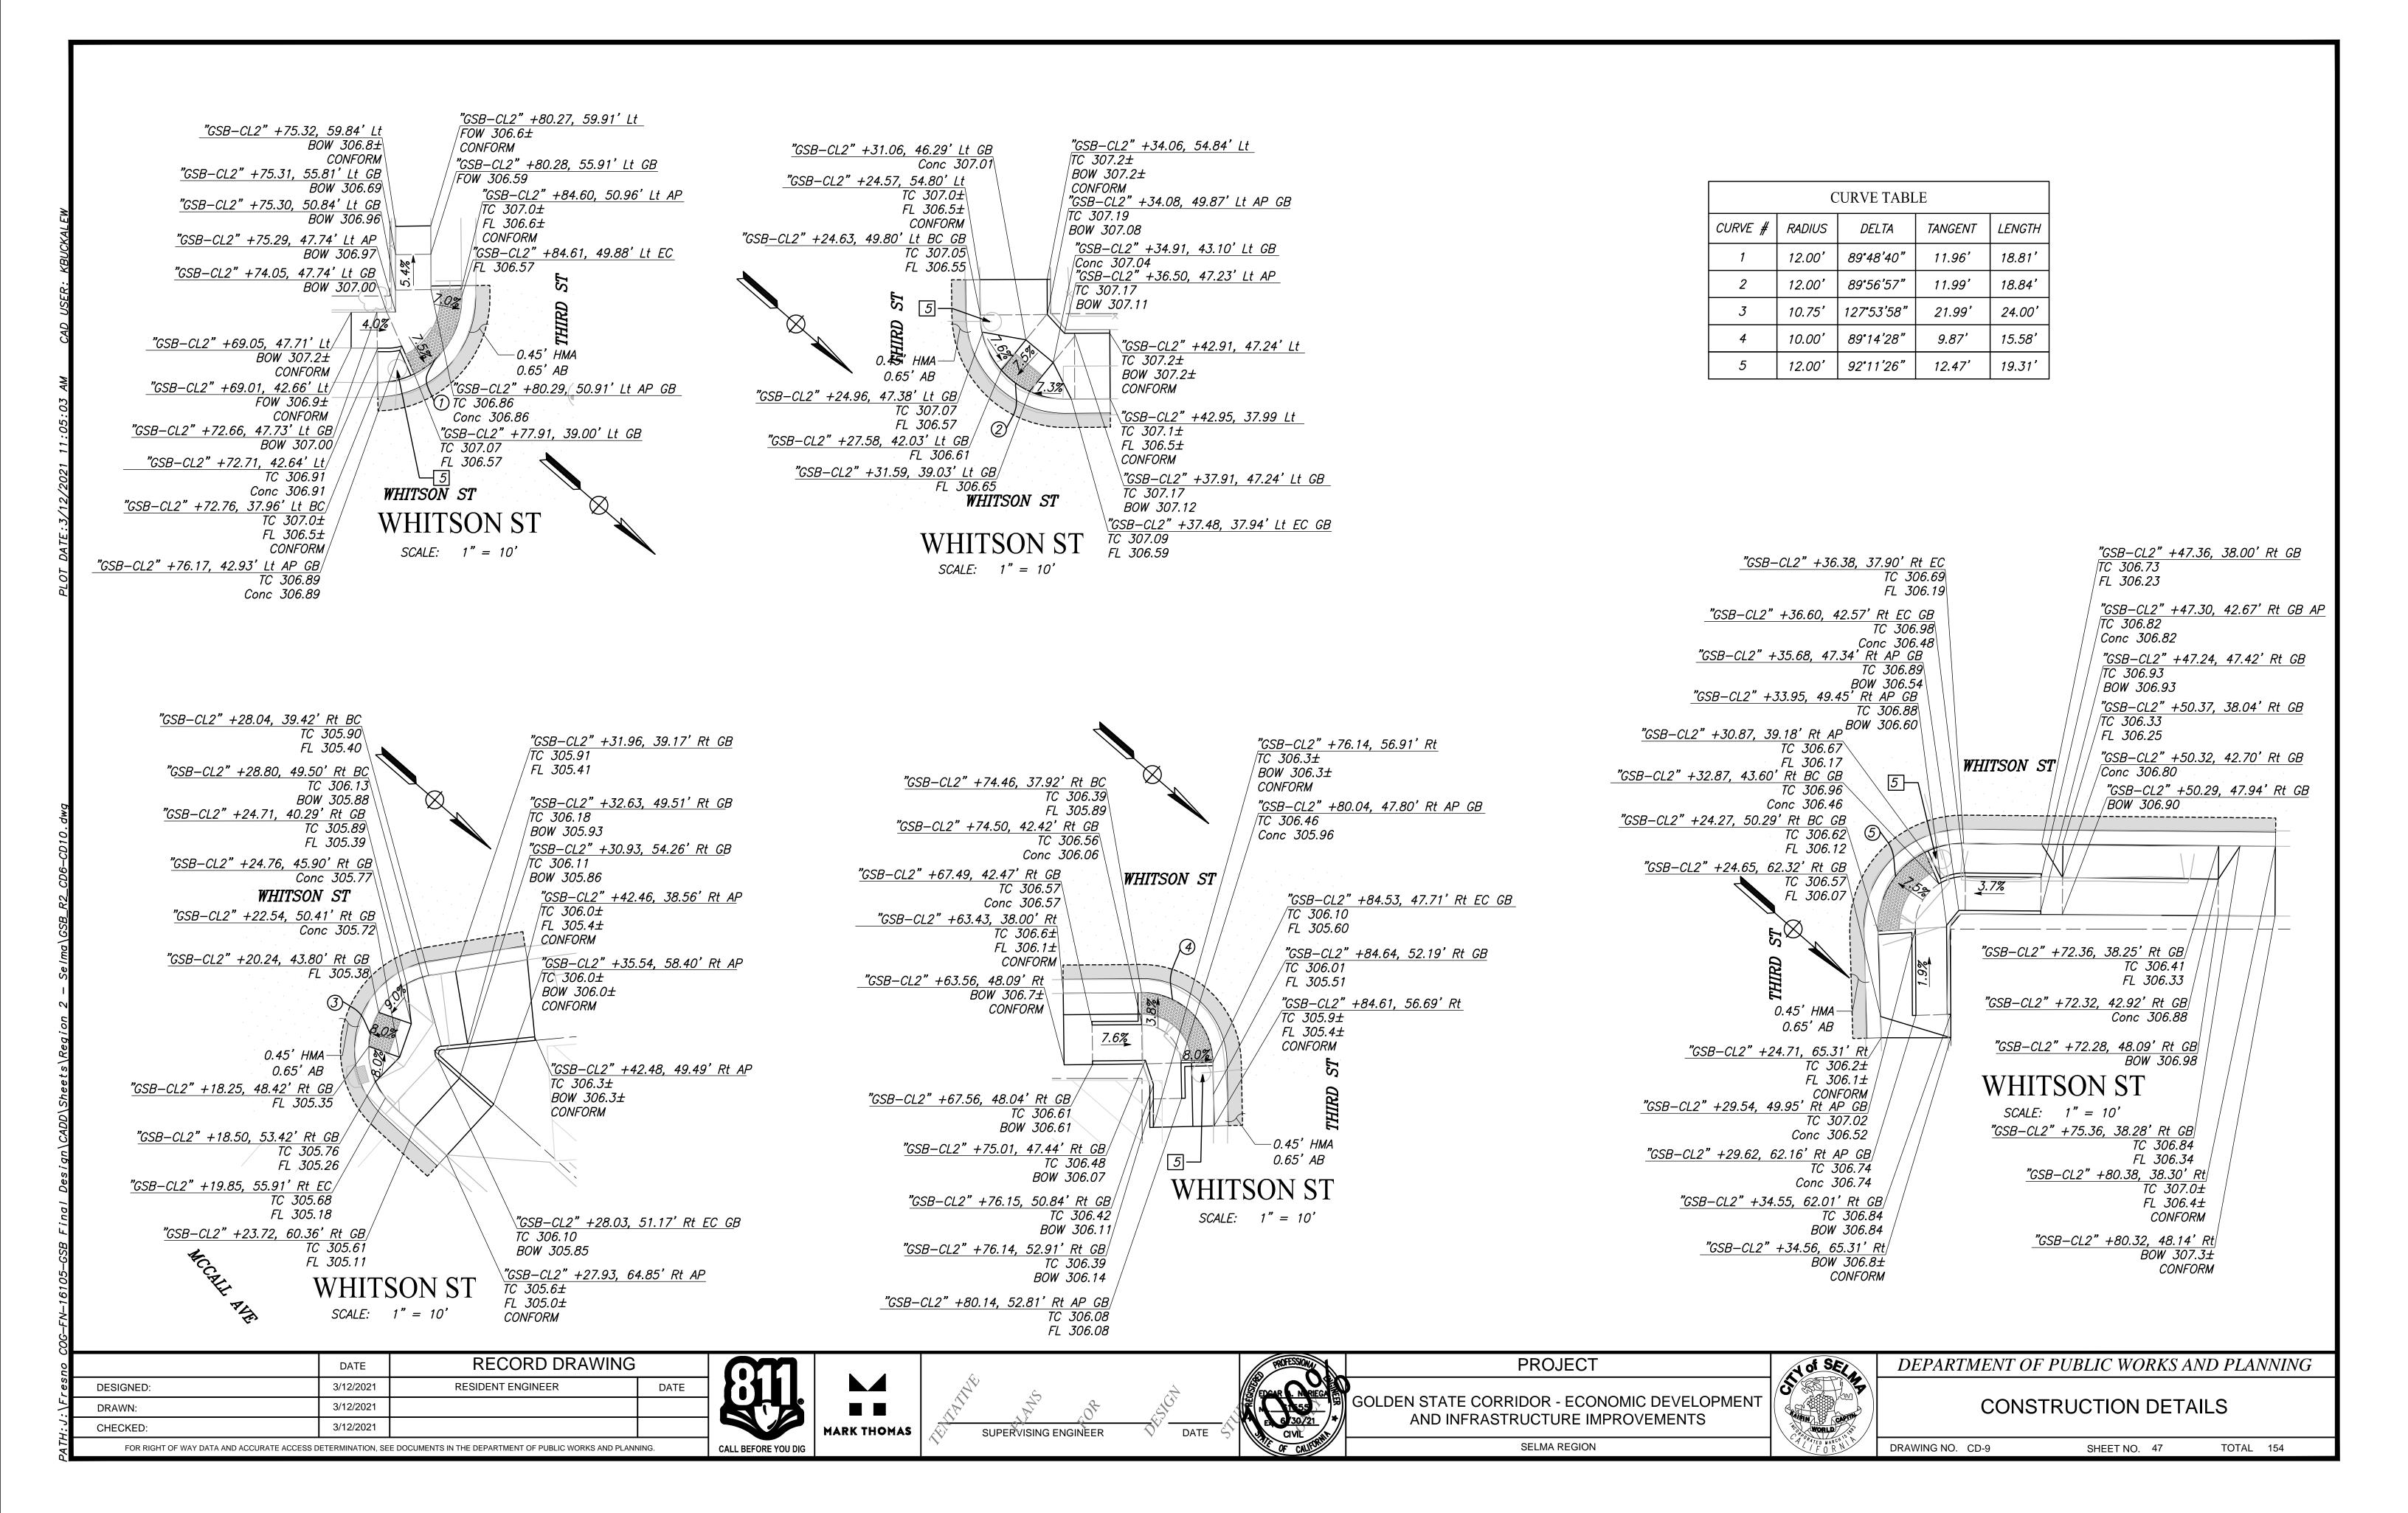


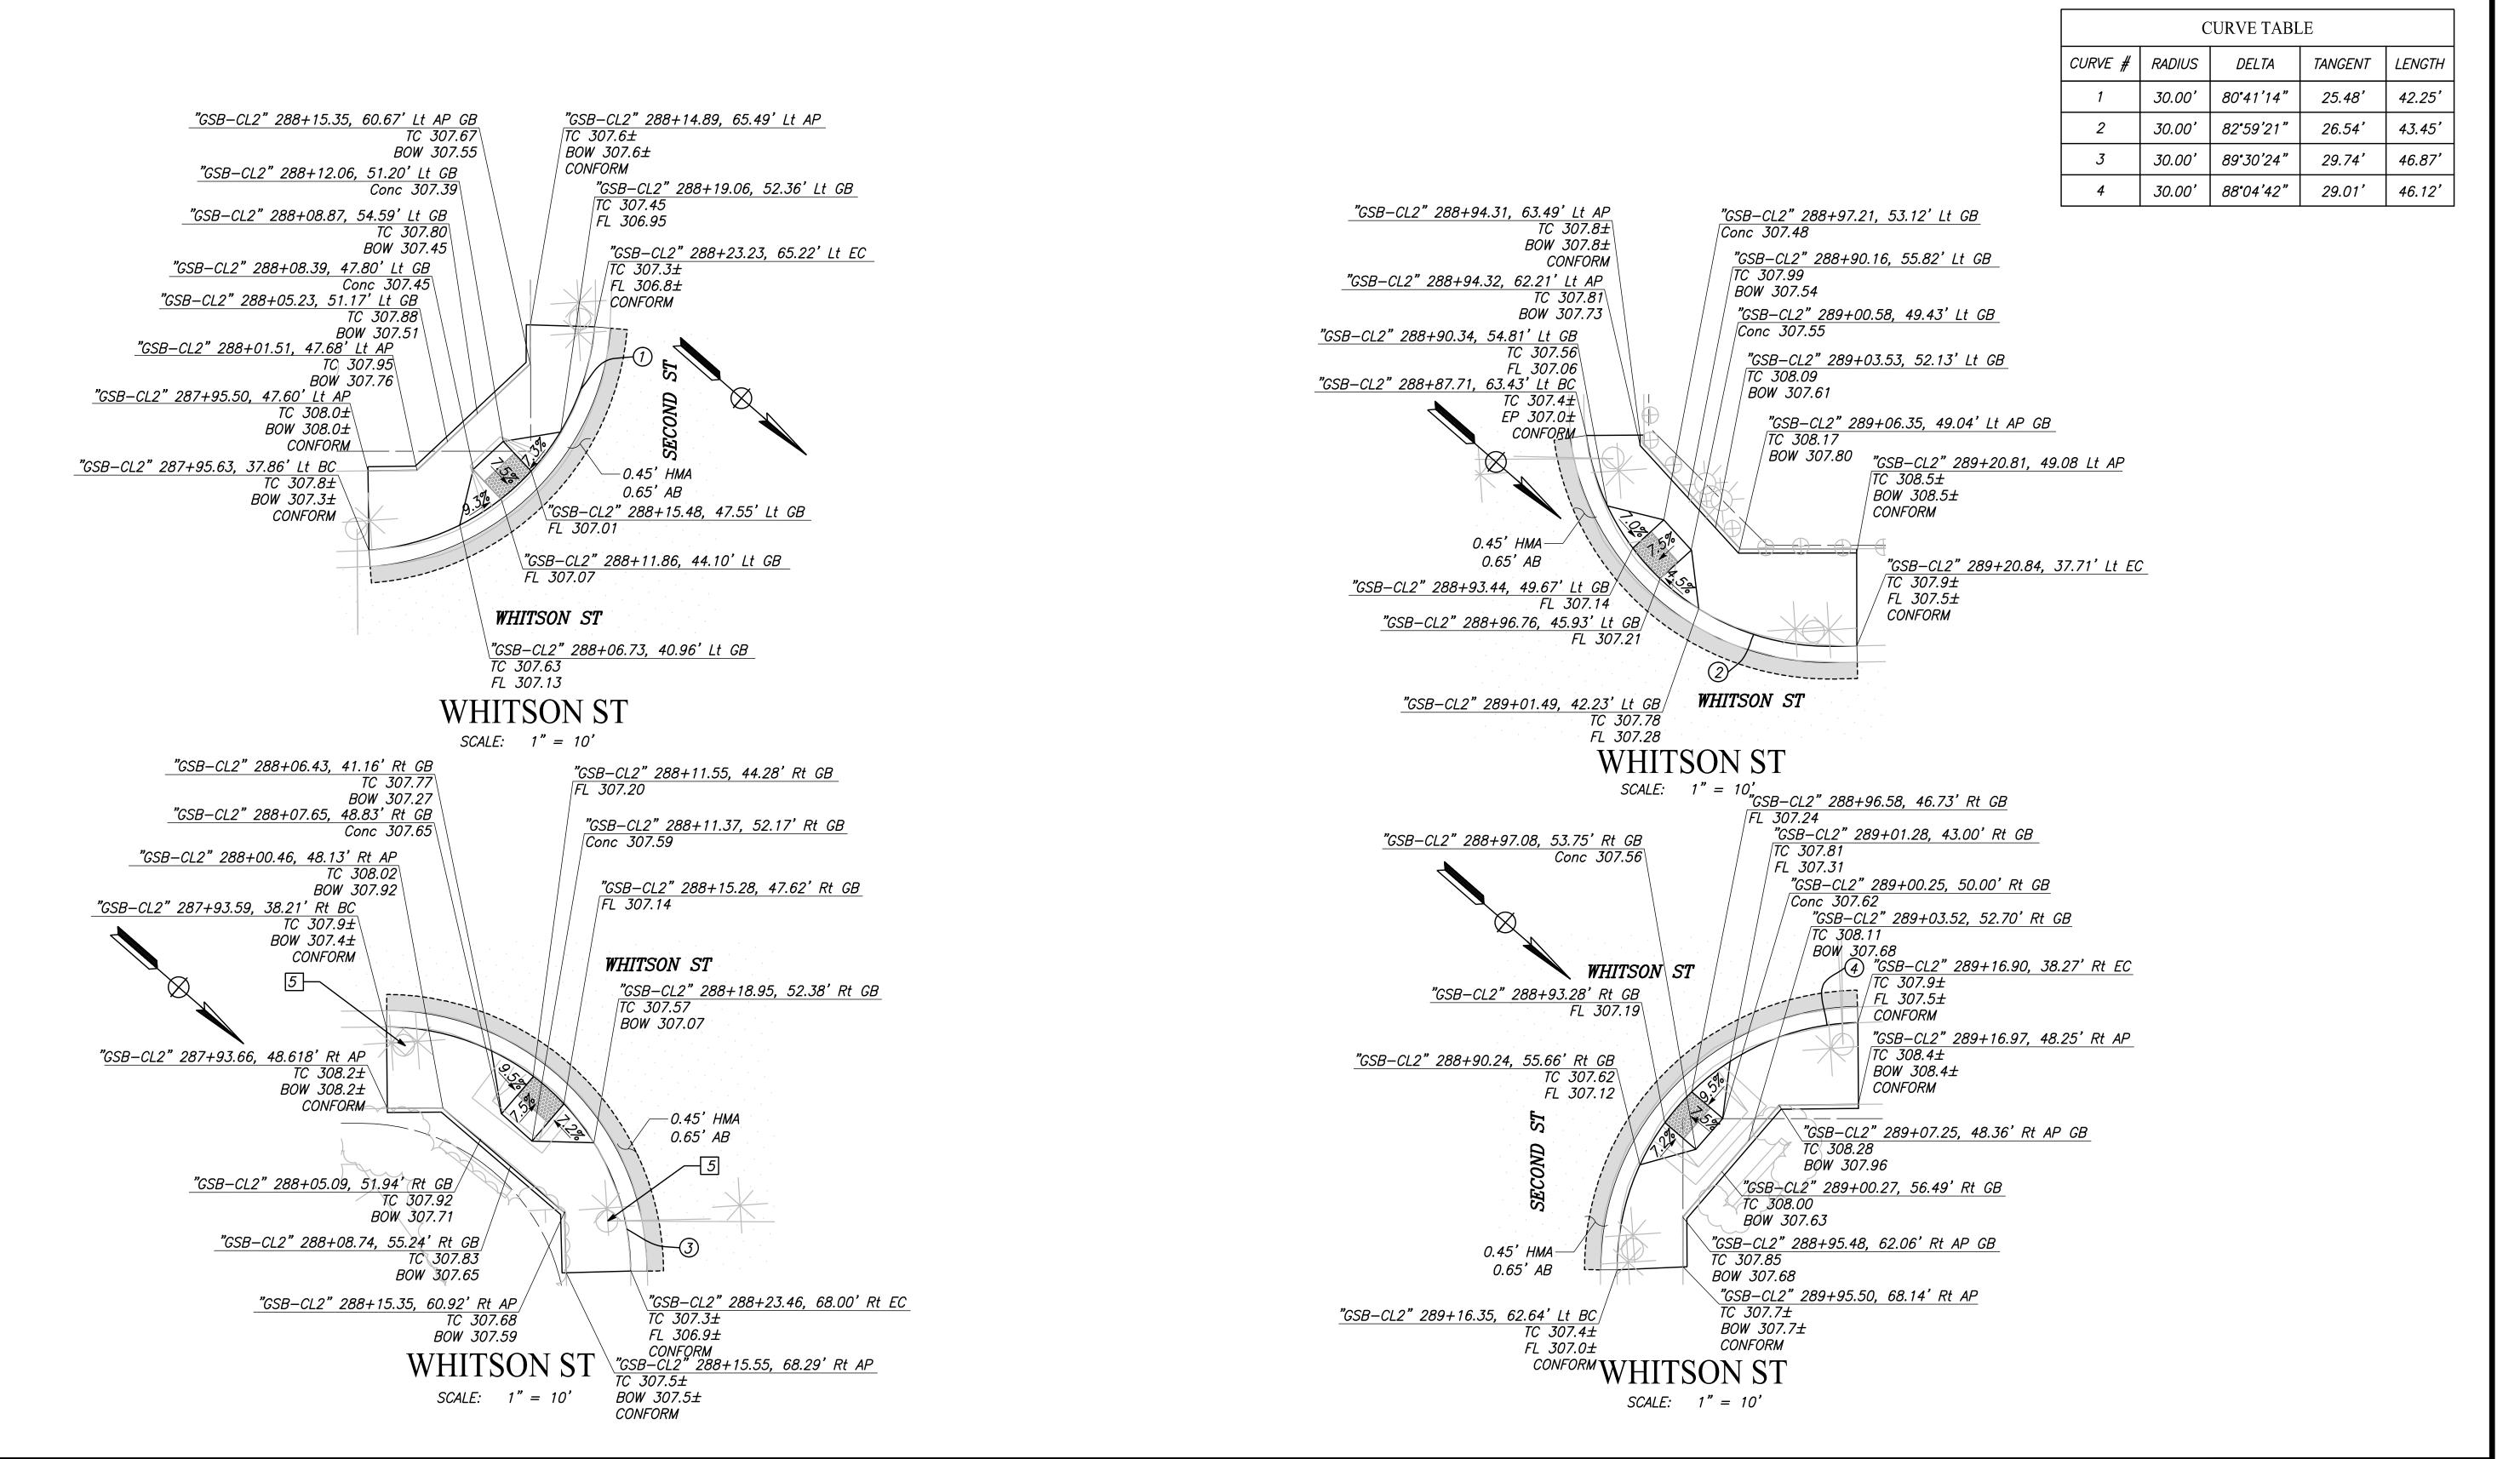

	DATE	RECORD DRAWING		
DESIGNED:	3/12/2021	RESIDENT ENGINEER	DATE	
DRAWN:	3/12/2021			l
CHECKED:	3/12/2021			•
FOR RIGHT OF WAY DATA AND ACCURATE ACCESS DETERMINATION, SEE DOCUMENTS IN THE DEPARTMENT OF PUBLIC WORKS AND PLANNING.				



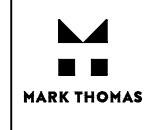

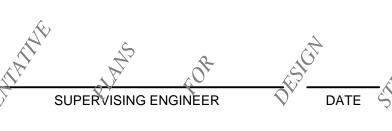






PROJECT


SELMA REGION

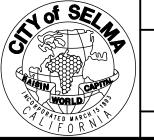



DEPARTMENT OF PUBLIC WORKS AND PLANNING


CONSTRUCTION DETAILS


DRAWING NO. CD-10 SHEET NO. 48 TOTAL 154

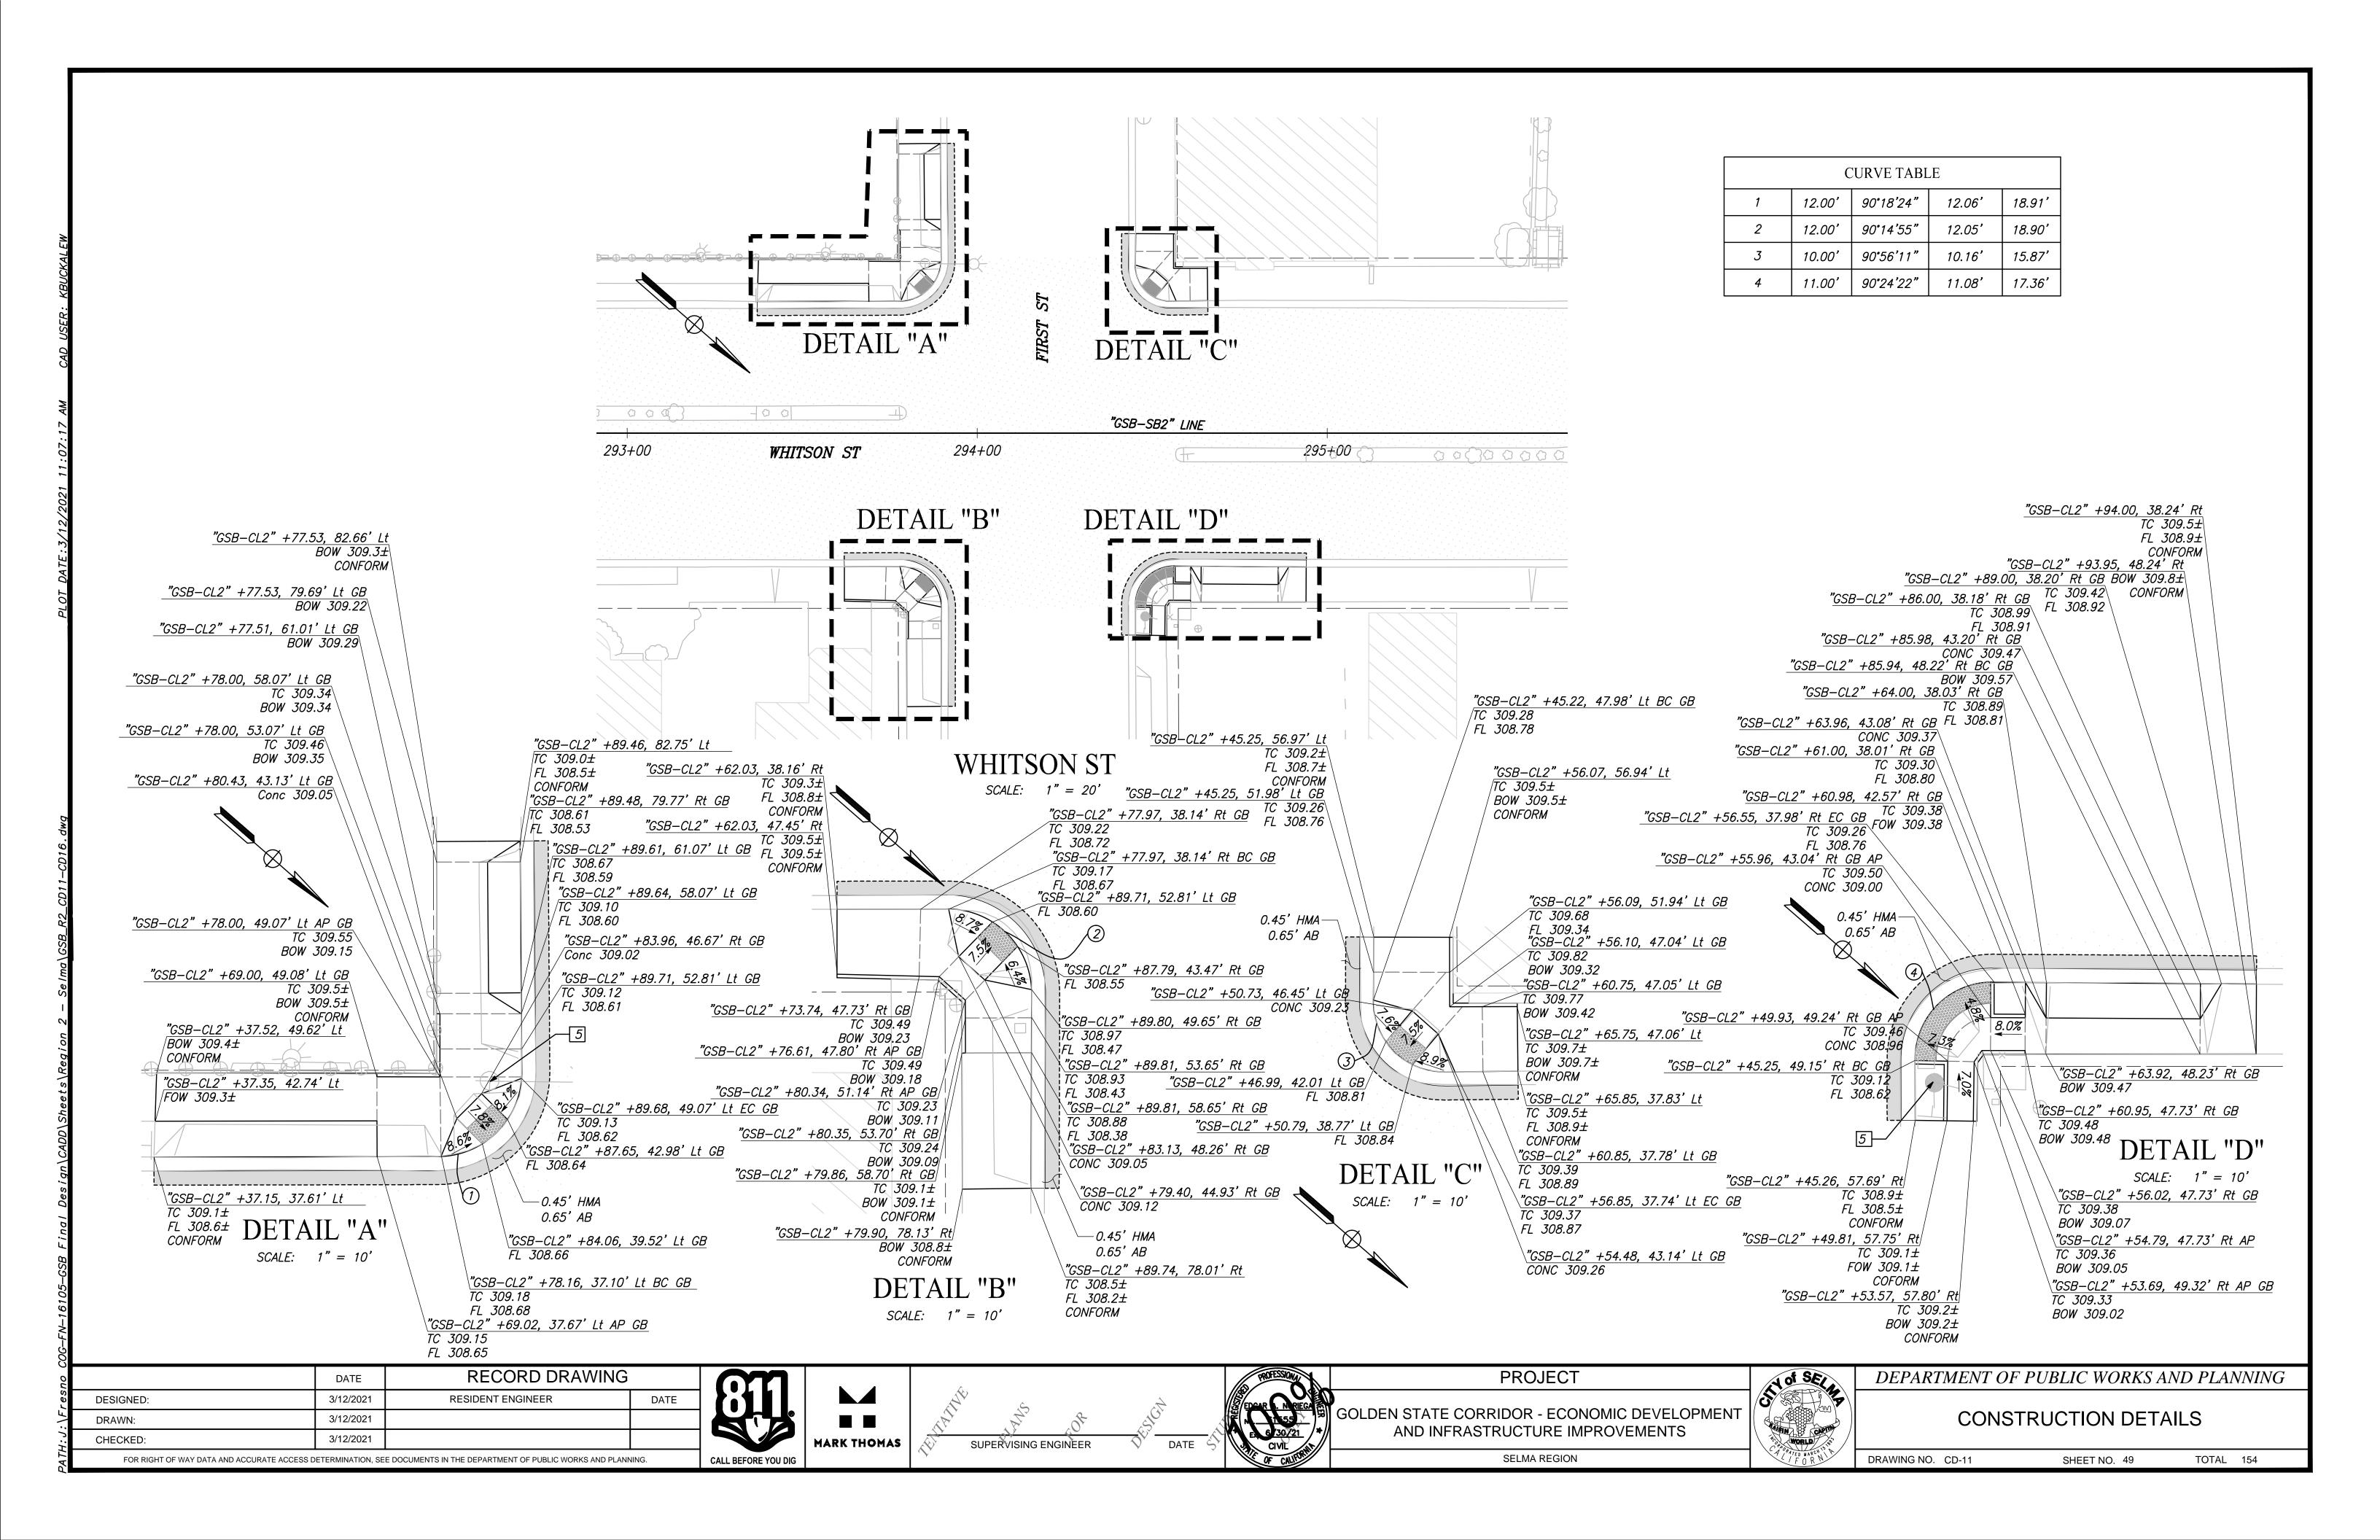

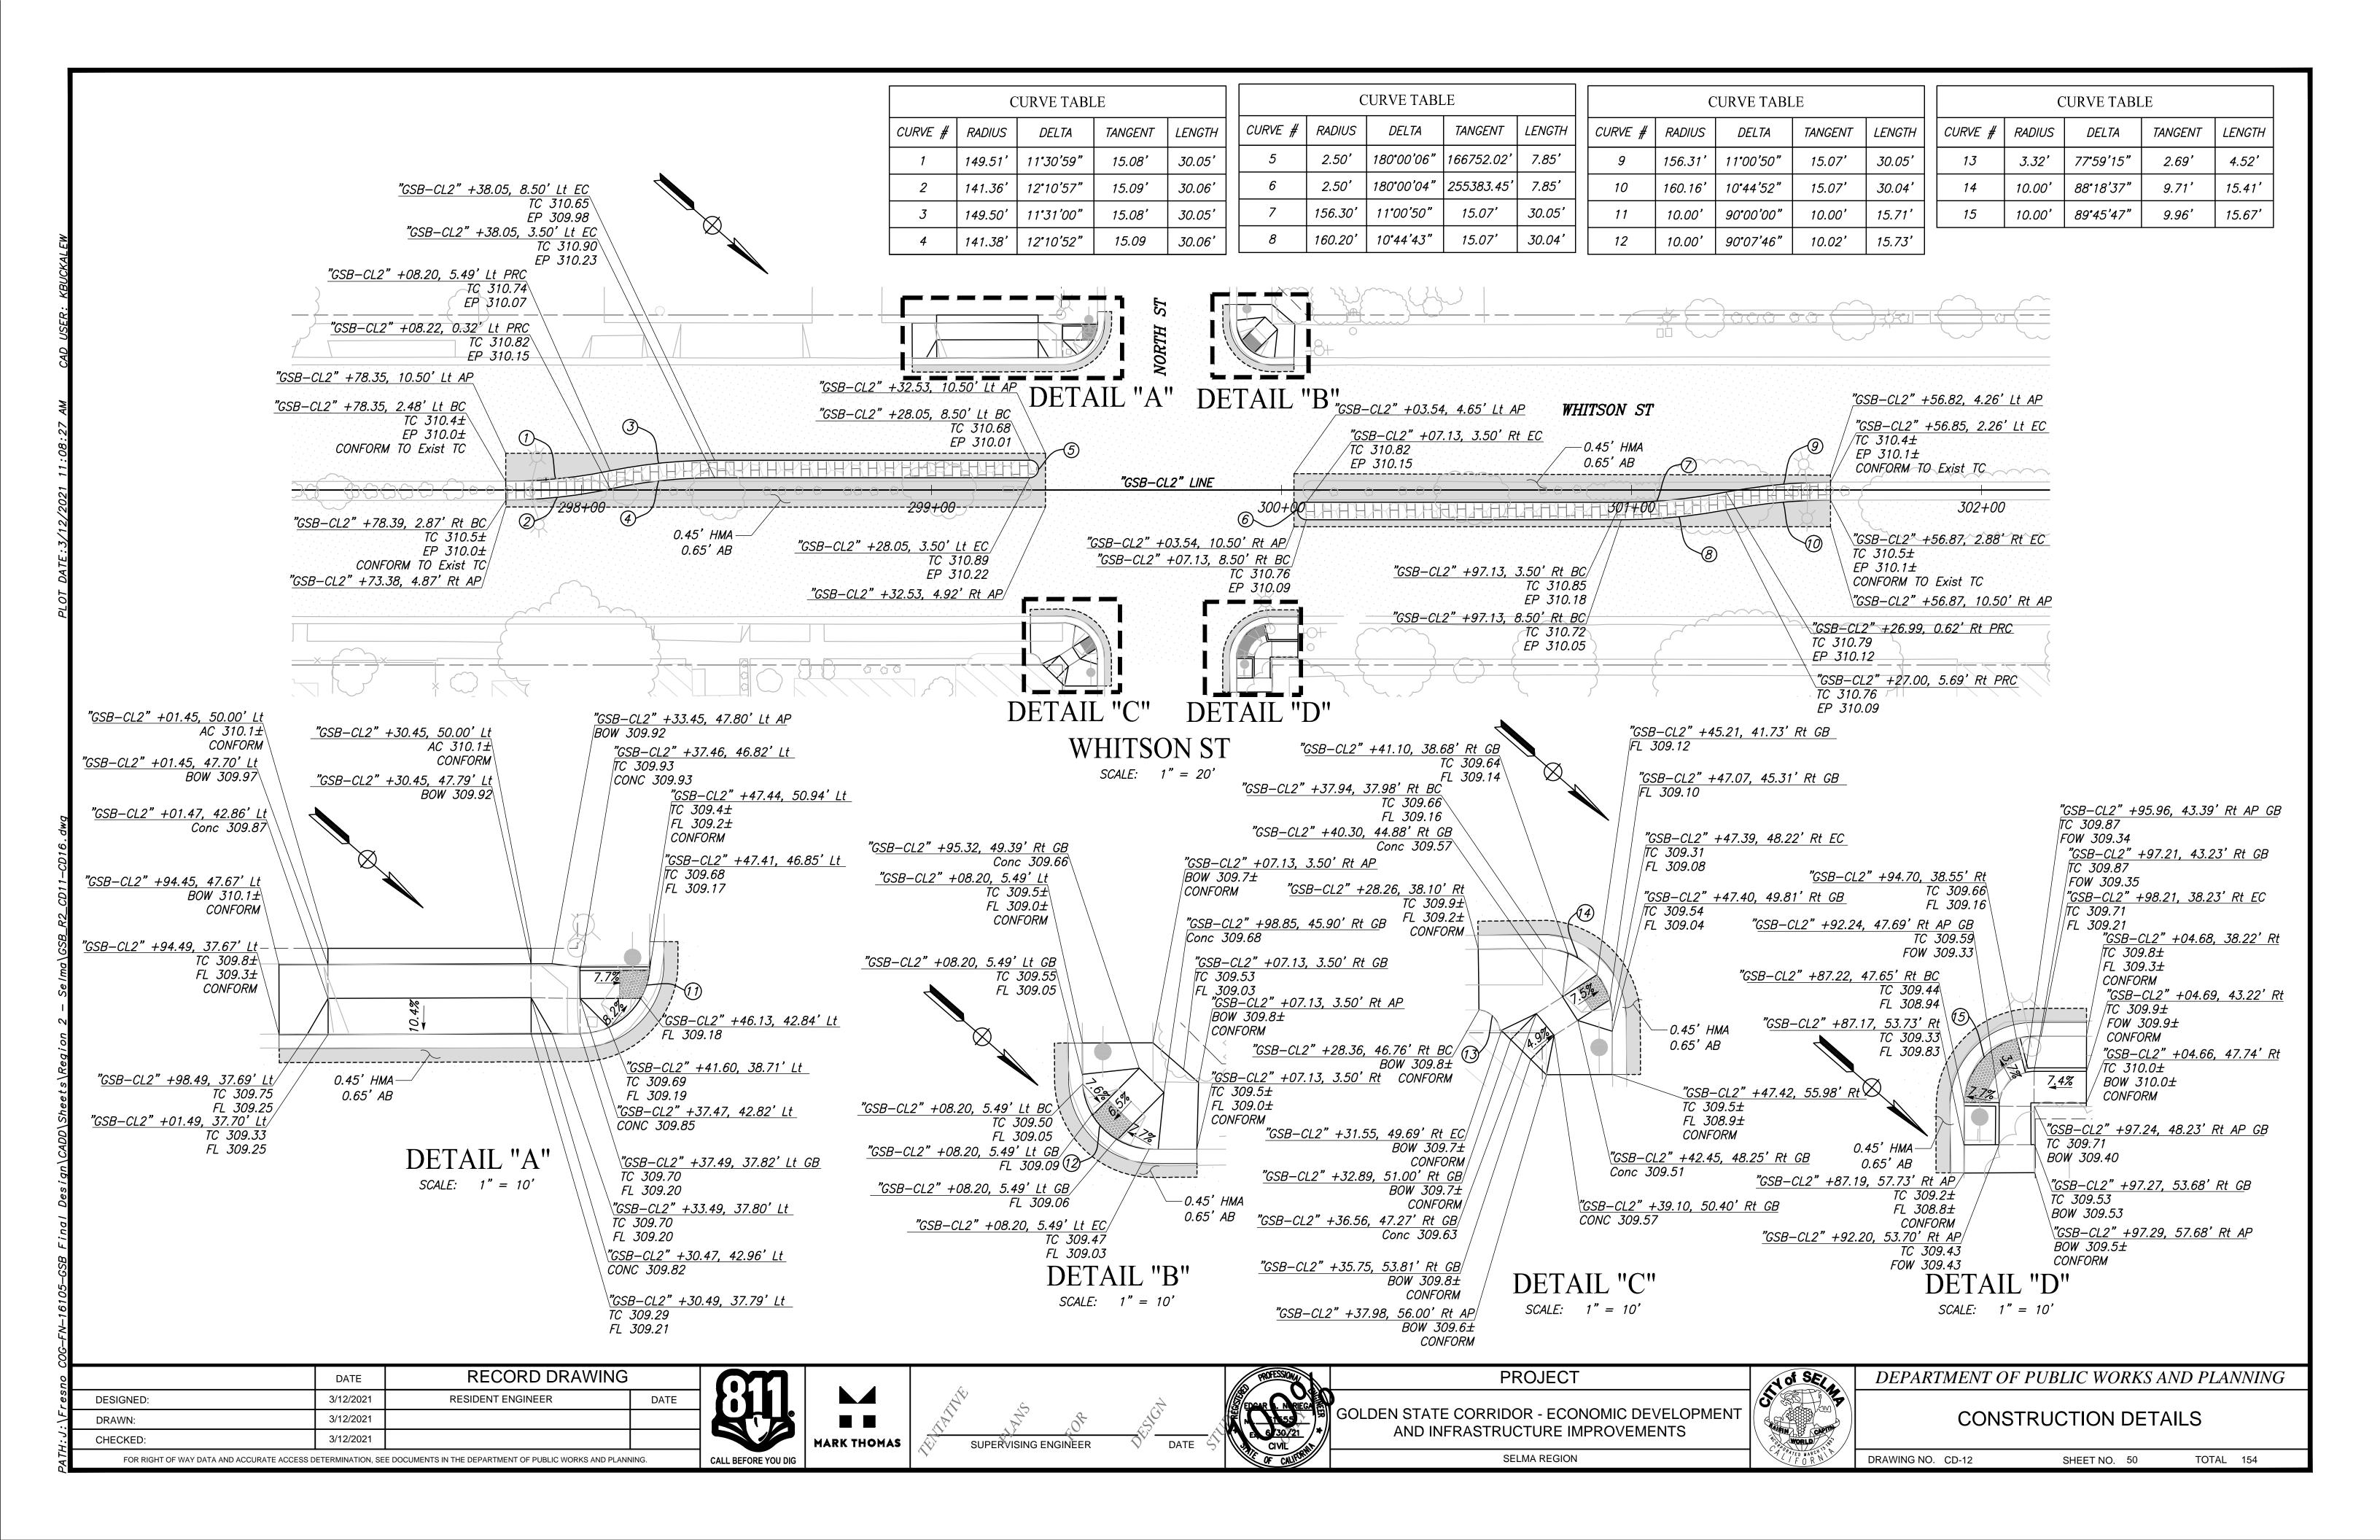

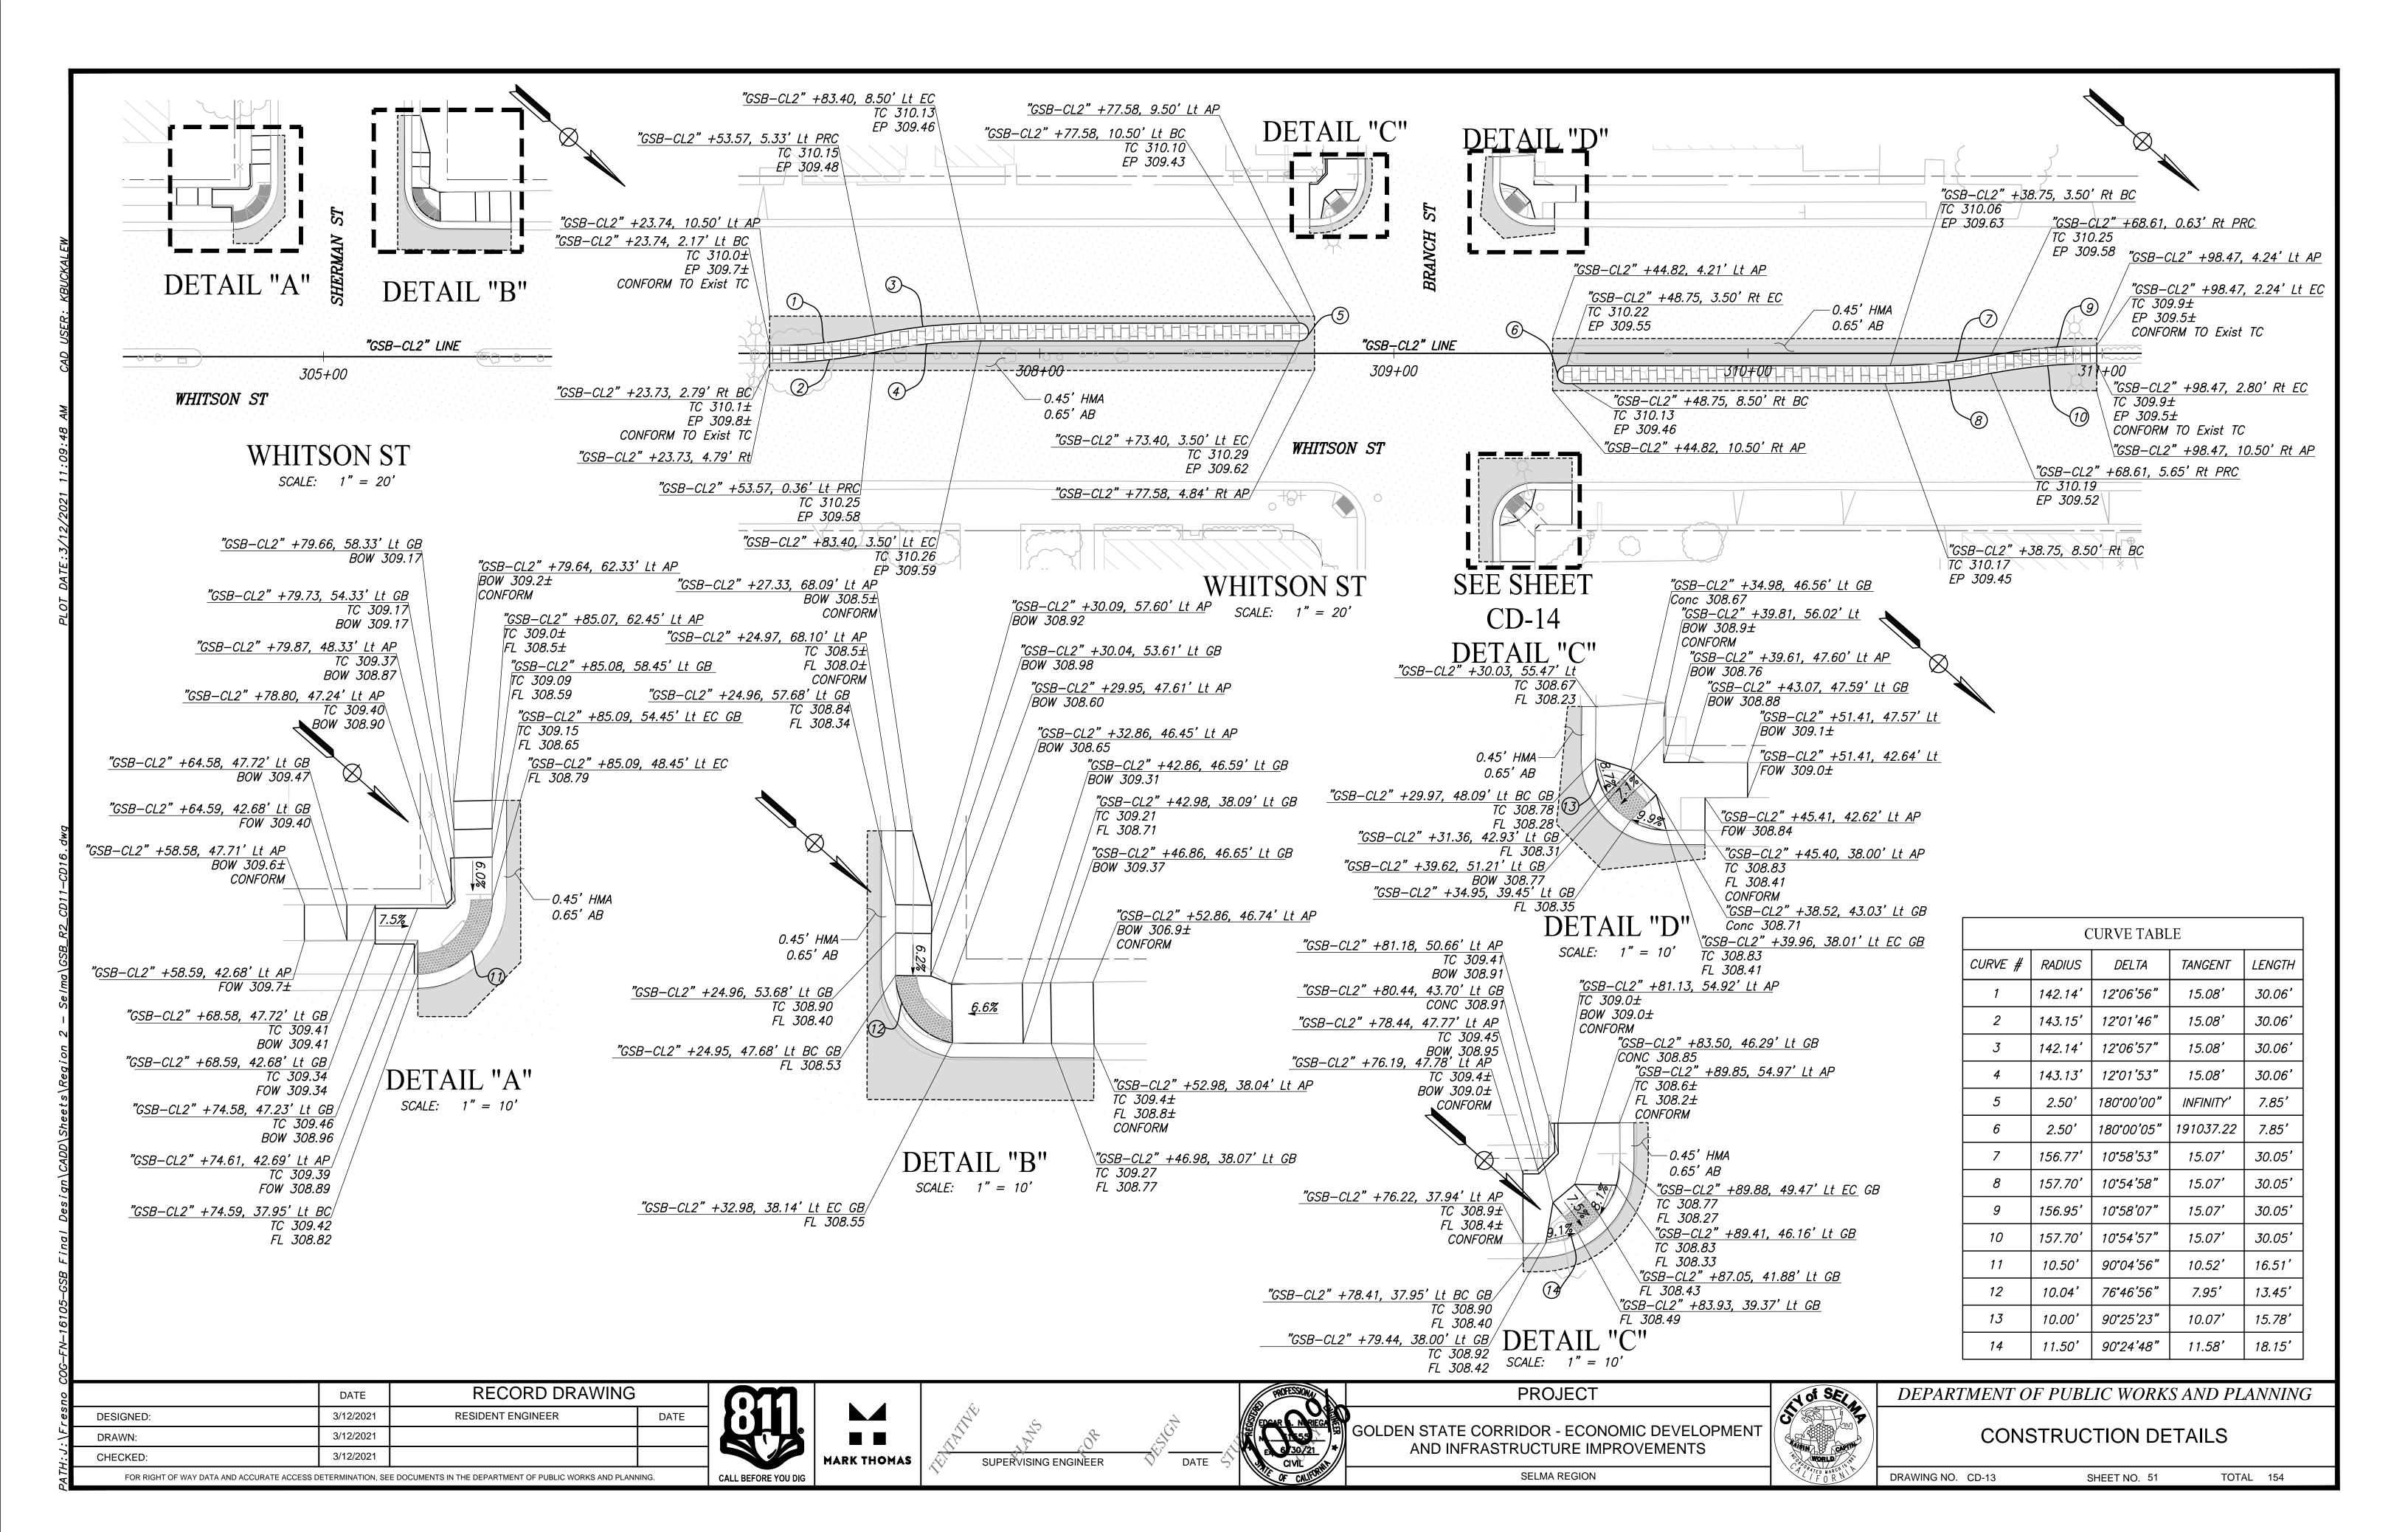

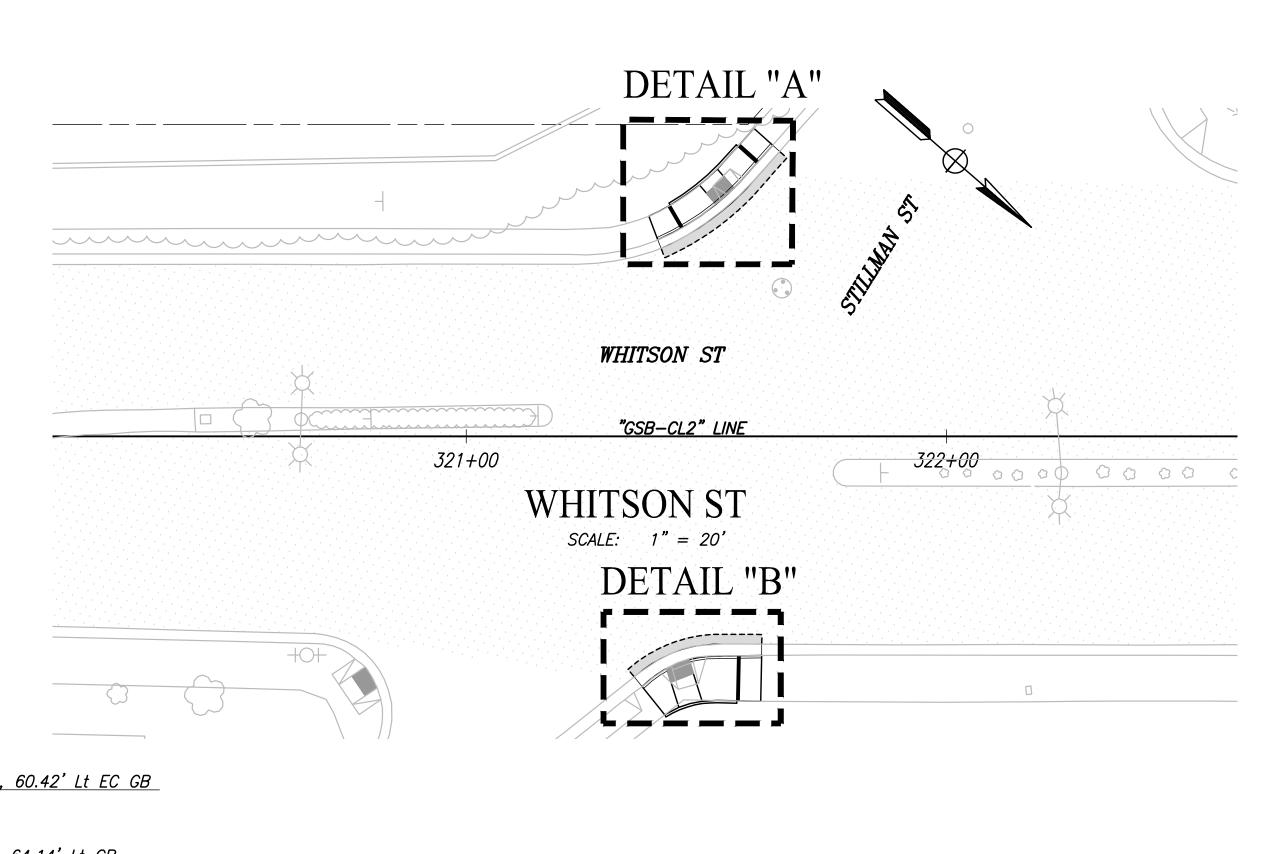

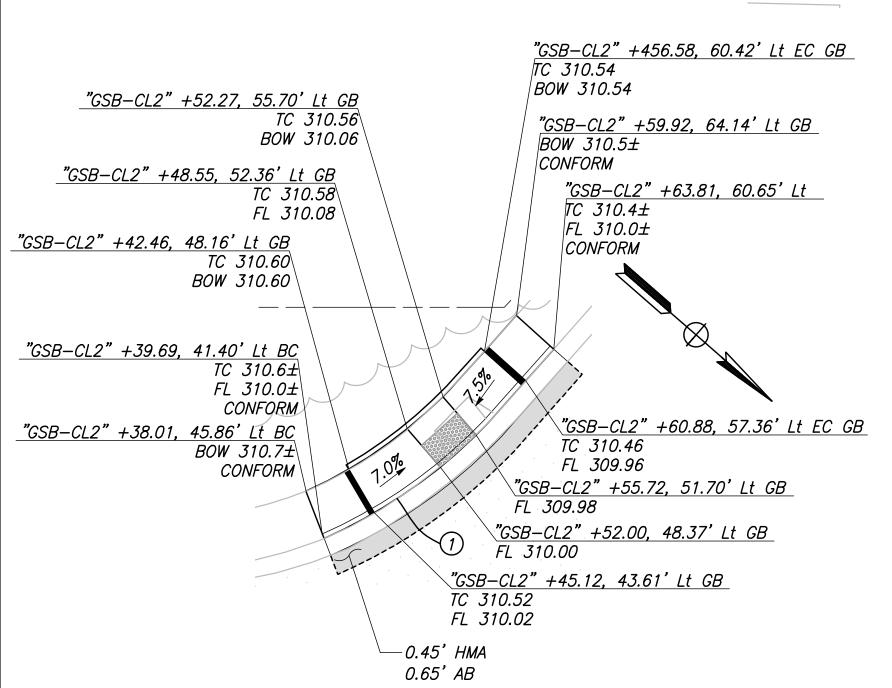

CURVE TABLE

22°23'19"

90**°**20'29"

TANGENT

10.57

9.25'

10.06

LENGTH

20.86

17.49'

15.77**'**


CURVE # RADIUS


53.39 [′]

21.70'

10.00'



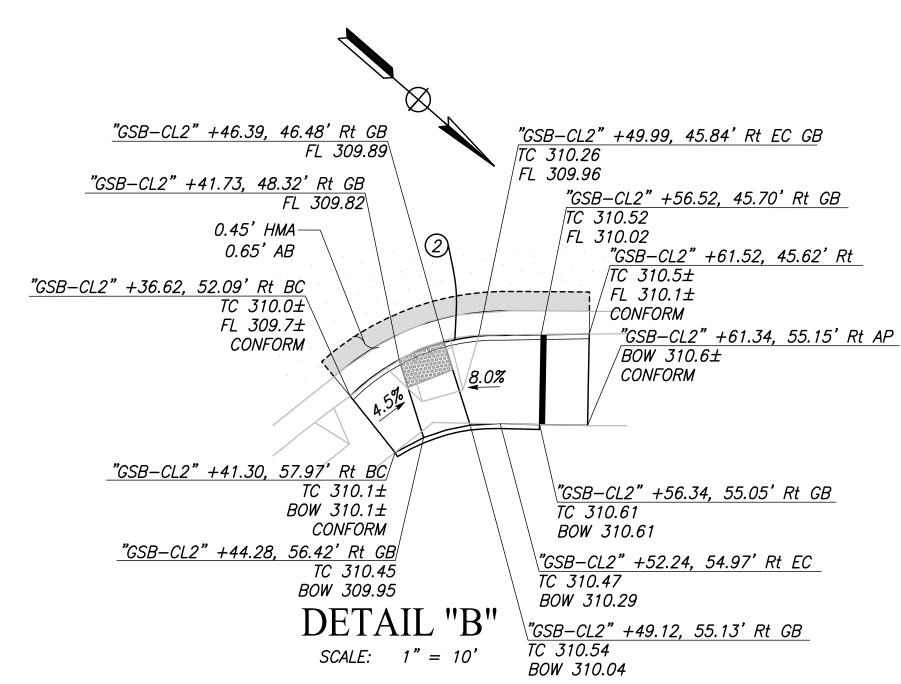

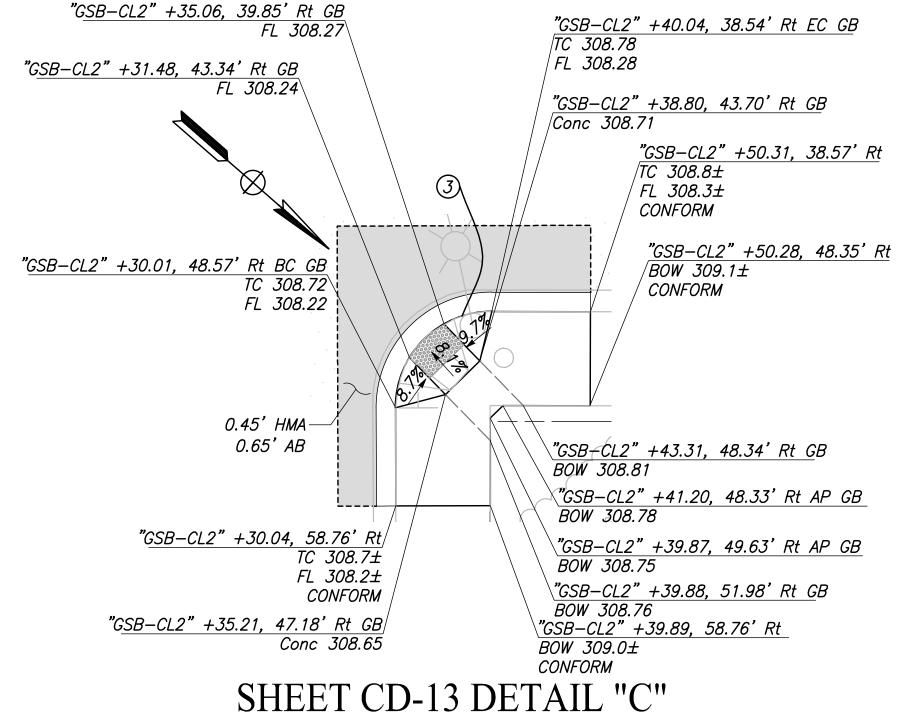



	DATE	RECORD DRAWING	
DESIGNED:	3/12/2021	RESIDENT ENGINEER	DATE
DRAWN:	3/12/2021		
CHECKED:	3/12/2021		
FOR RIGHT OF WAY DATA AND ACCURATE ACCESS DETERMINATION. SEE DOCUMENTS IN THE DEPARTMENT OF PURLIC WORKS AND PLANNING			



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MARK THOMAS



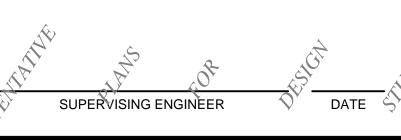

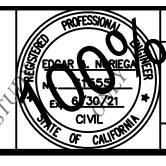GOLDEN STATE CORRIDOR - ECONOMIC DEVELOPMENT
AND INFRASTRUCTURE IMPROVEMENTS

SELMA REGION

PROJECT





SCALE: 1" = 10'


DEPARTMENT OF PUBLIC WORKS AND PLANNING


CONSTRUCTION DETAILS


DRAWING NO. CD-14 SHEET NO. 52 TOTAL 154

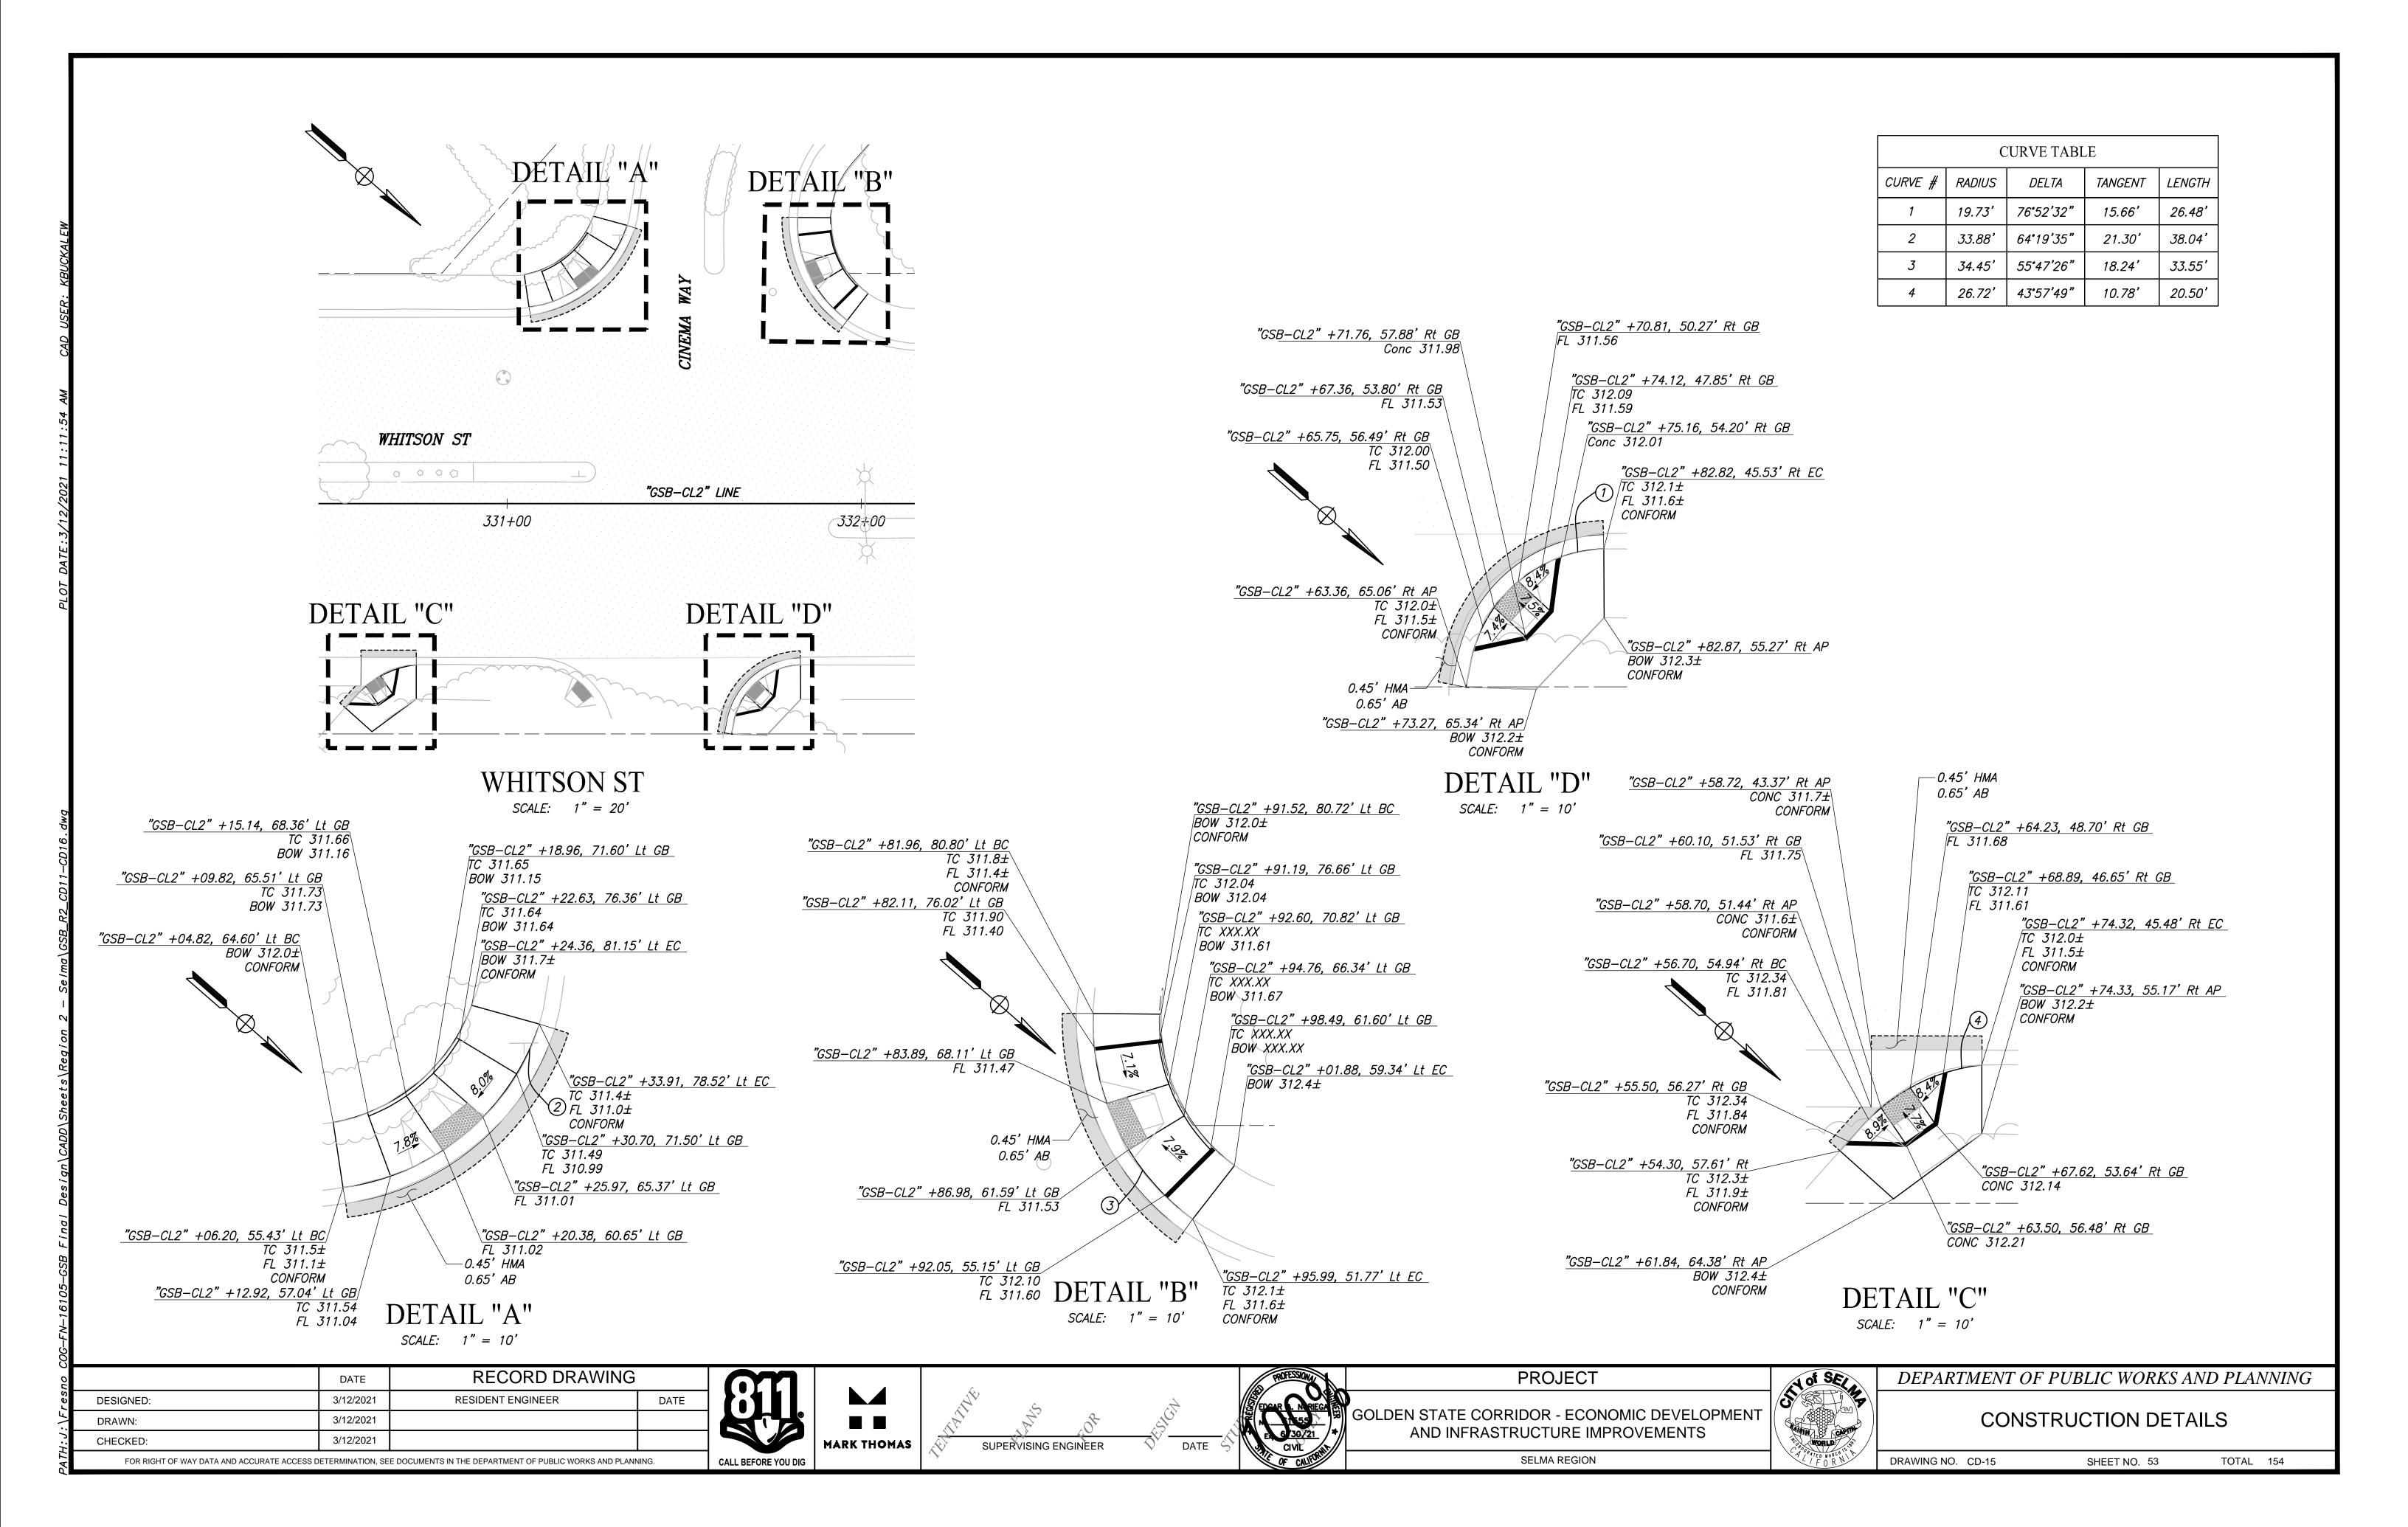


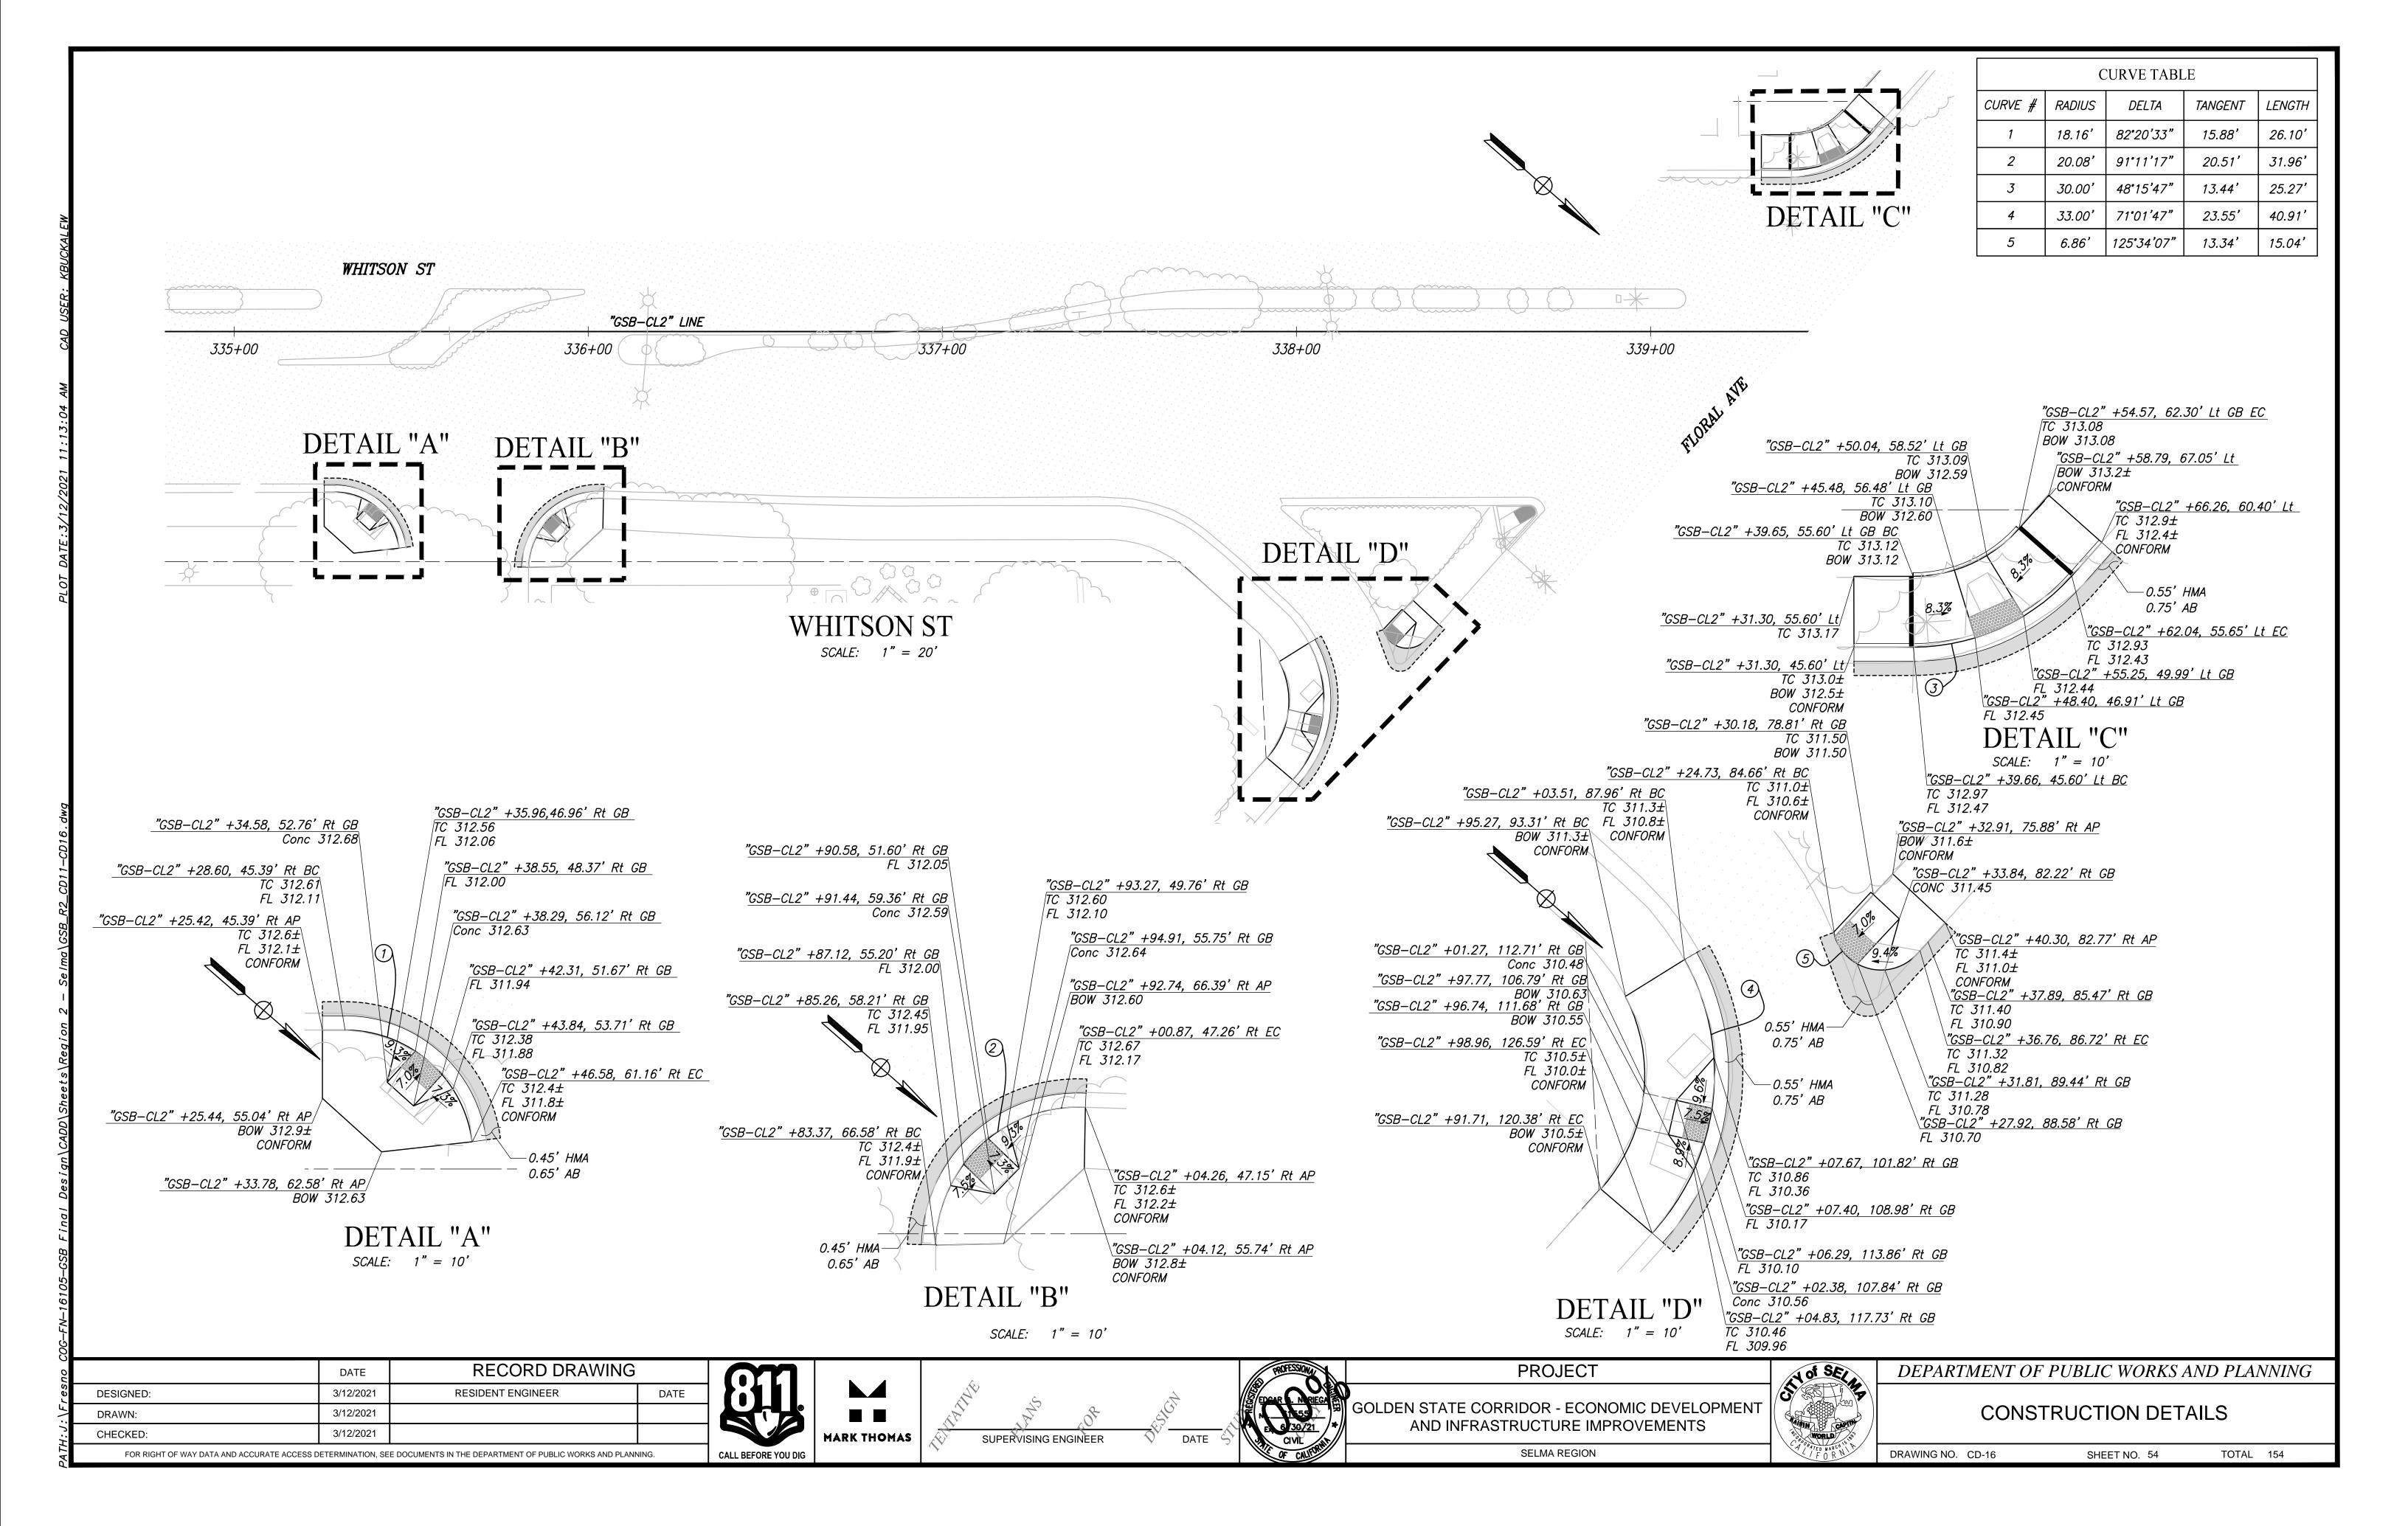


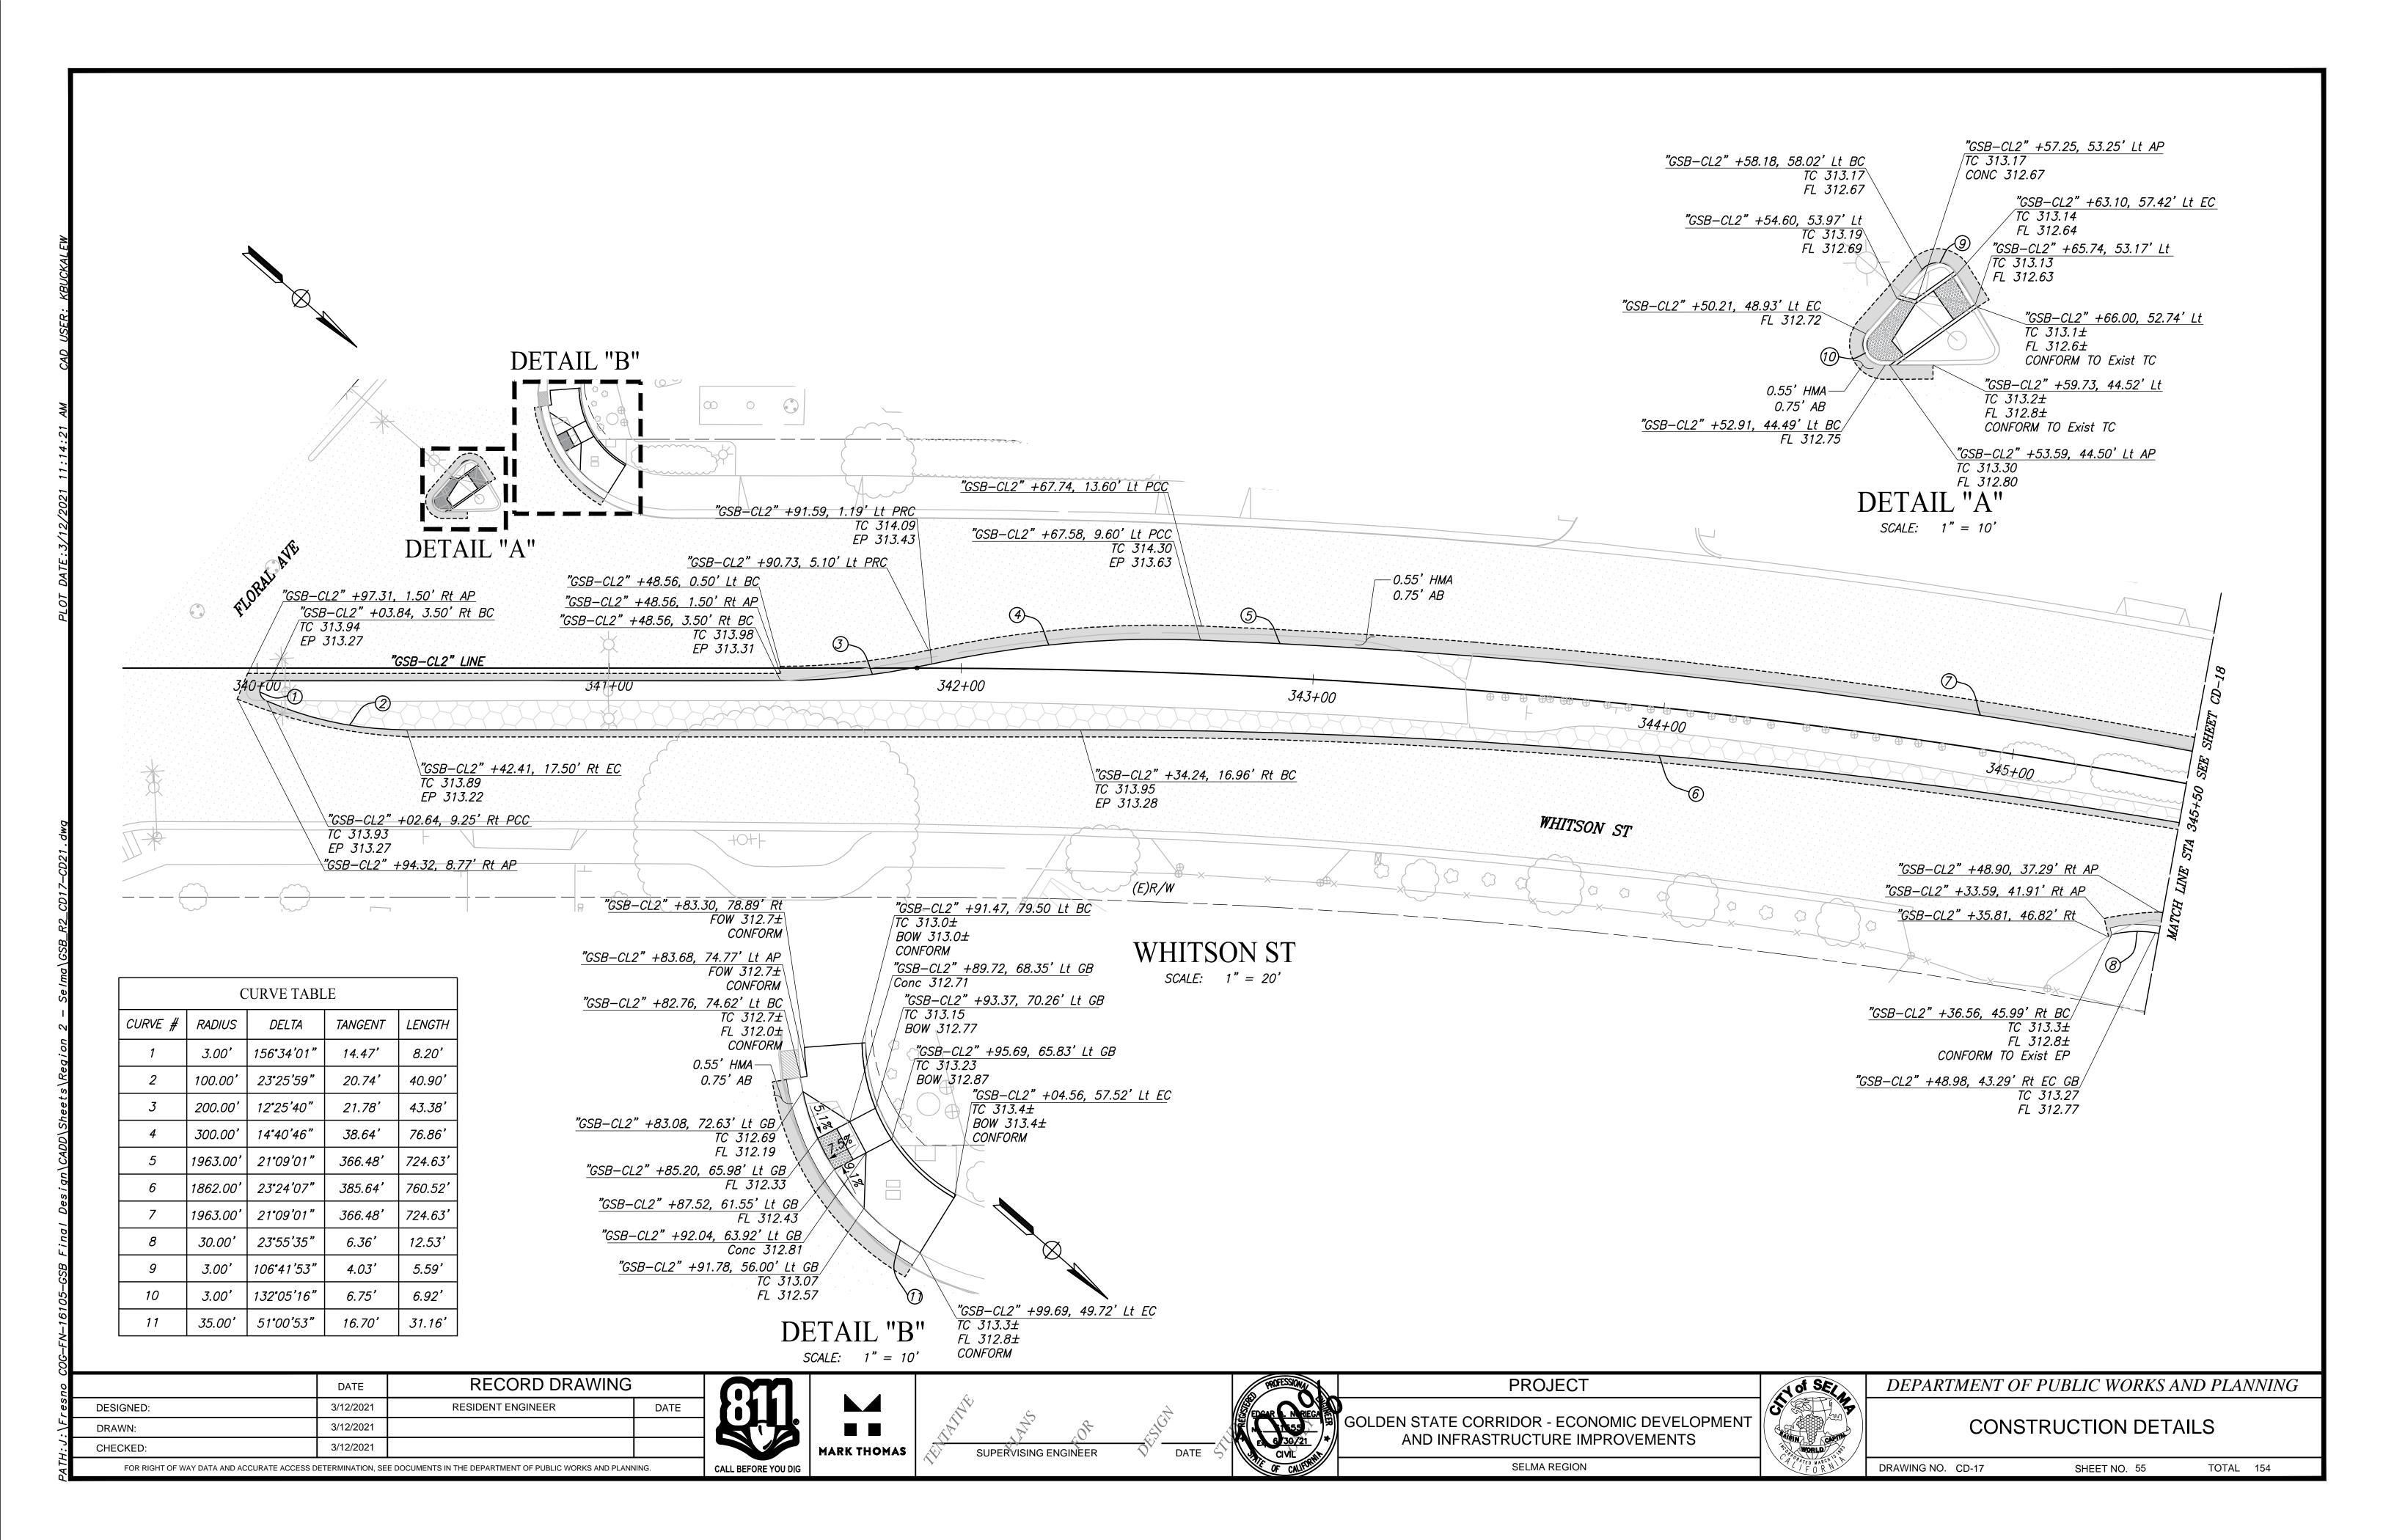


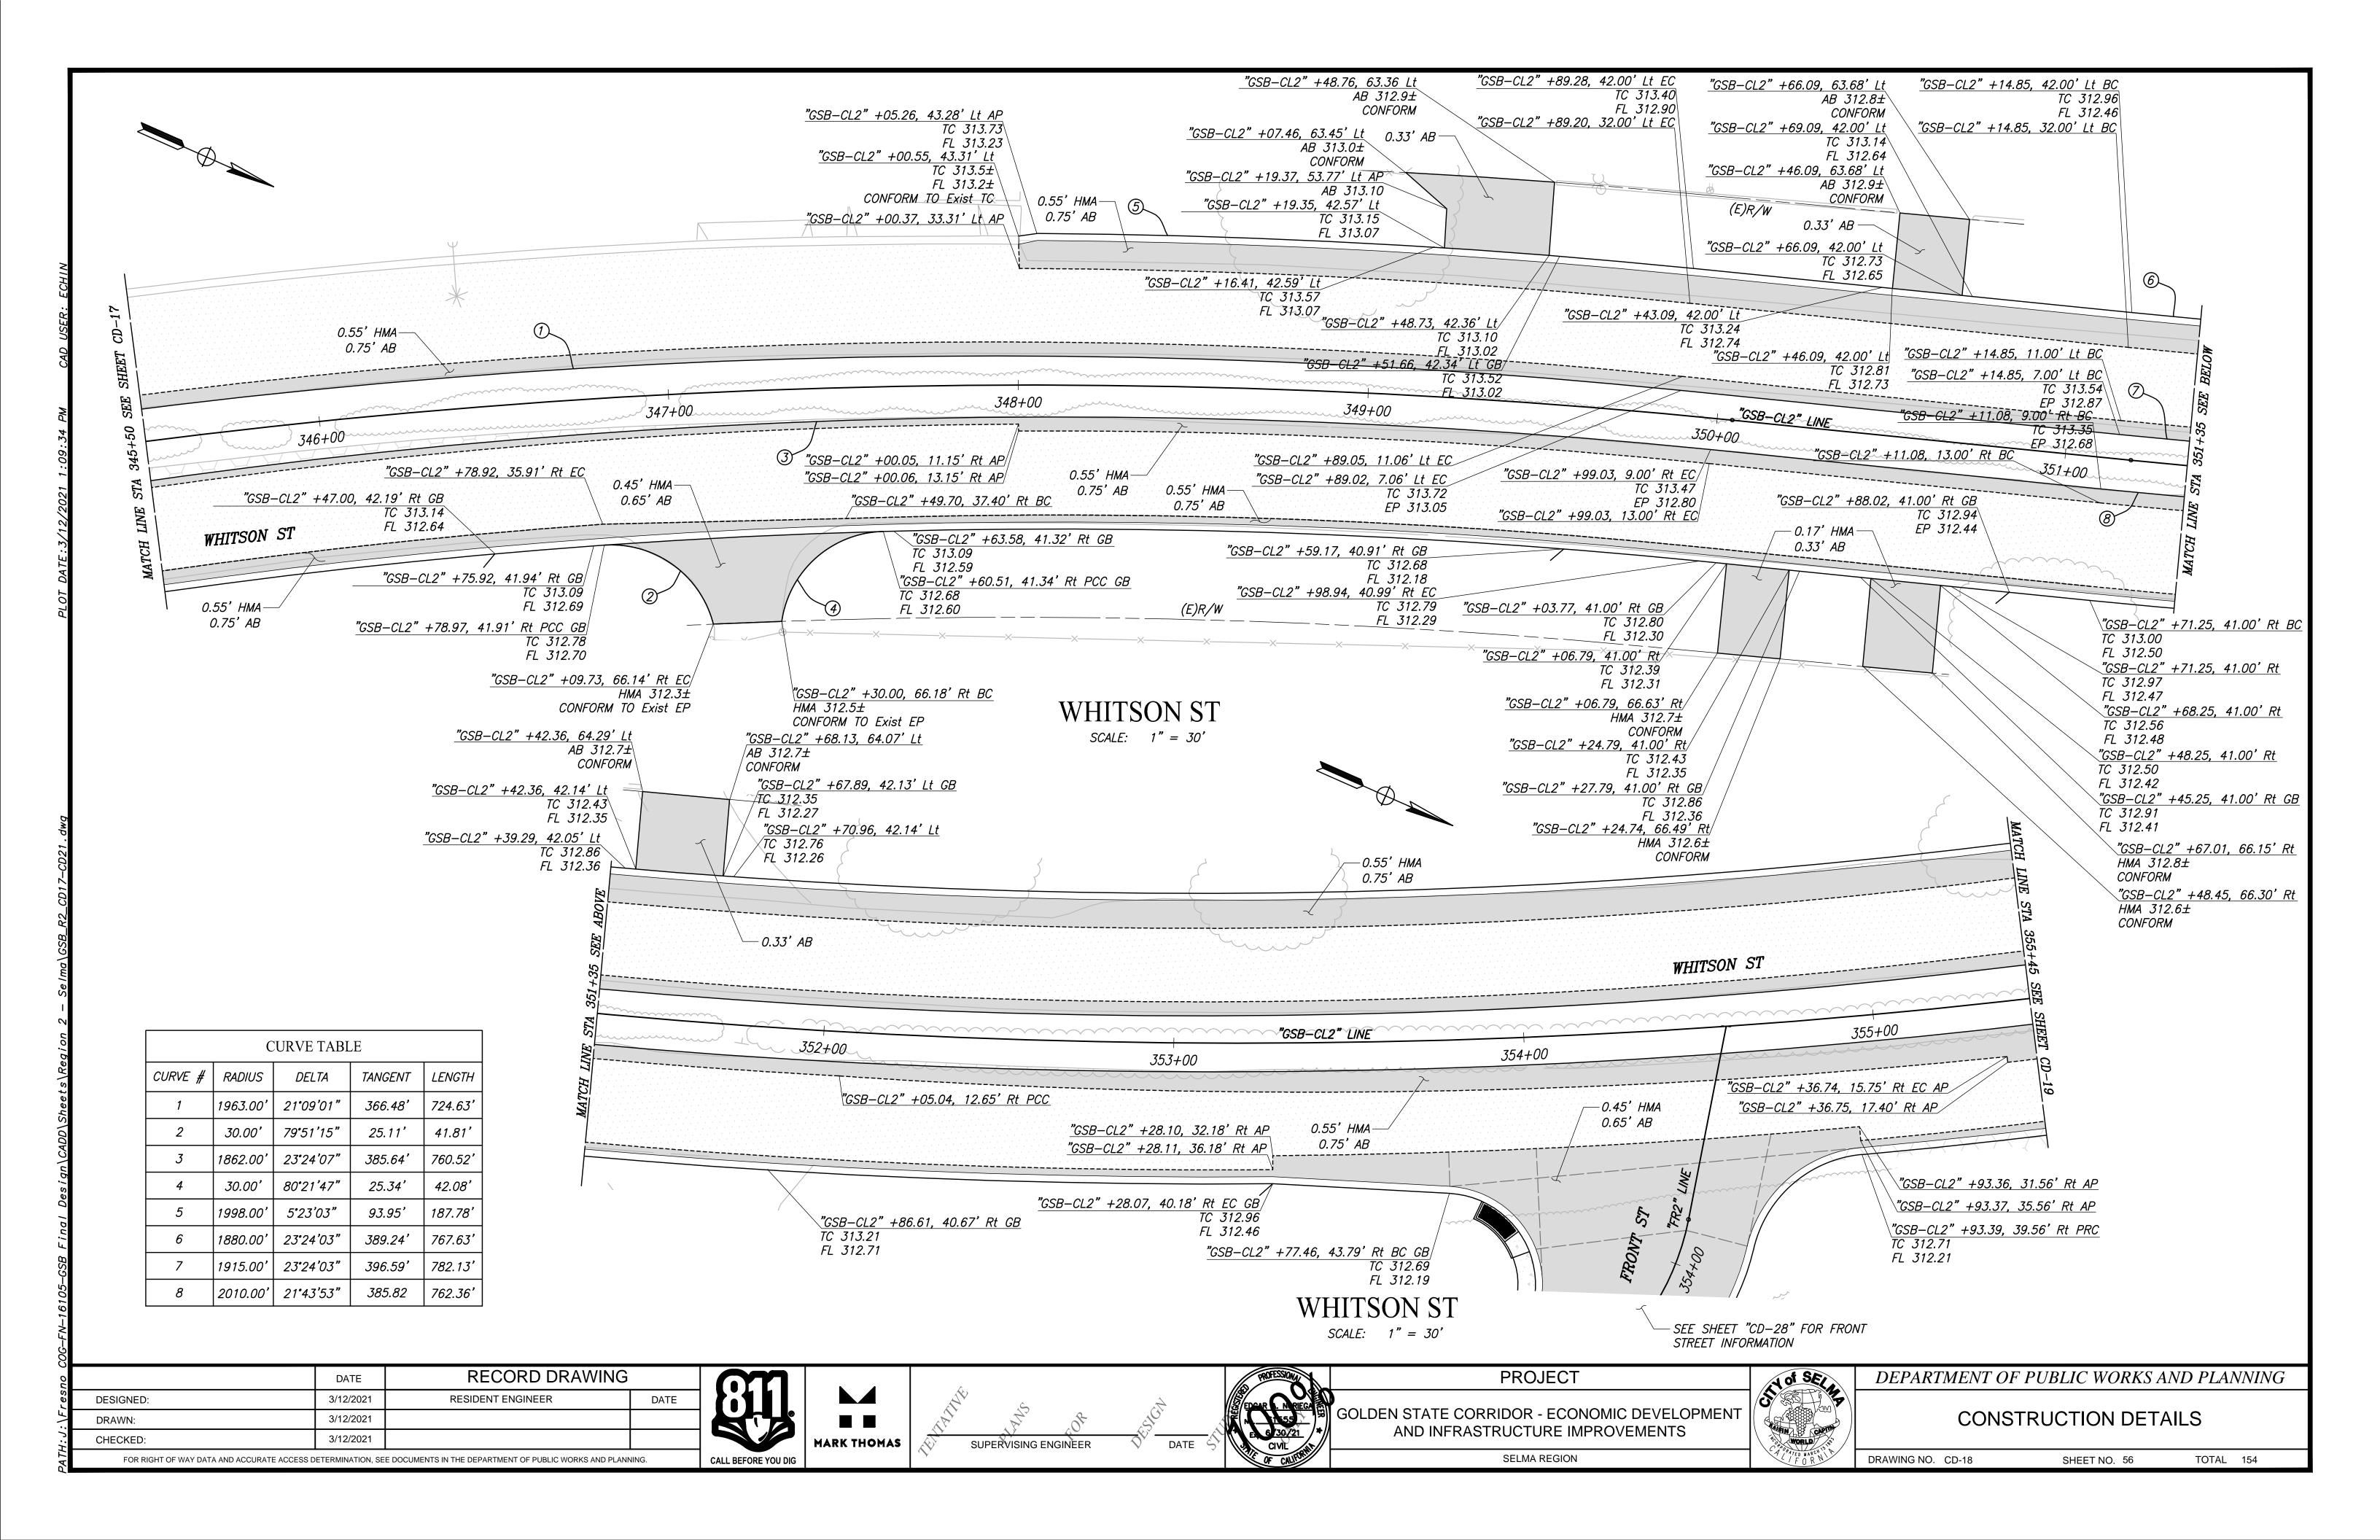


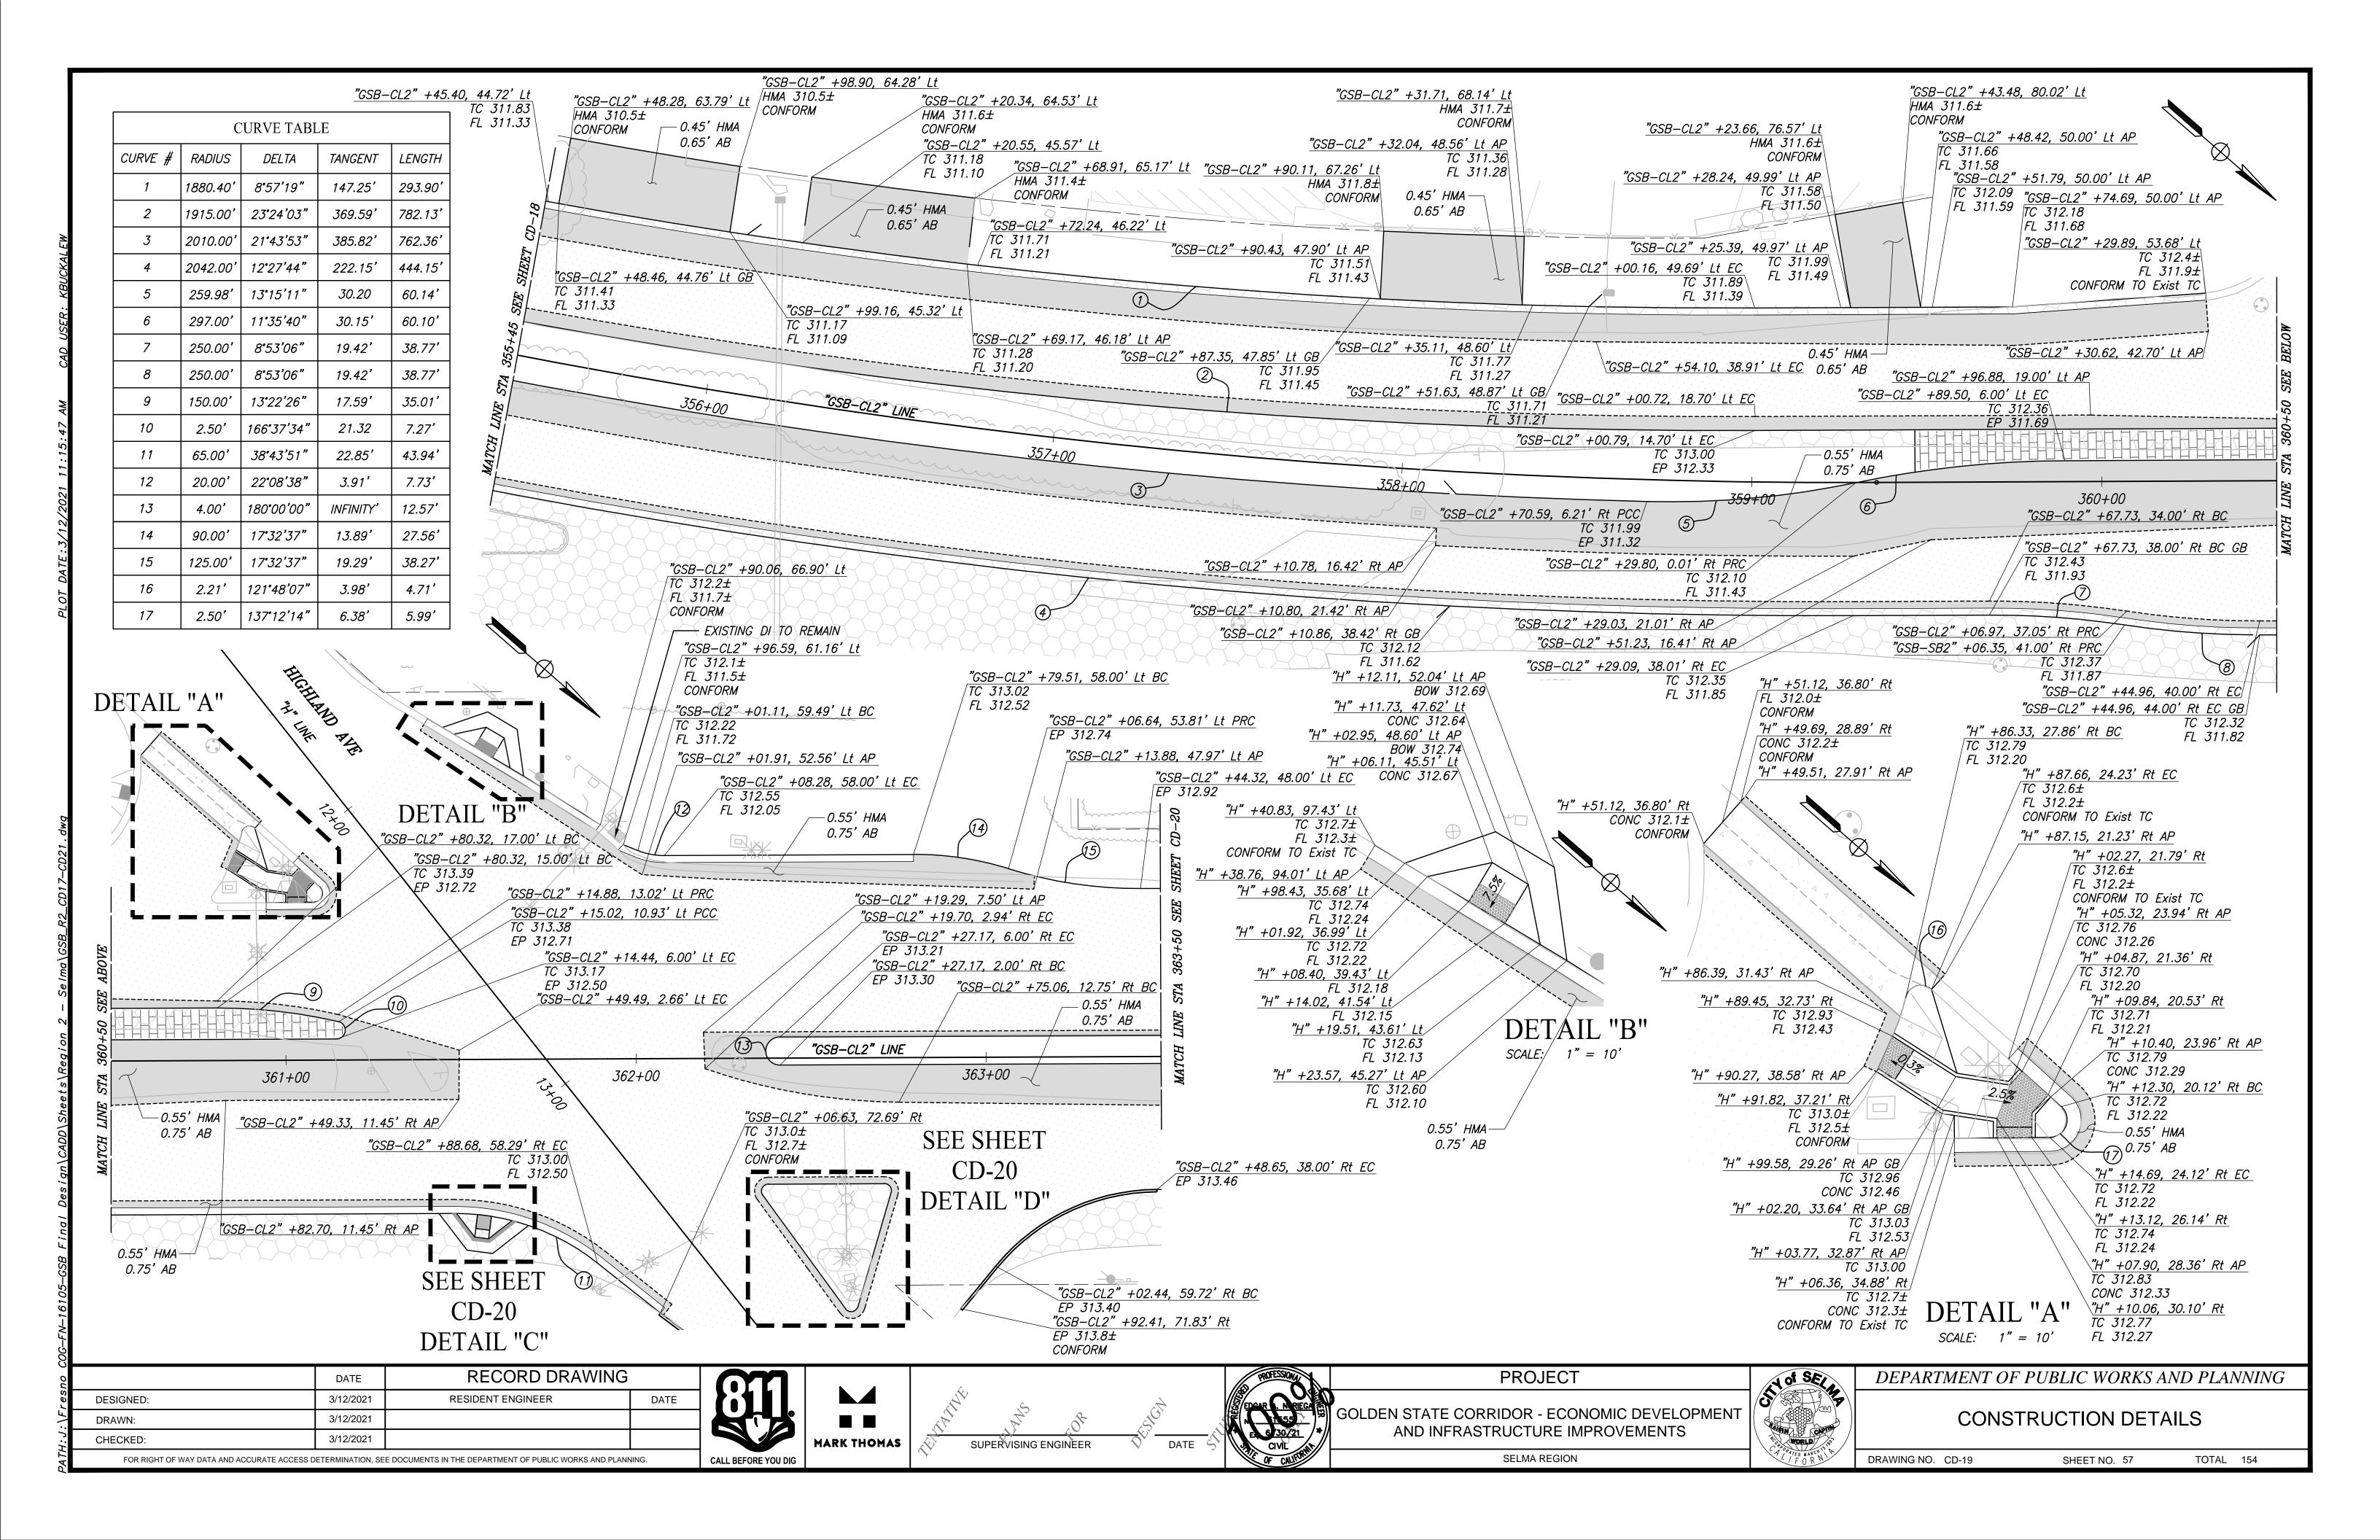


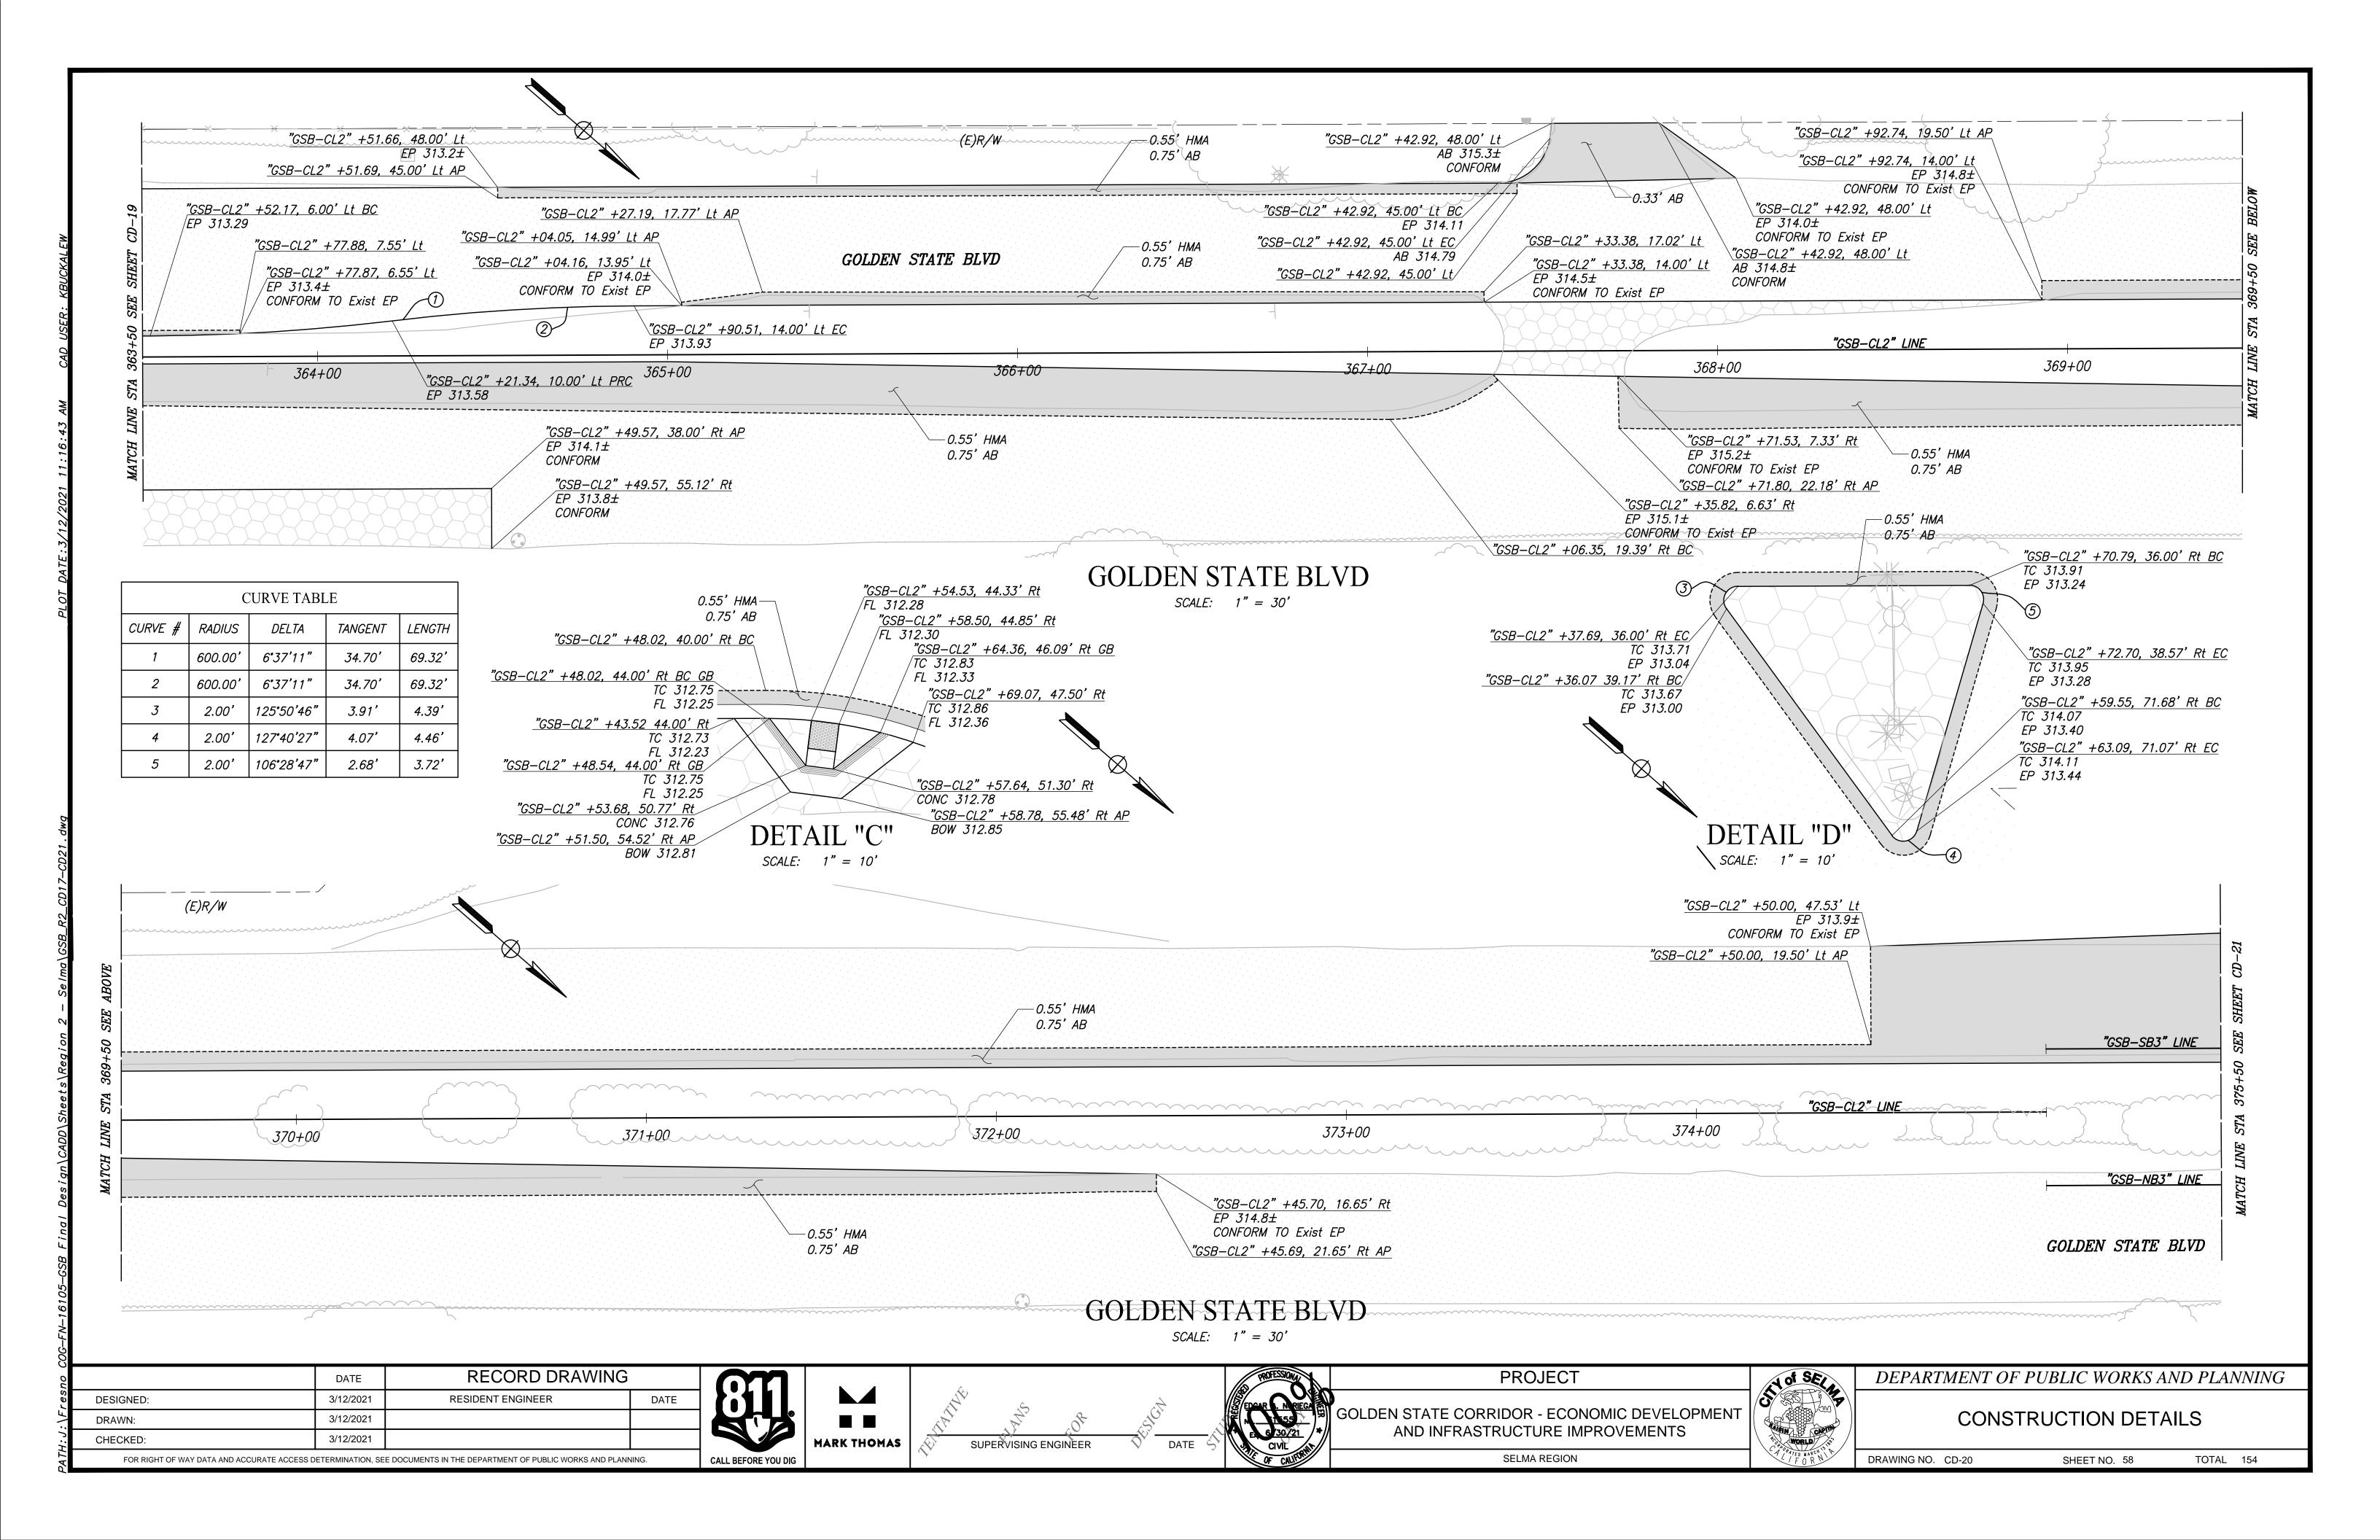


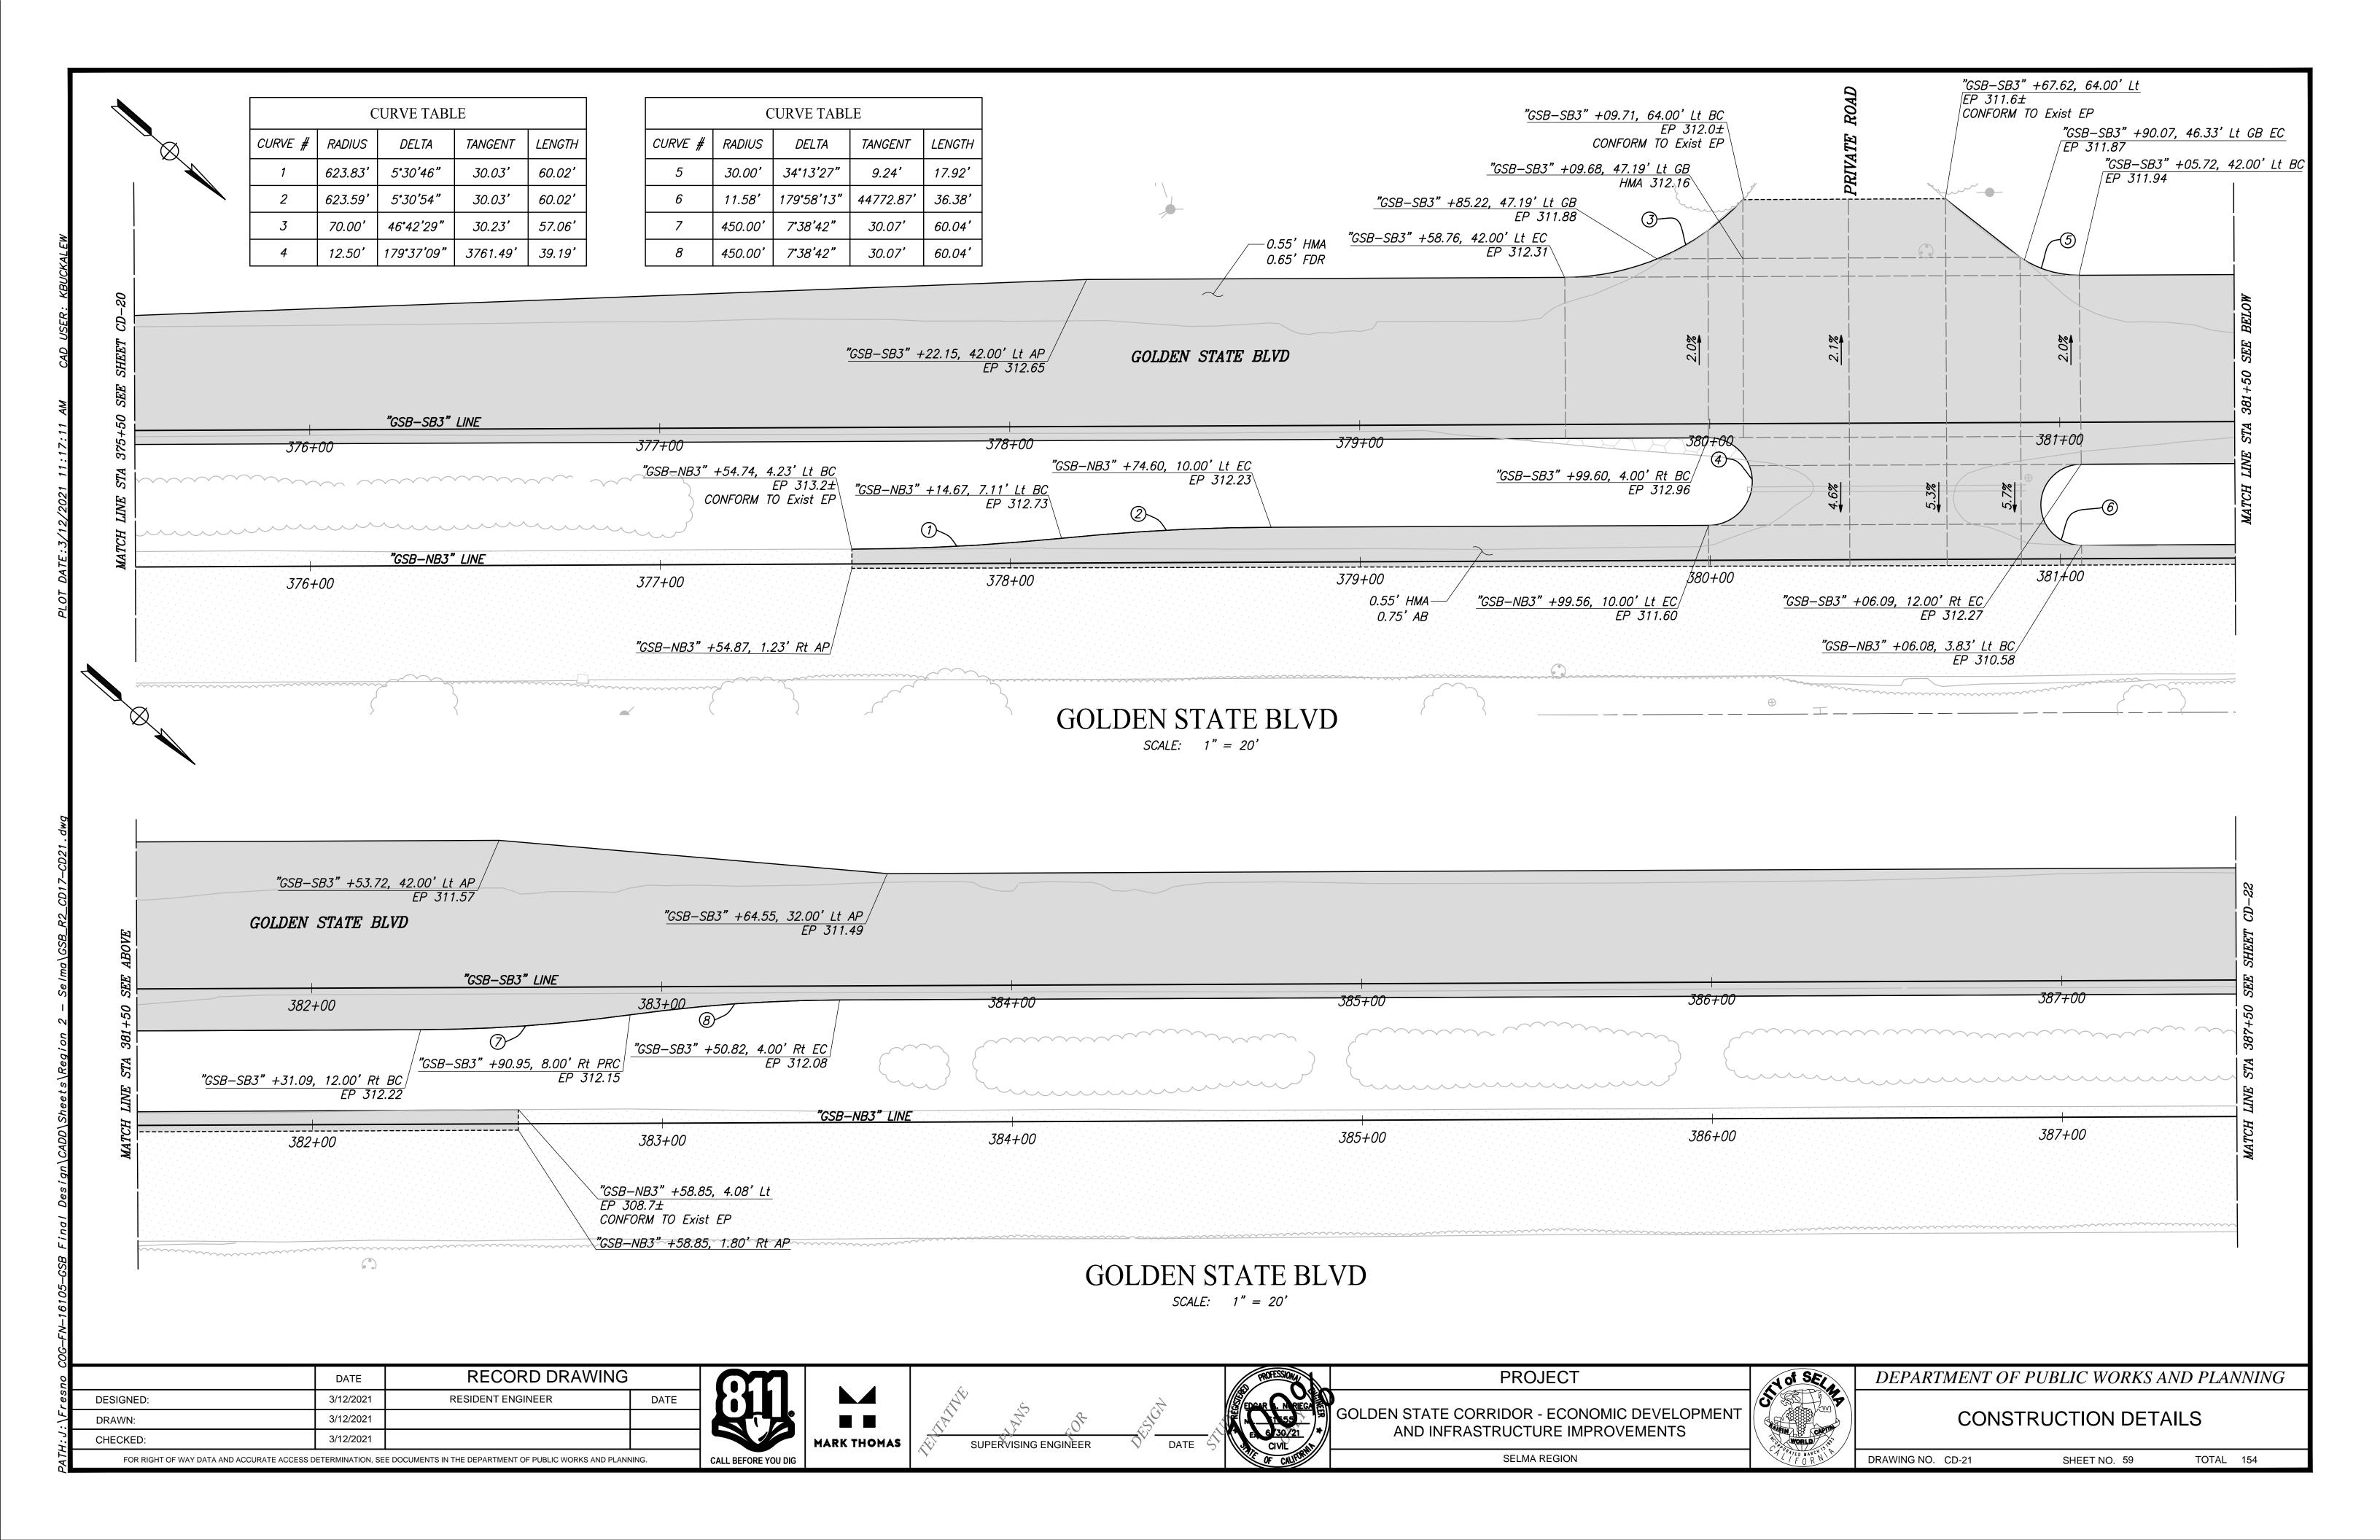


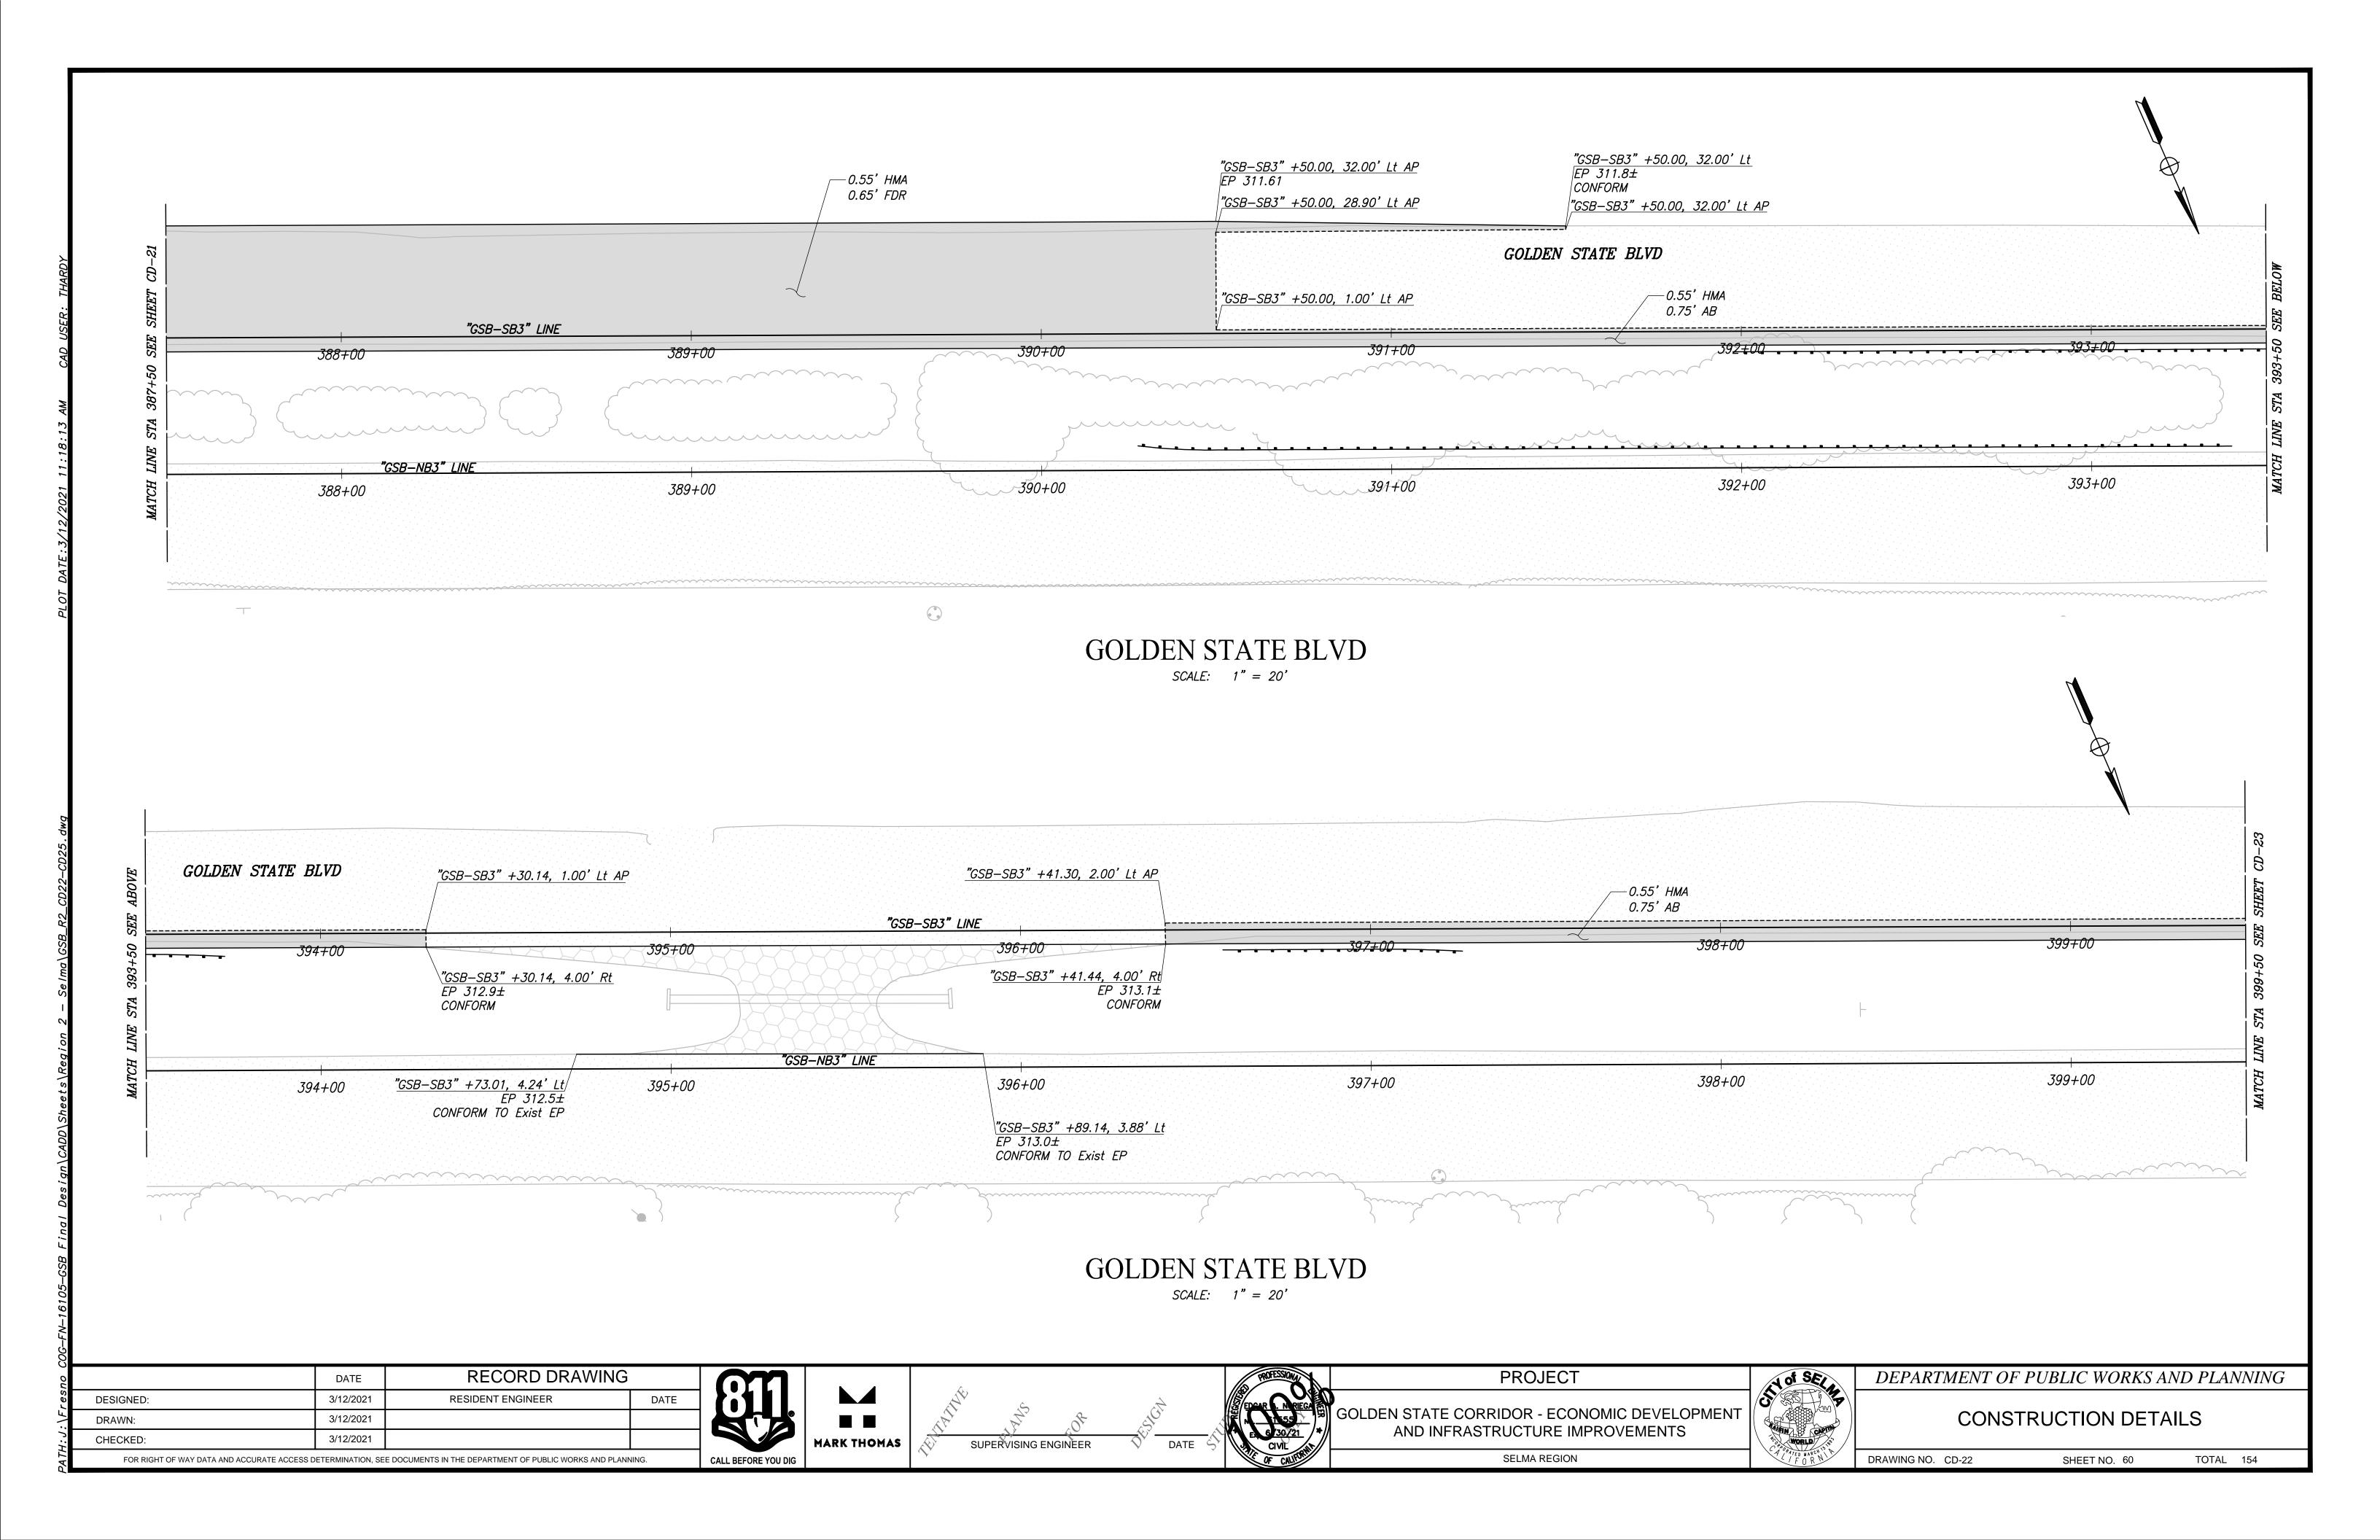


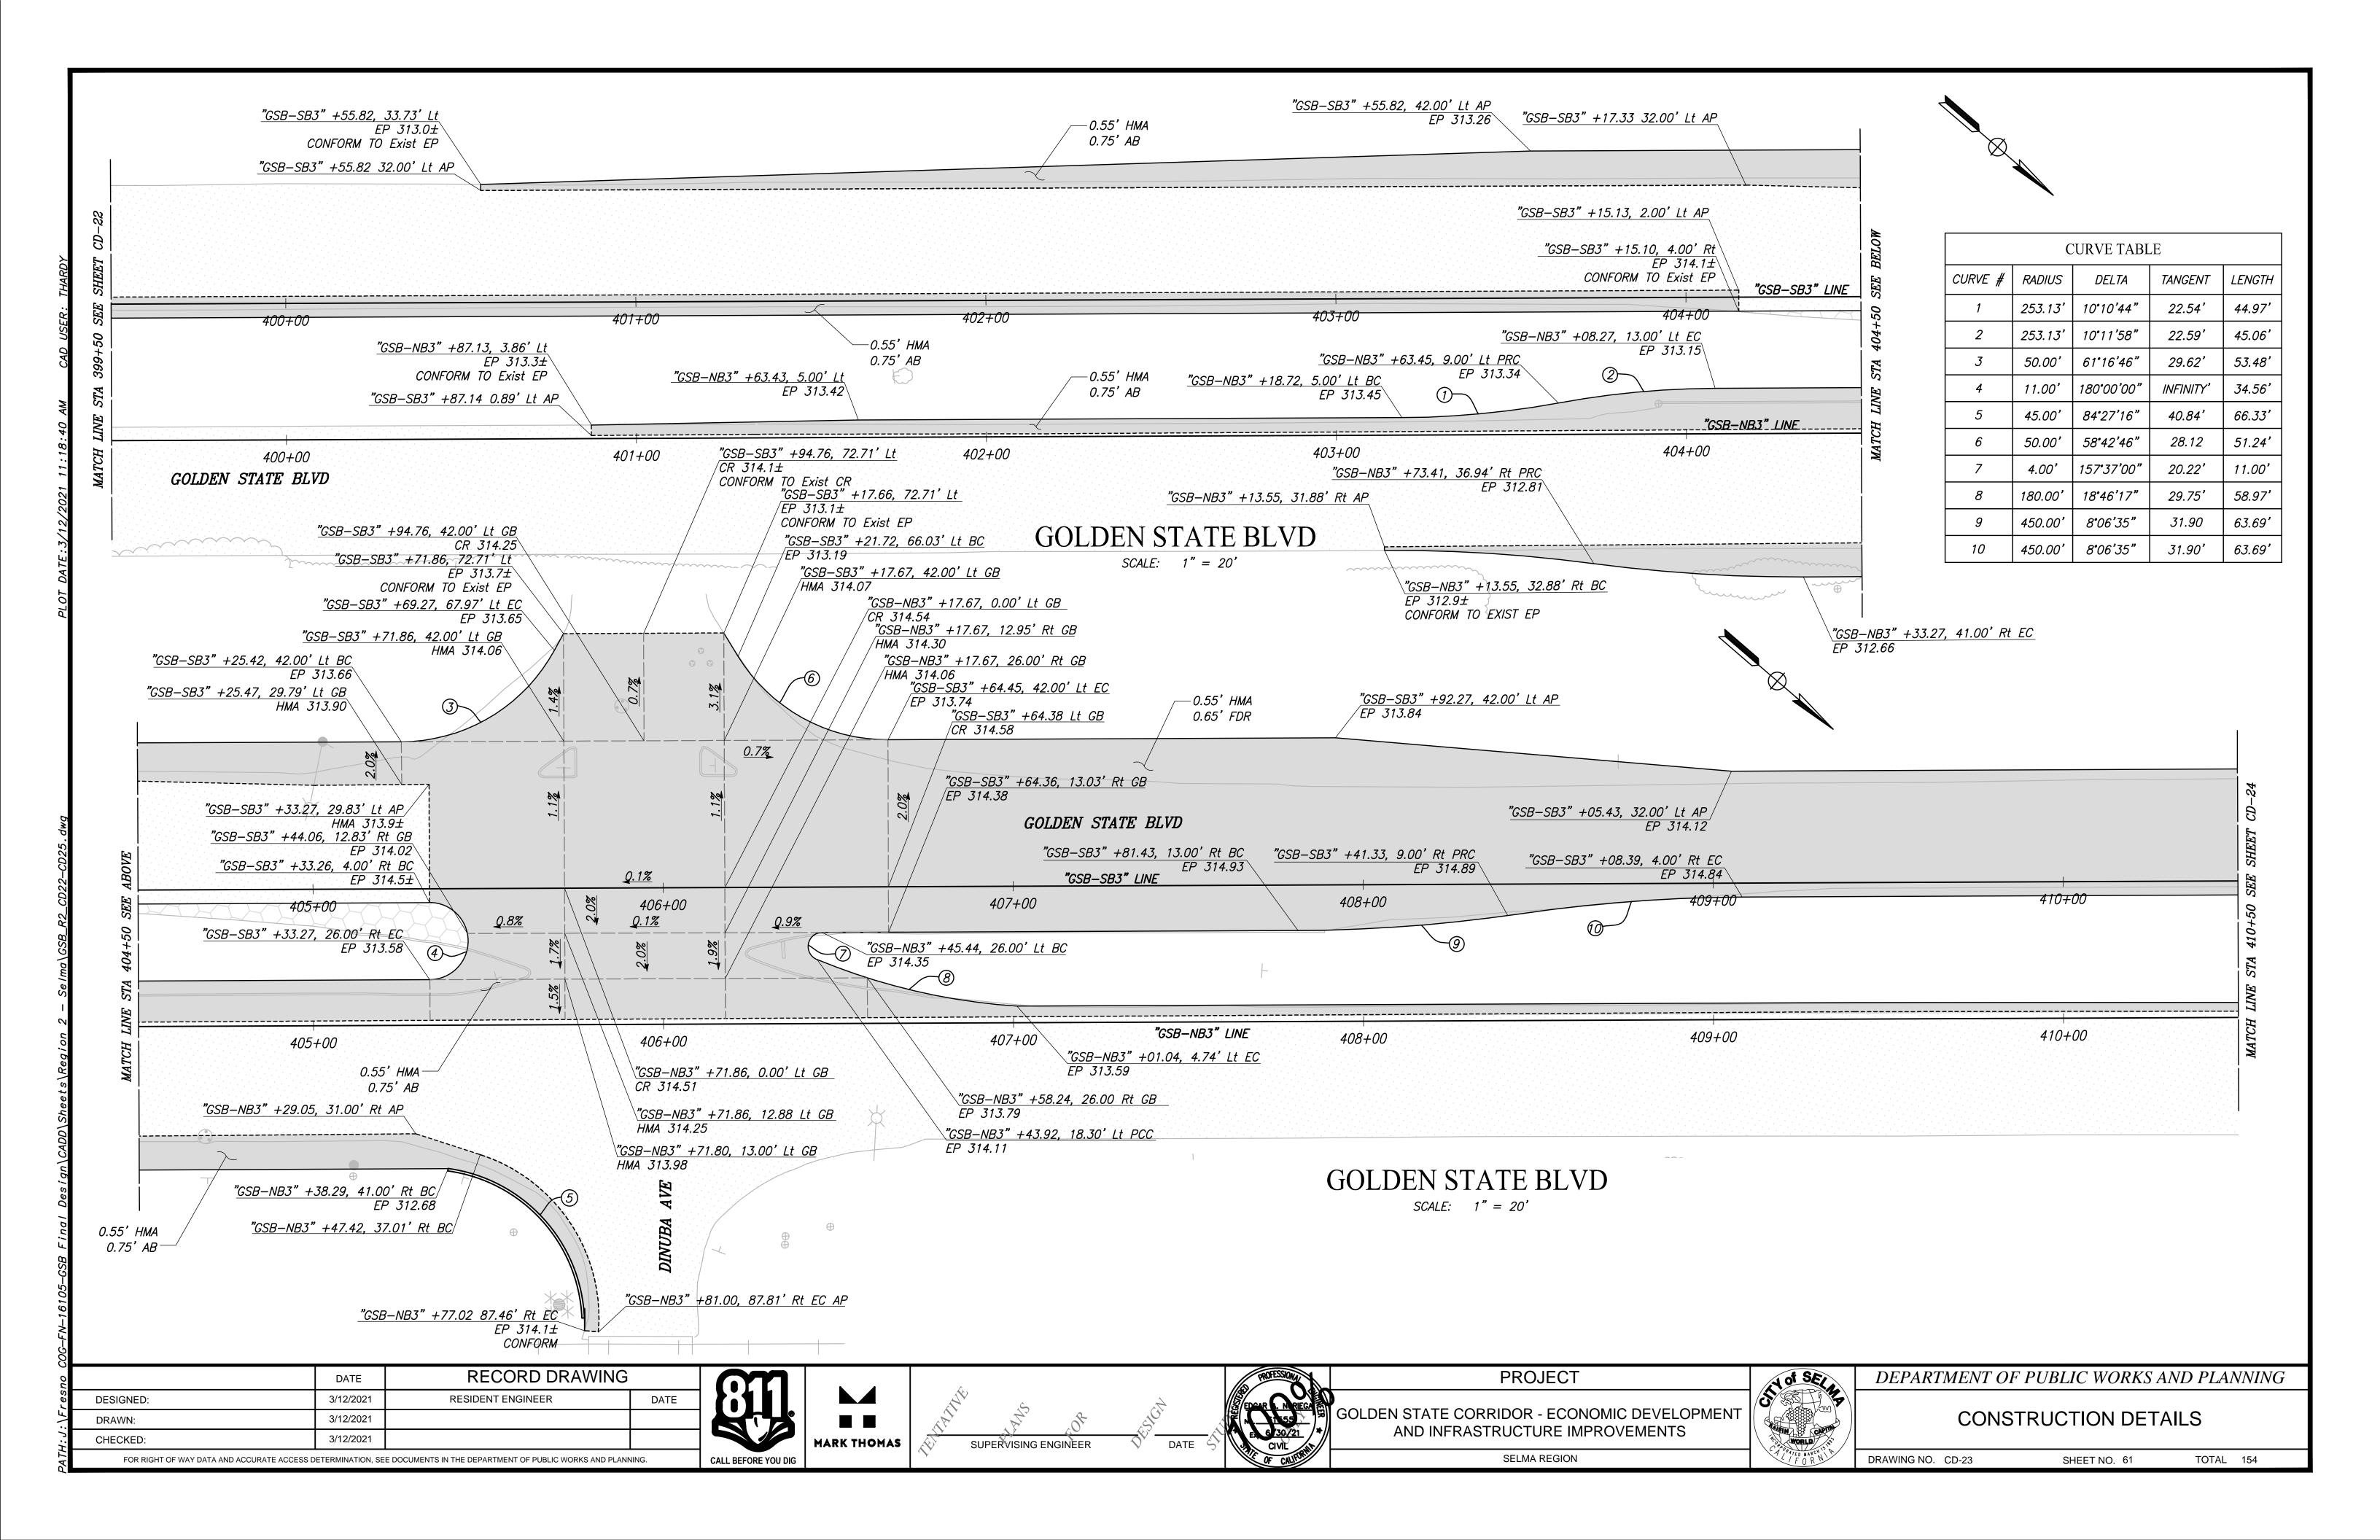


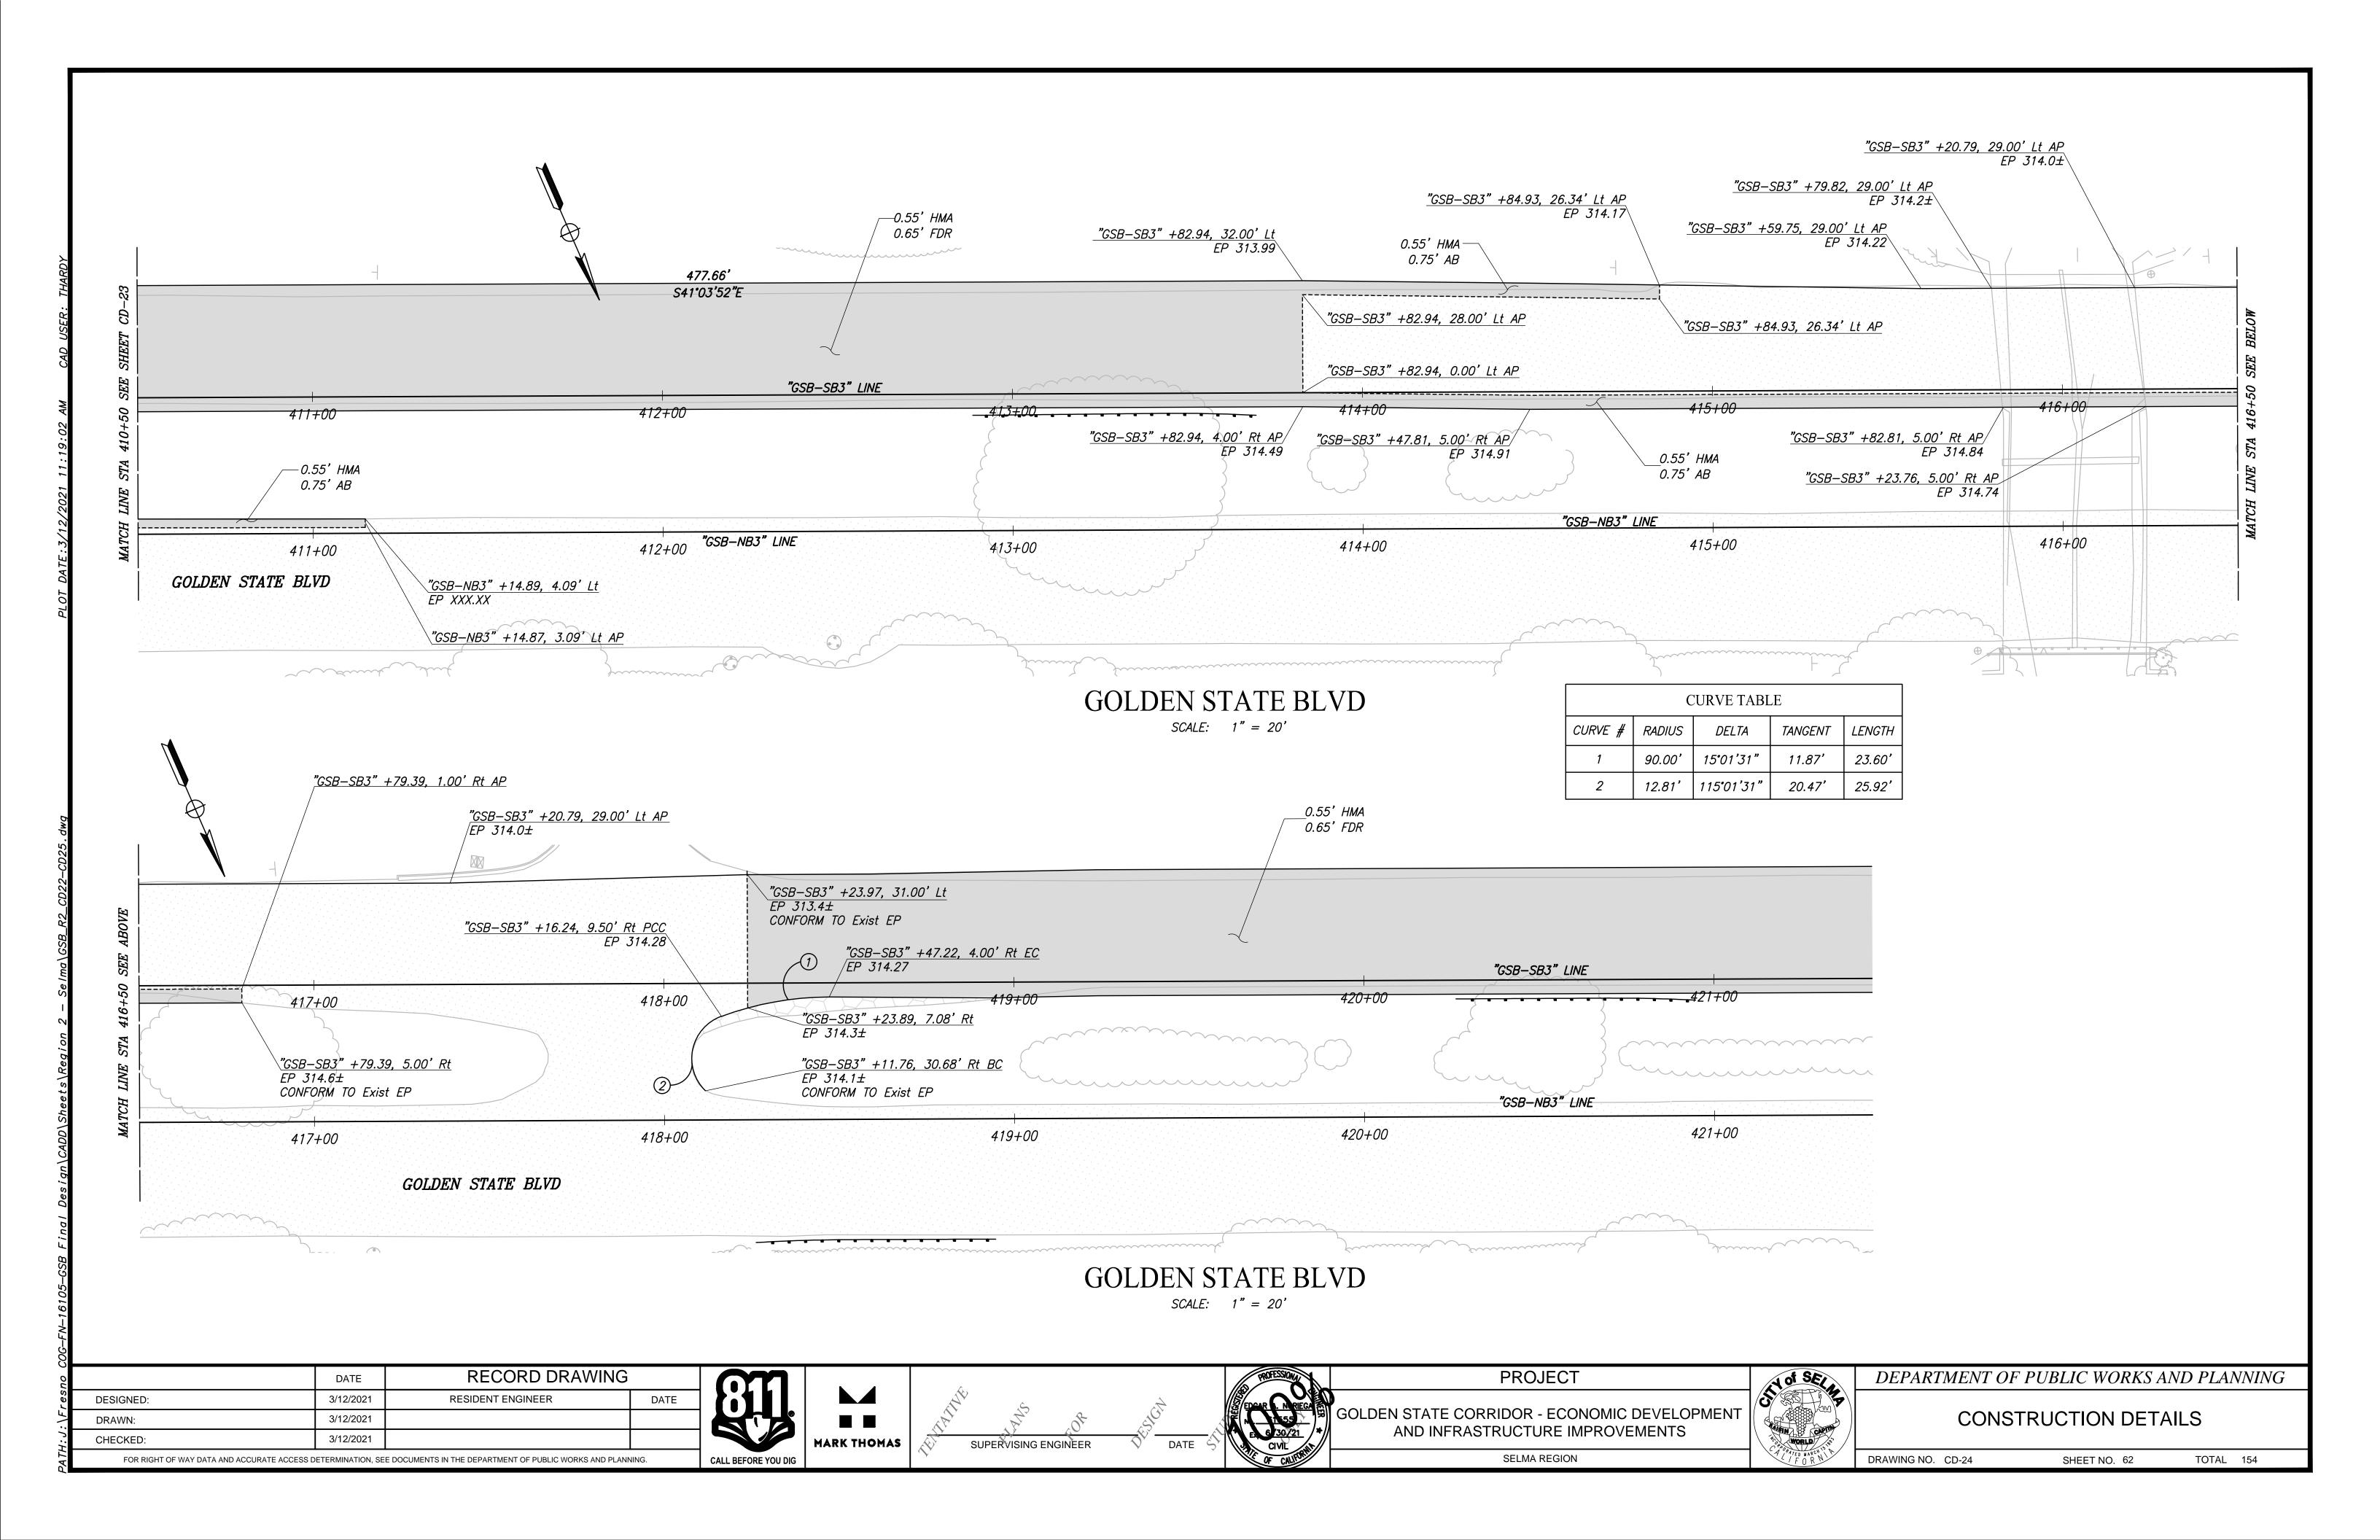


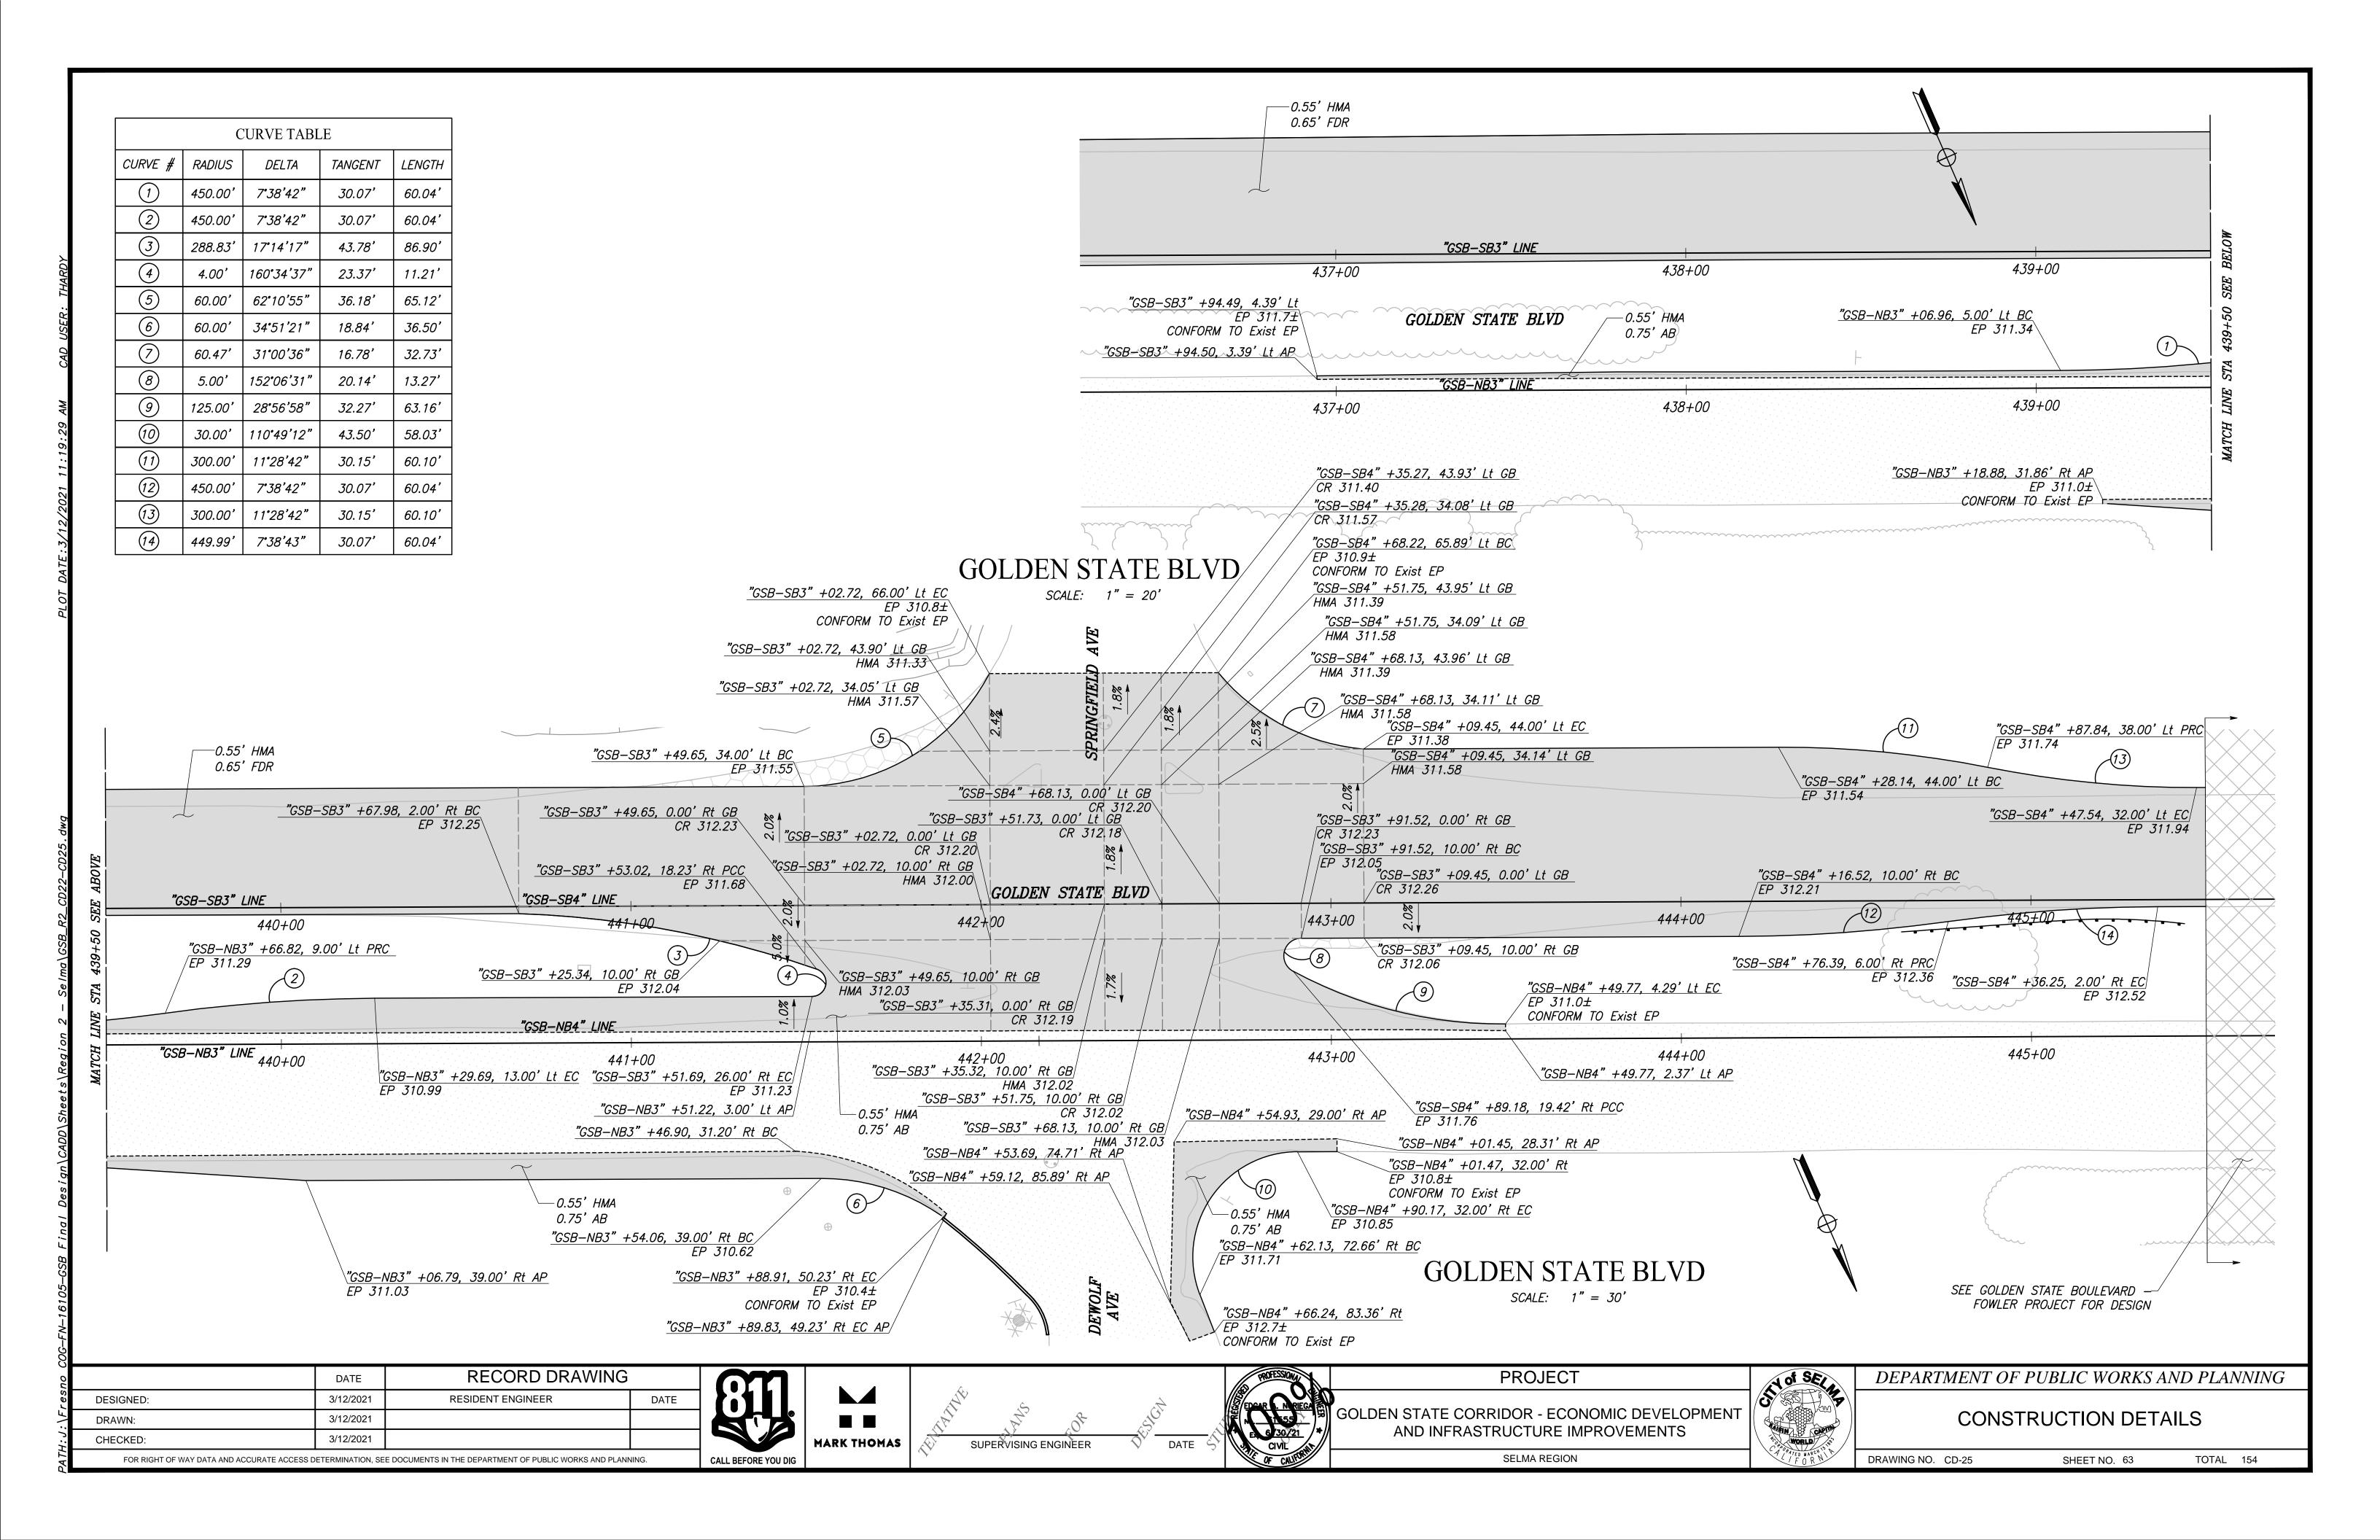


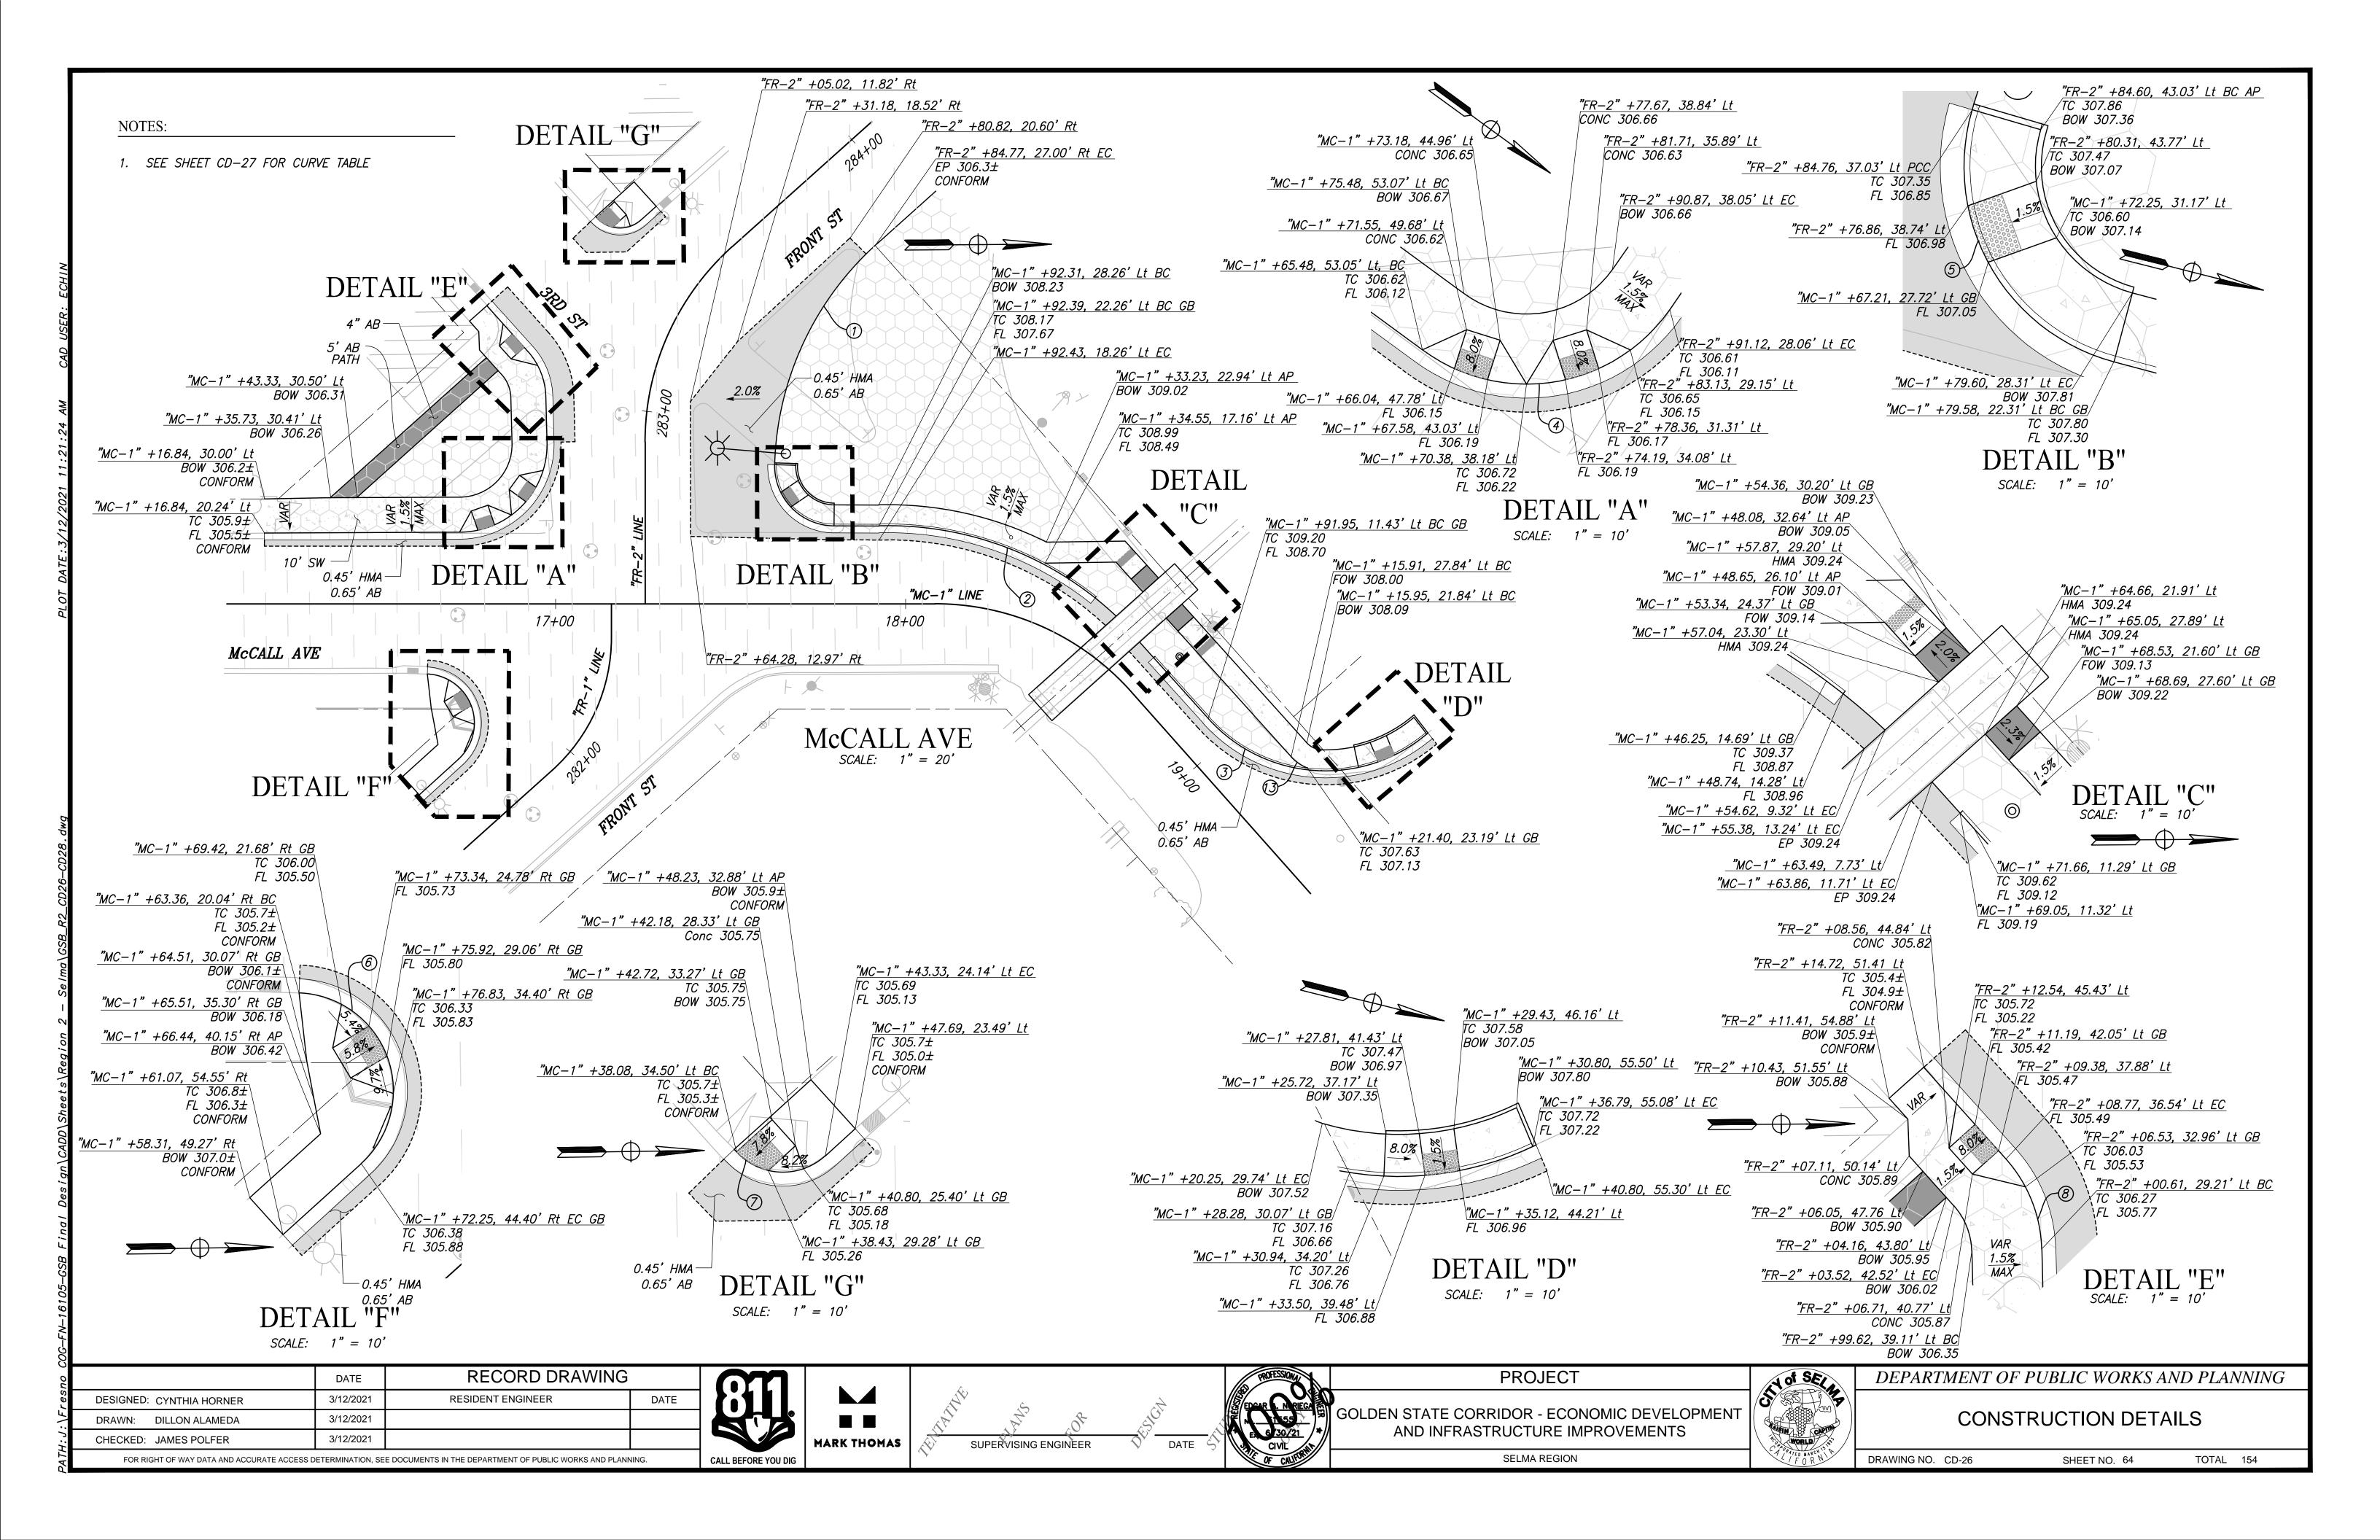

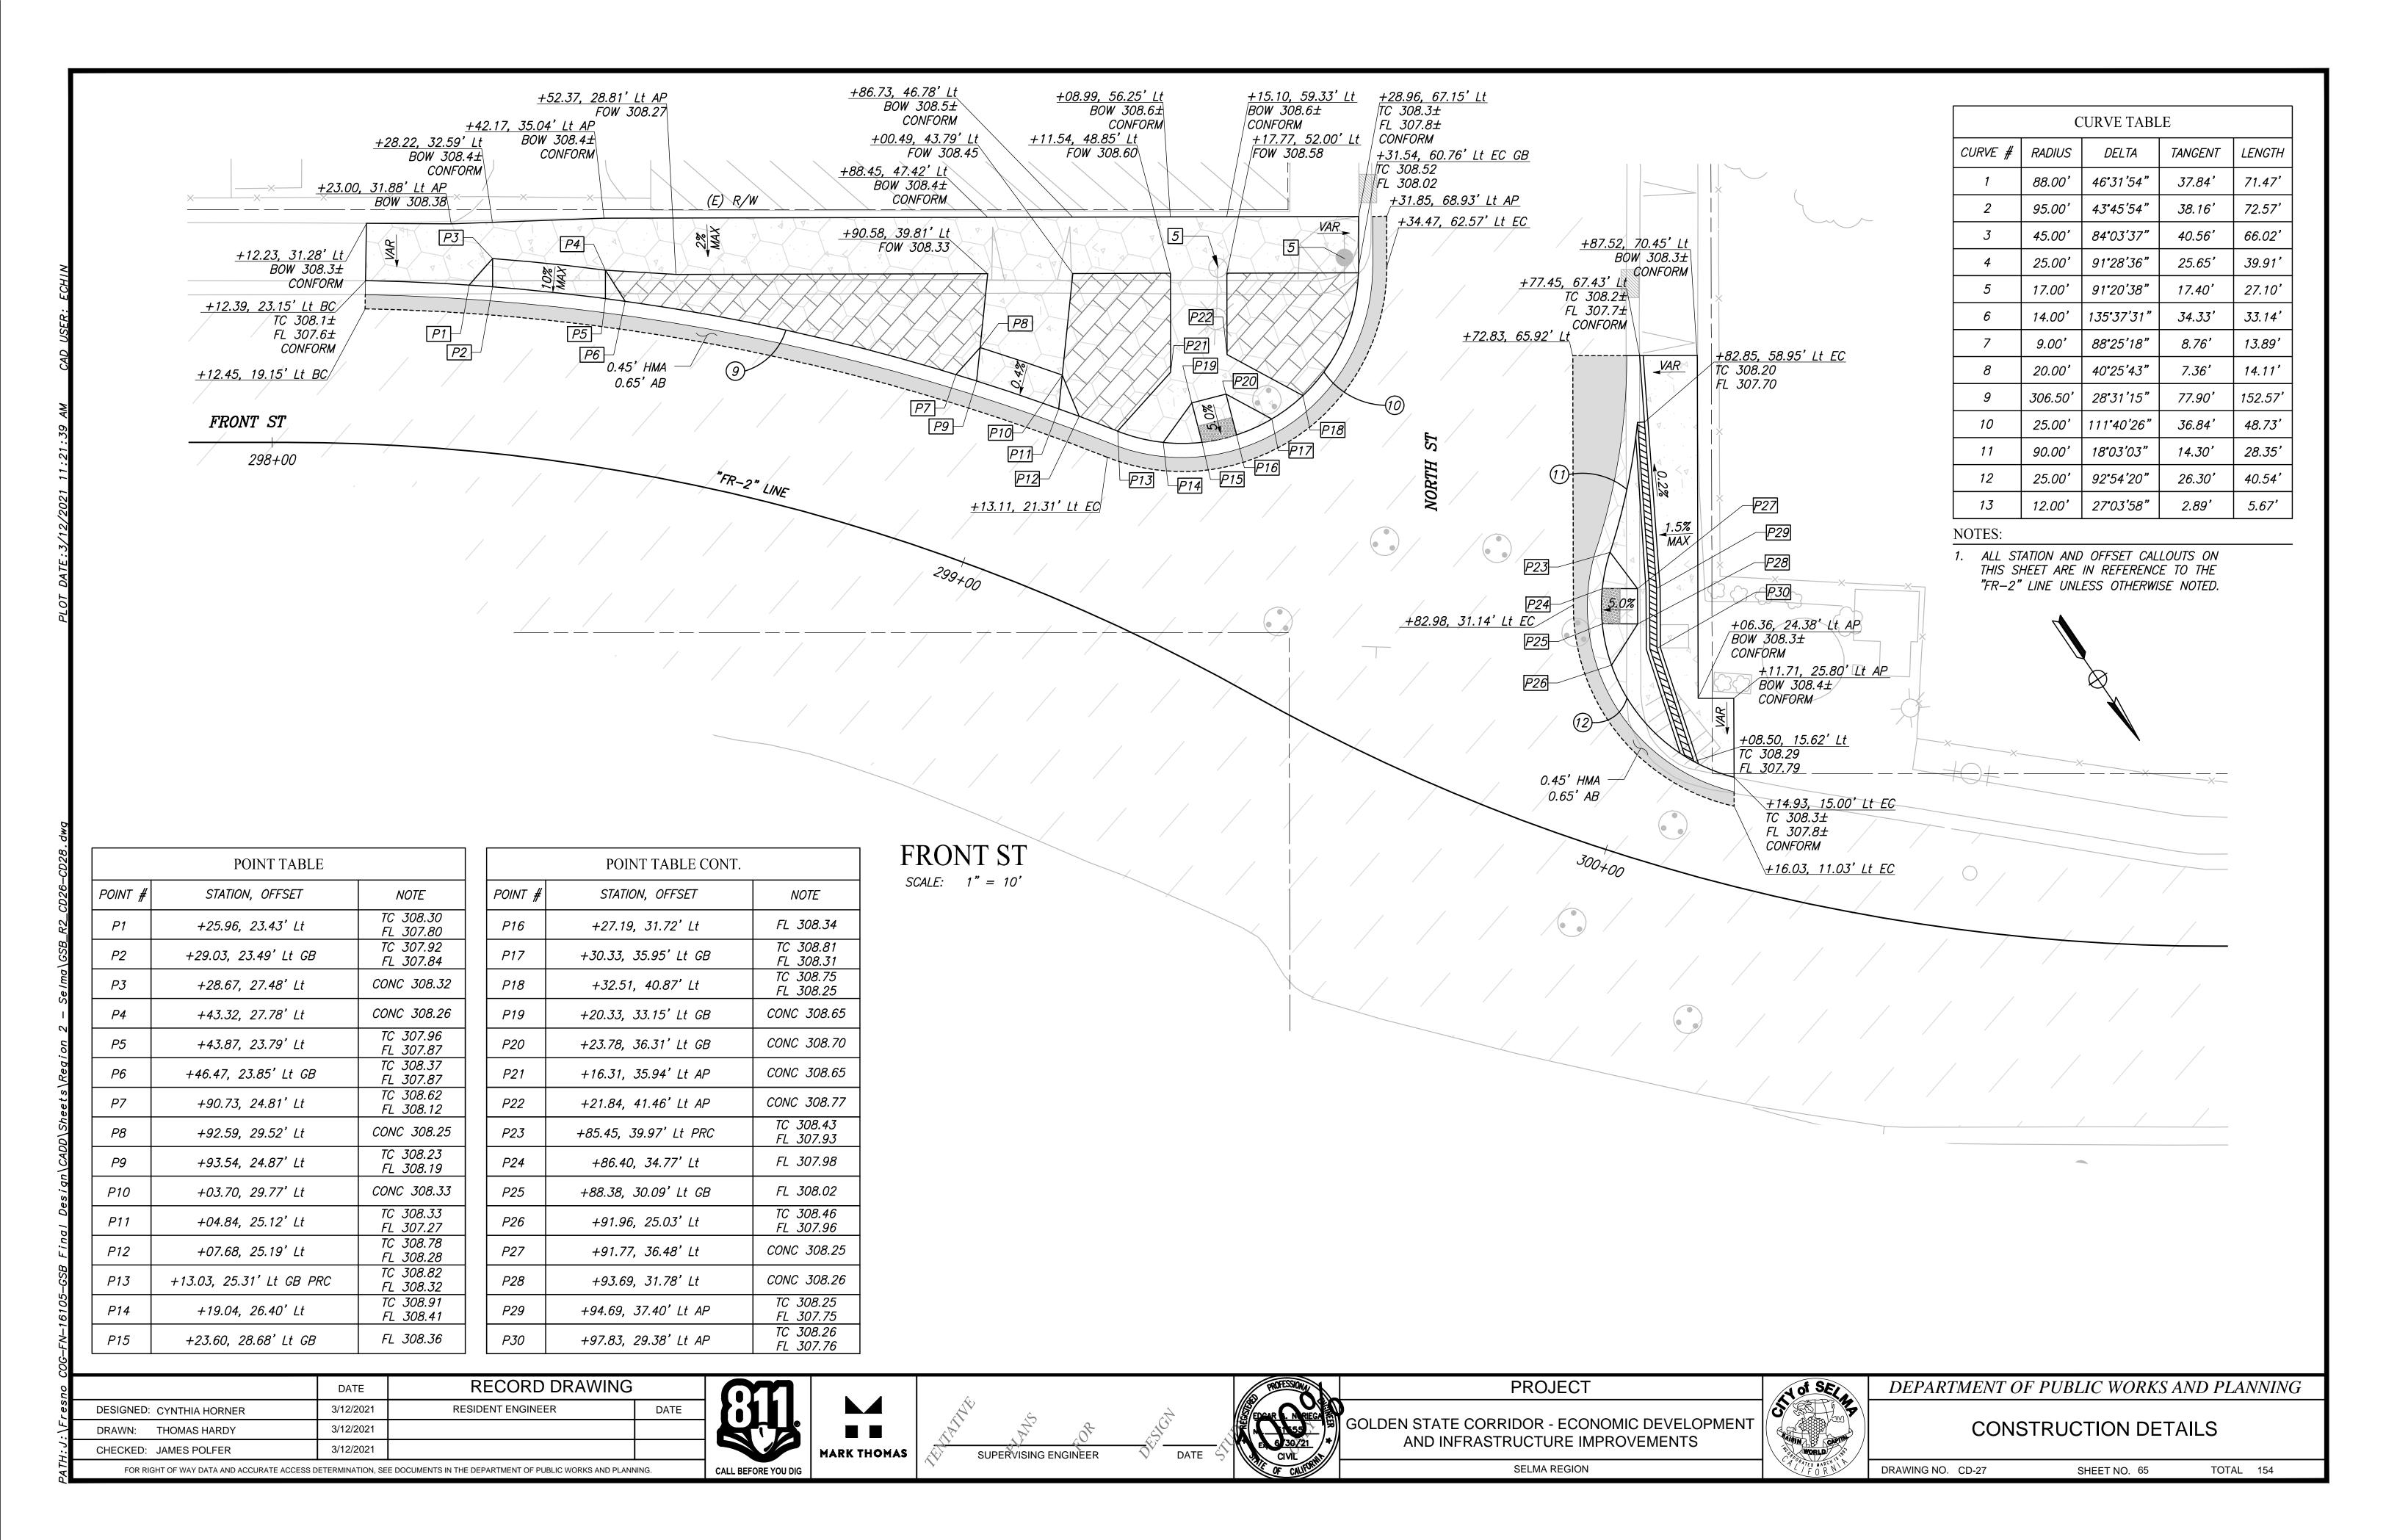

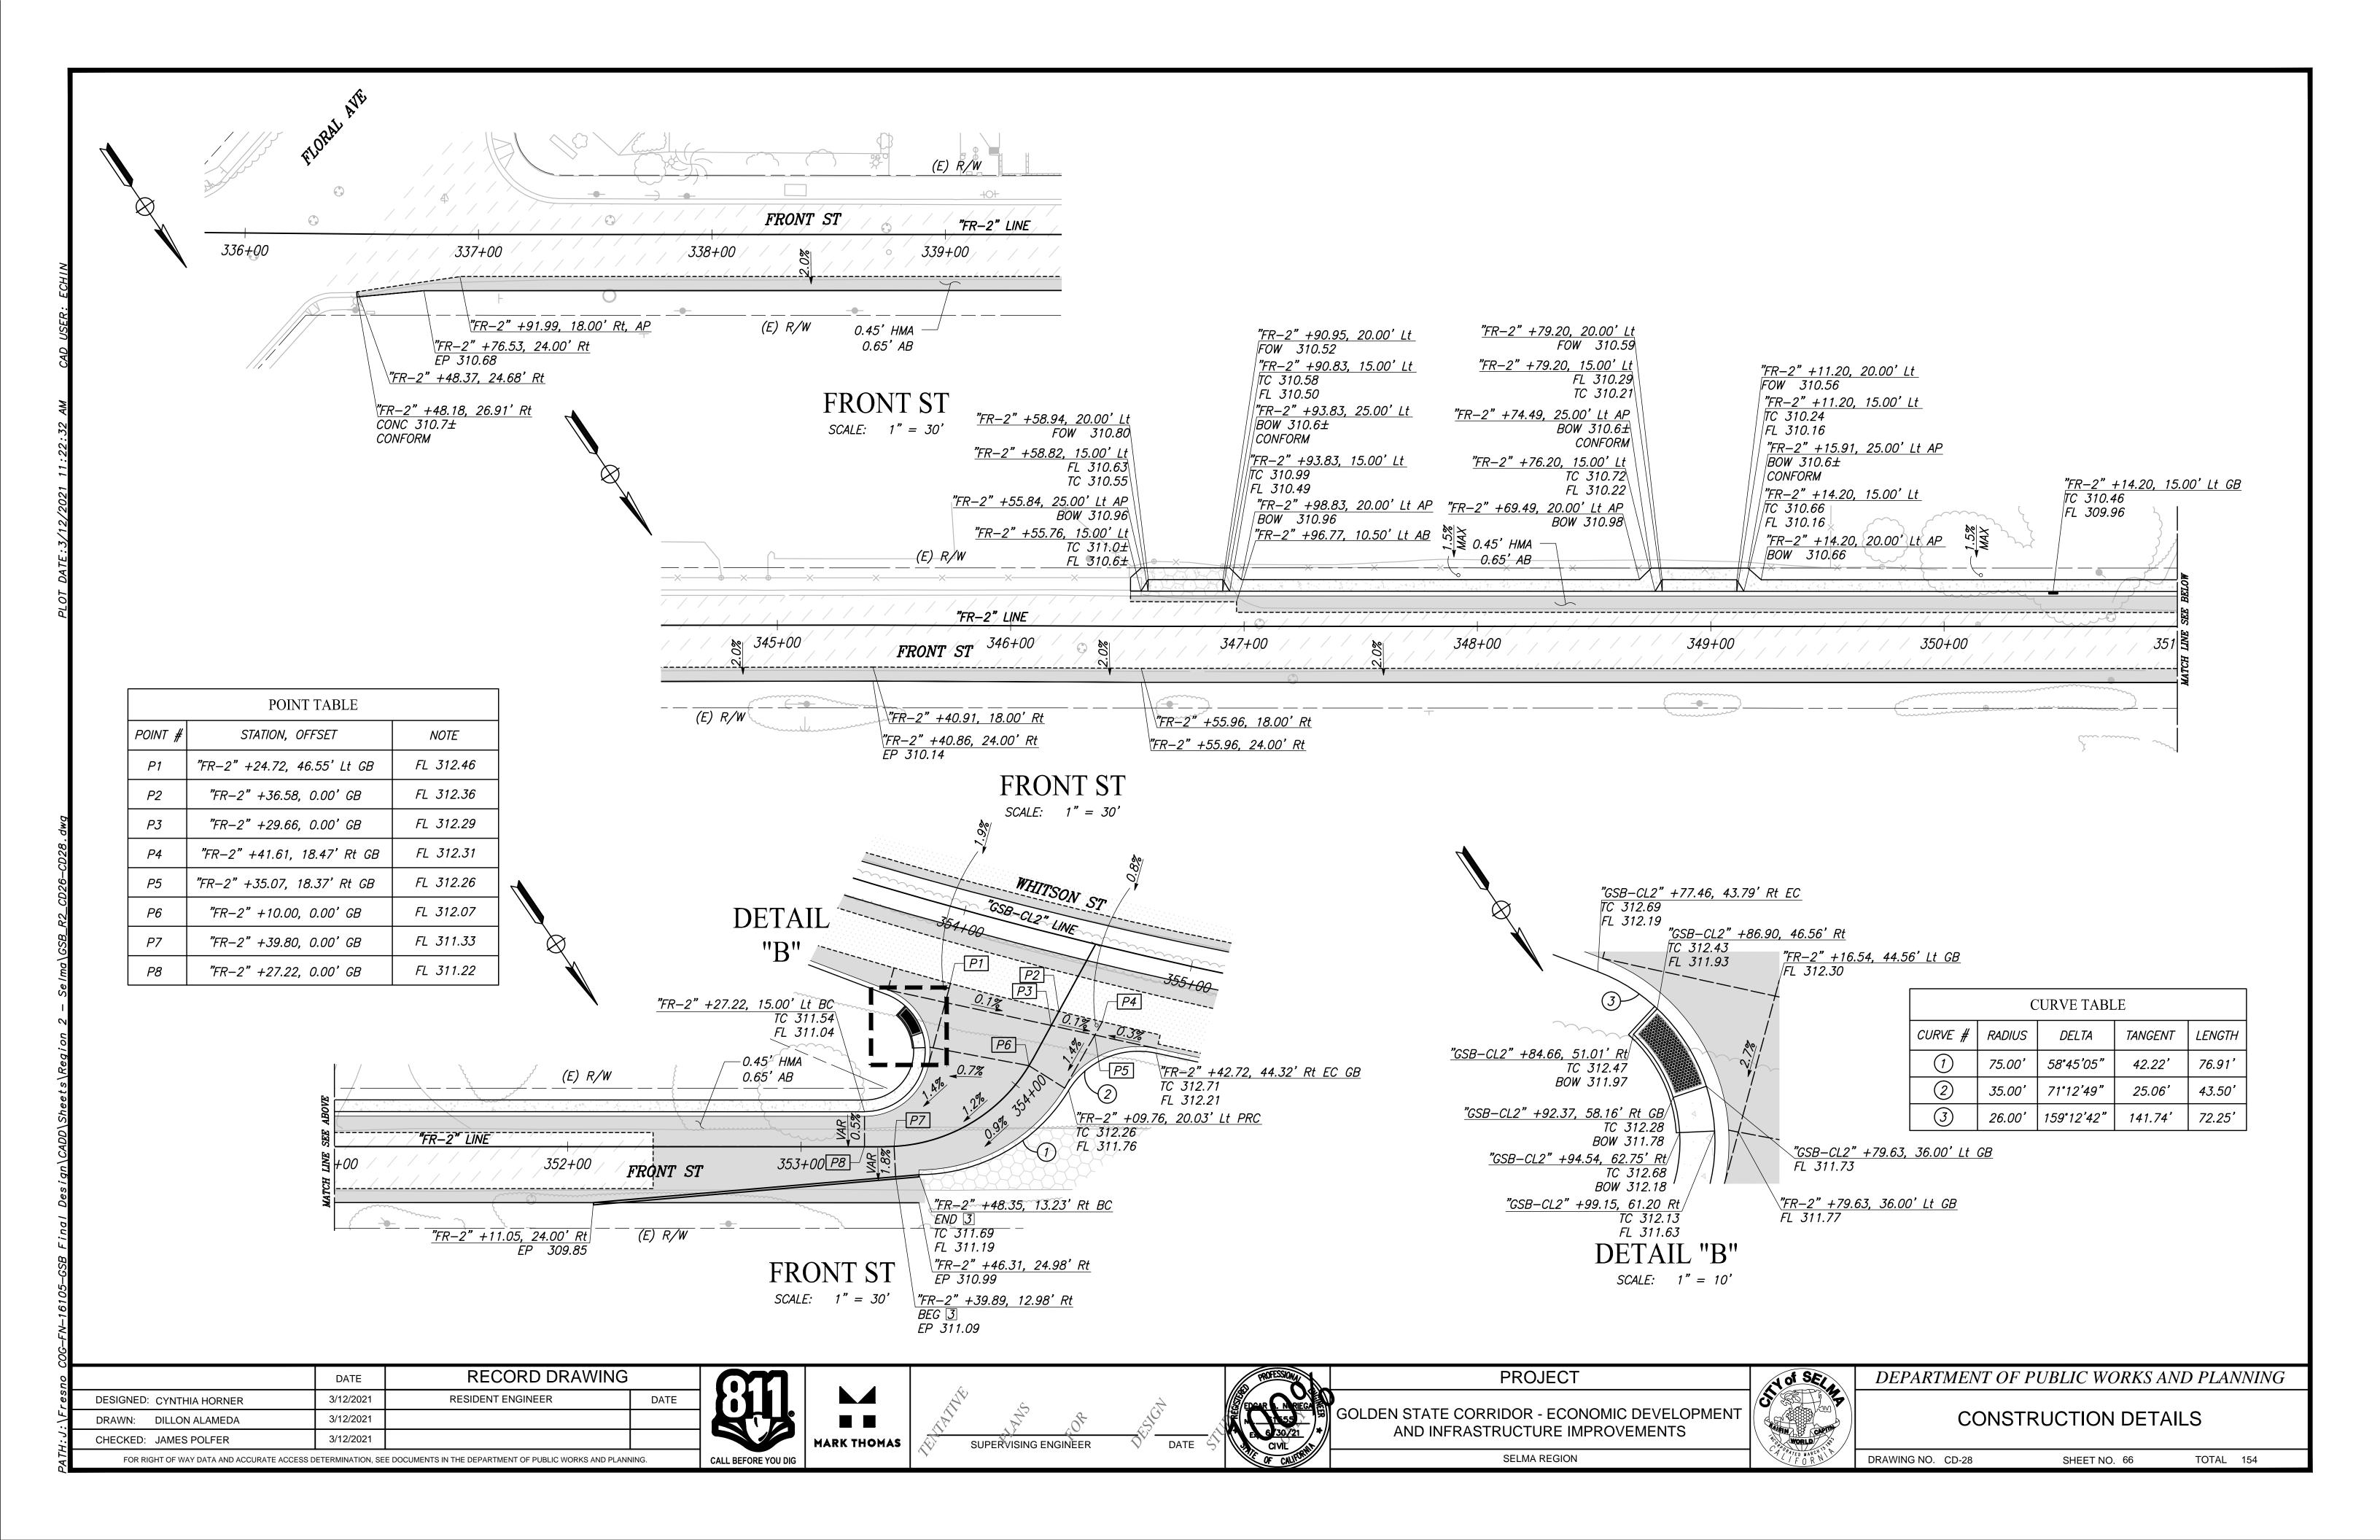


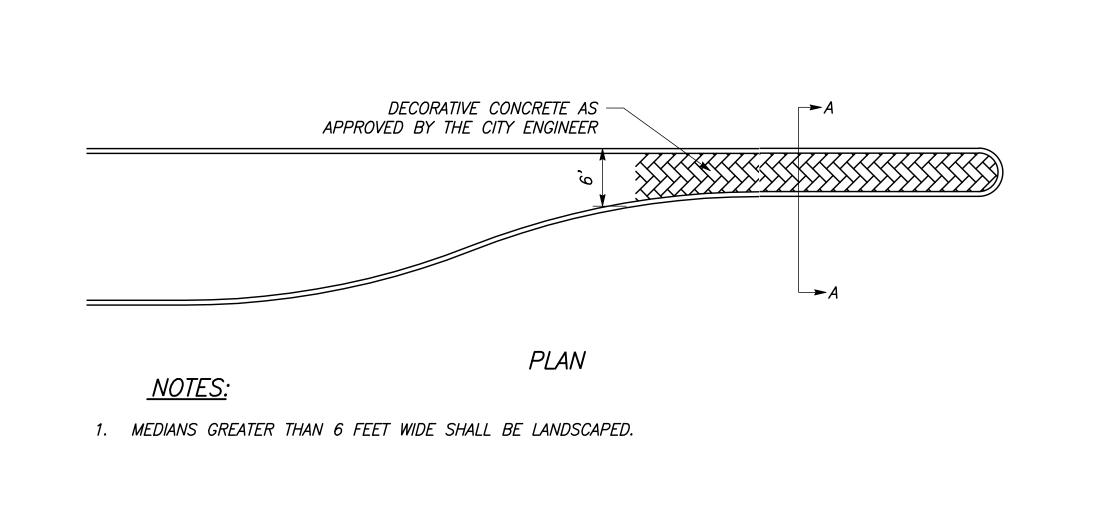


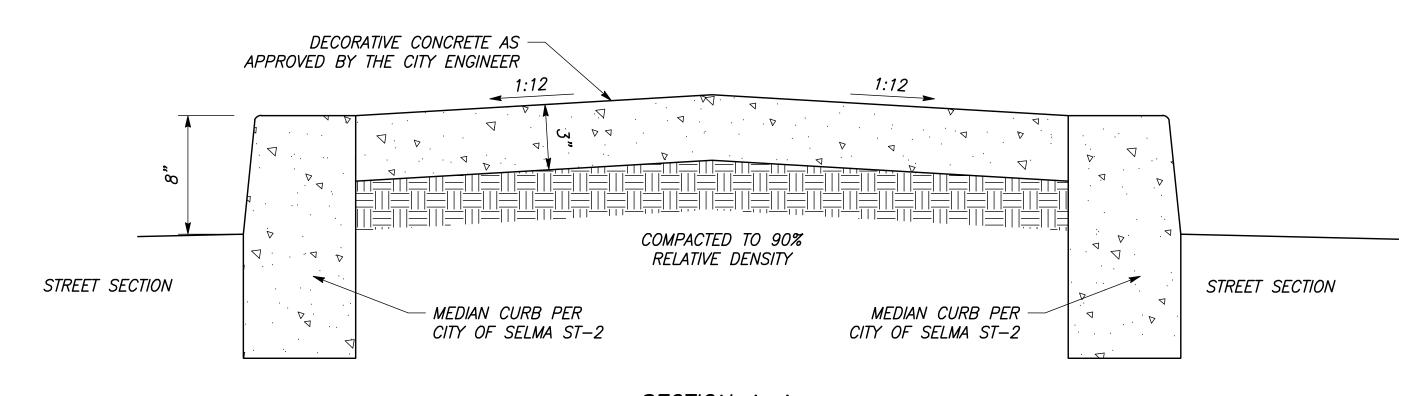


SECTION A-A


MEDIAN NOSE DETAIL

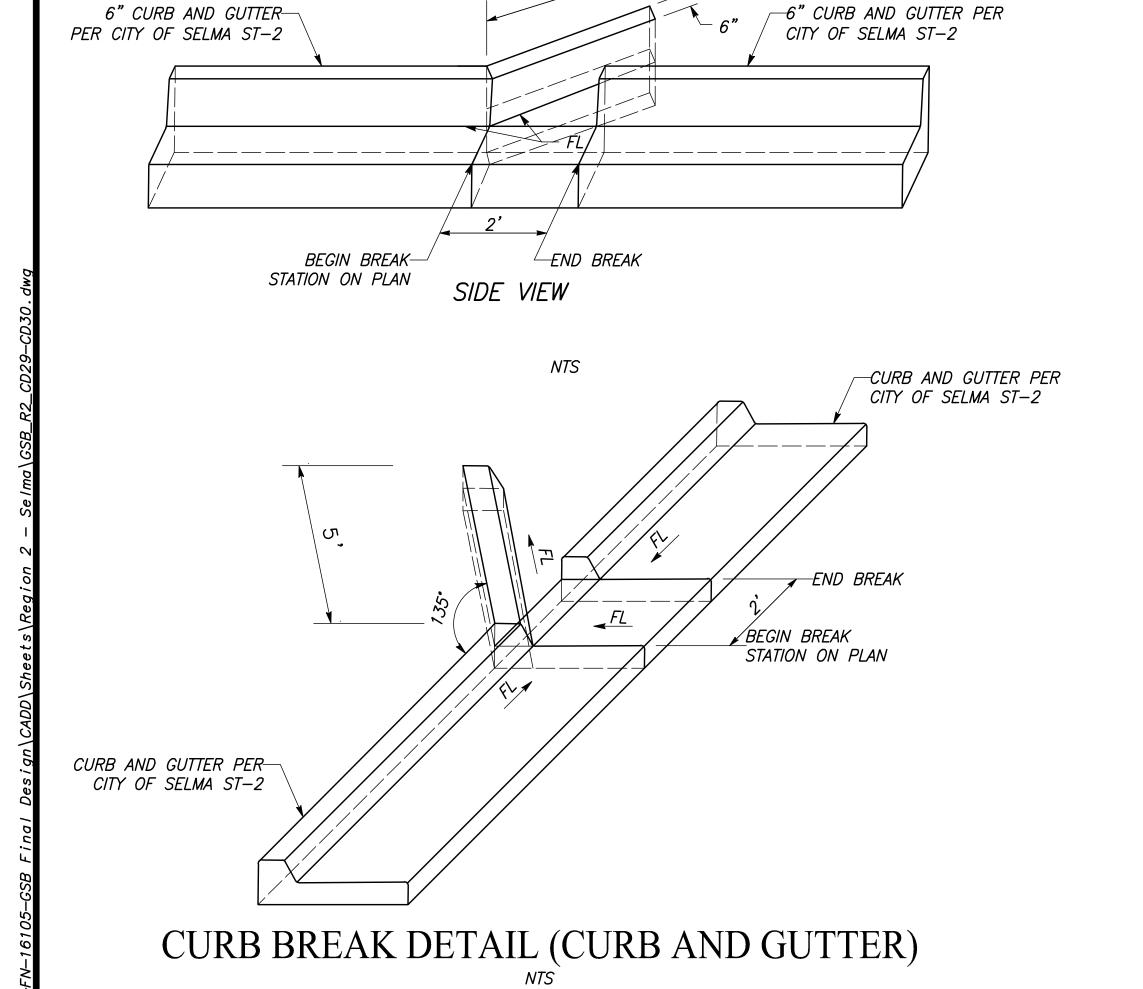

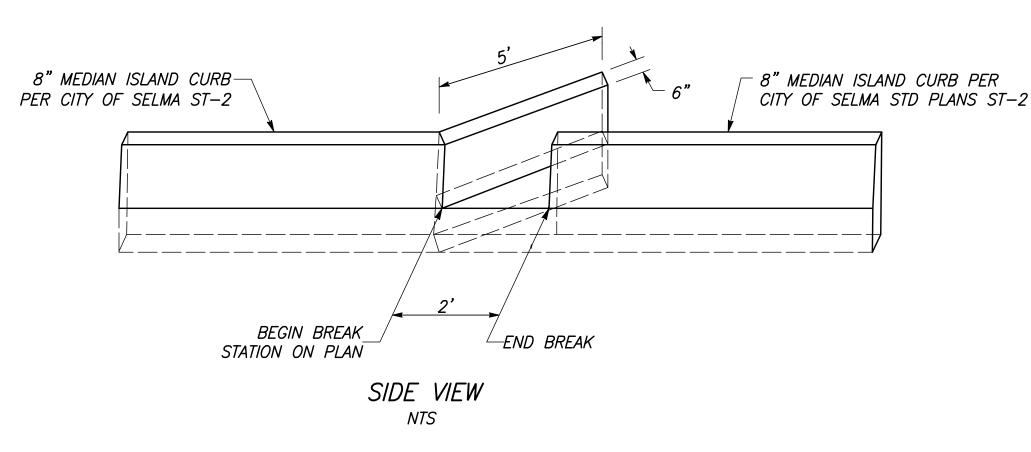

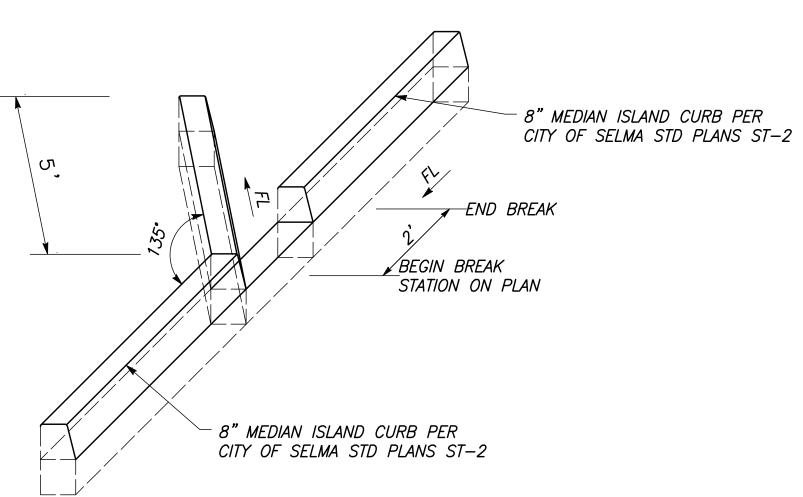

PLAN

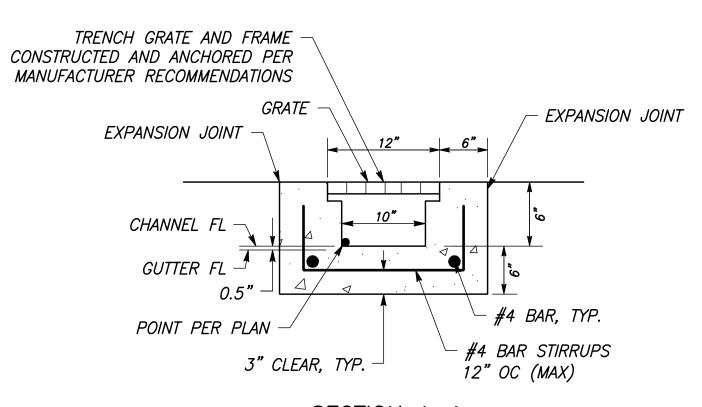

SECTION A-A

NOTES:

- GRATE SHALL BE H20 RATED AND ADA COMPLIANT. . GRATE SHALL BE BOLTED DOWN AND REMOVABLE FOR REPAIR AND CLEANING.
- 3. CLASS "B" CONCRETE, 5 SACK MIN MIX, 2500 PSI MIN @ 28 DAYS.
- 4. GRATE OPENING SHALL NOT EXCEED 1/2"


CHANNEL THROUGH WALK DRAIN DETAIL


8" MEDIAN CURB BREAK DETAIL

	DATE	RECORD DRAWING			
DESIGNED: CYNTHIA HORNER	3/12/2021	RESIDENT ENGINEER	DATE		
DRAWN: CYNTHIA HORNER	3/12/2021				
CHECKED: JAMES POLFER	3/12/2021				
FOR RIGHT OF WAY DATA AND ACCURATE ACCESS DETERMINATION, SEE DOCUMENTS IN THE DEPARTMENT OF RURI IC WORKS AND READINING					





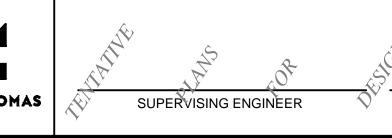

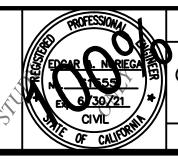

GOLDEN STATE CORRIDOR - ECONOMIC DEVELOPMENT AND INFRASTRUCTURE IMPROVEMENTS


SELMA REGION


PROJECT


DEPARTMENT OF PUBLIC WORKS AND PLANNING


CONSTRUCTION DETAILS


DRAWING NO. CD-29 SHEET NO. 67 TOTAL 154

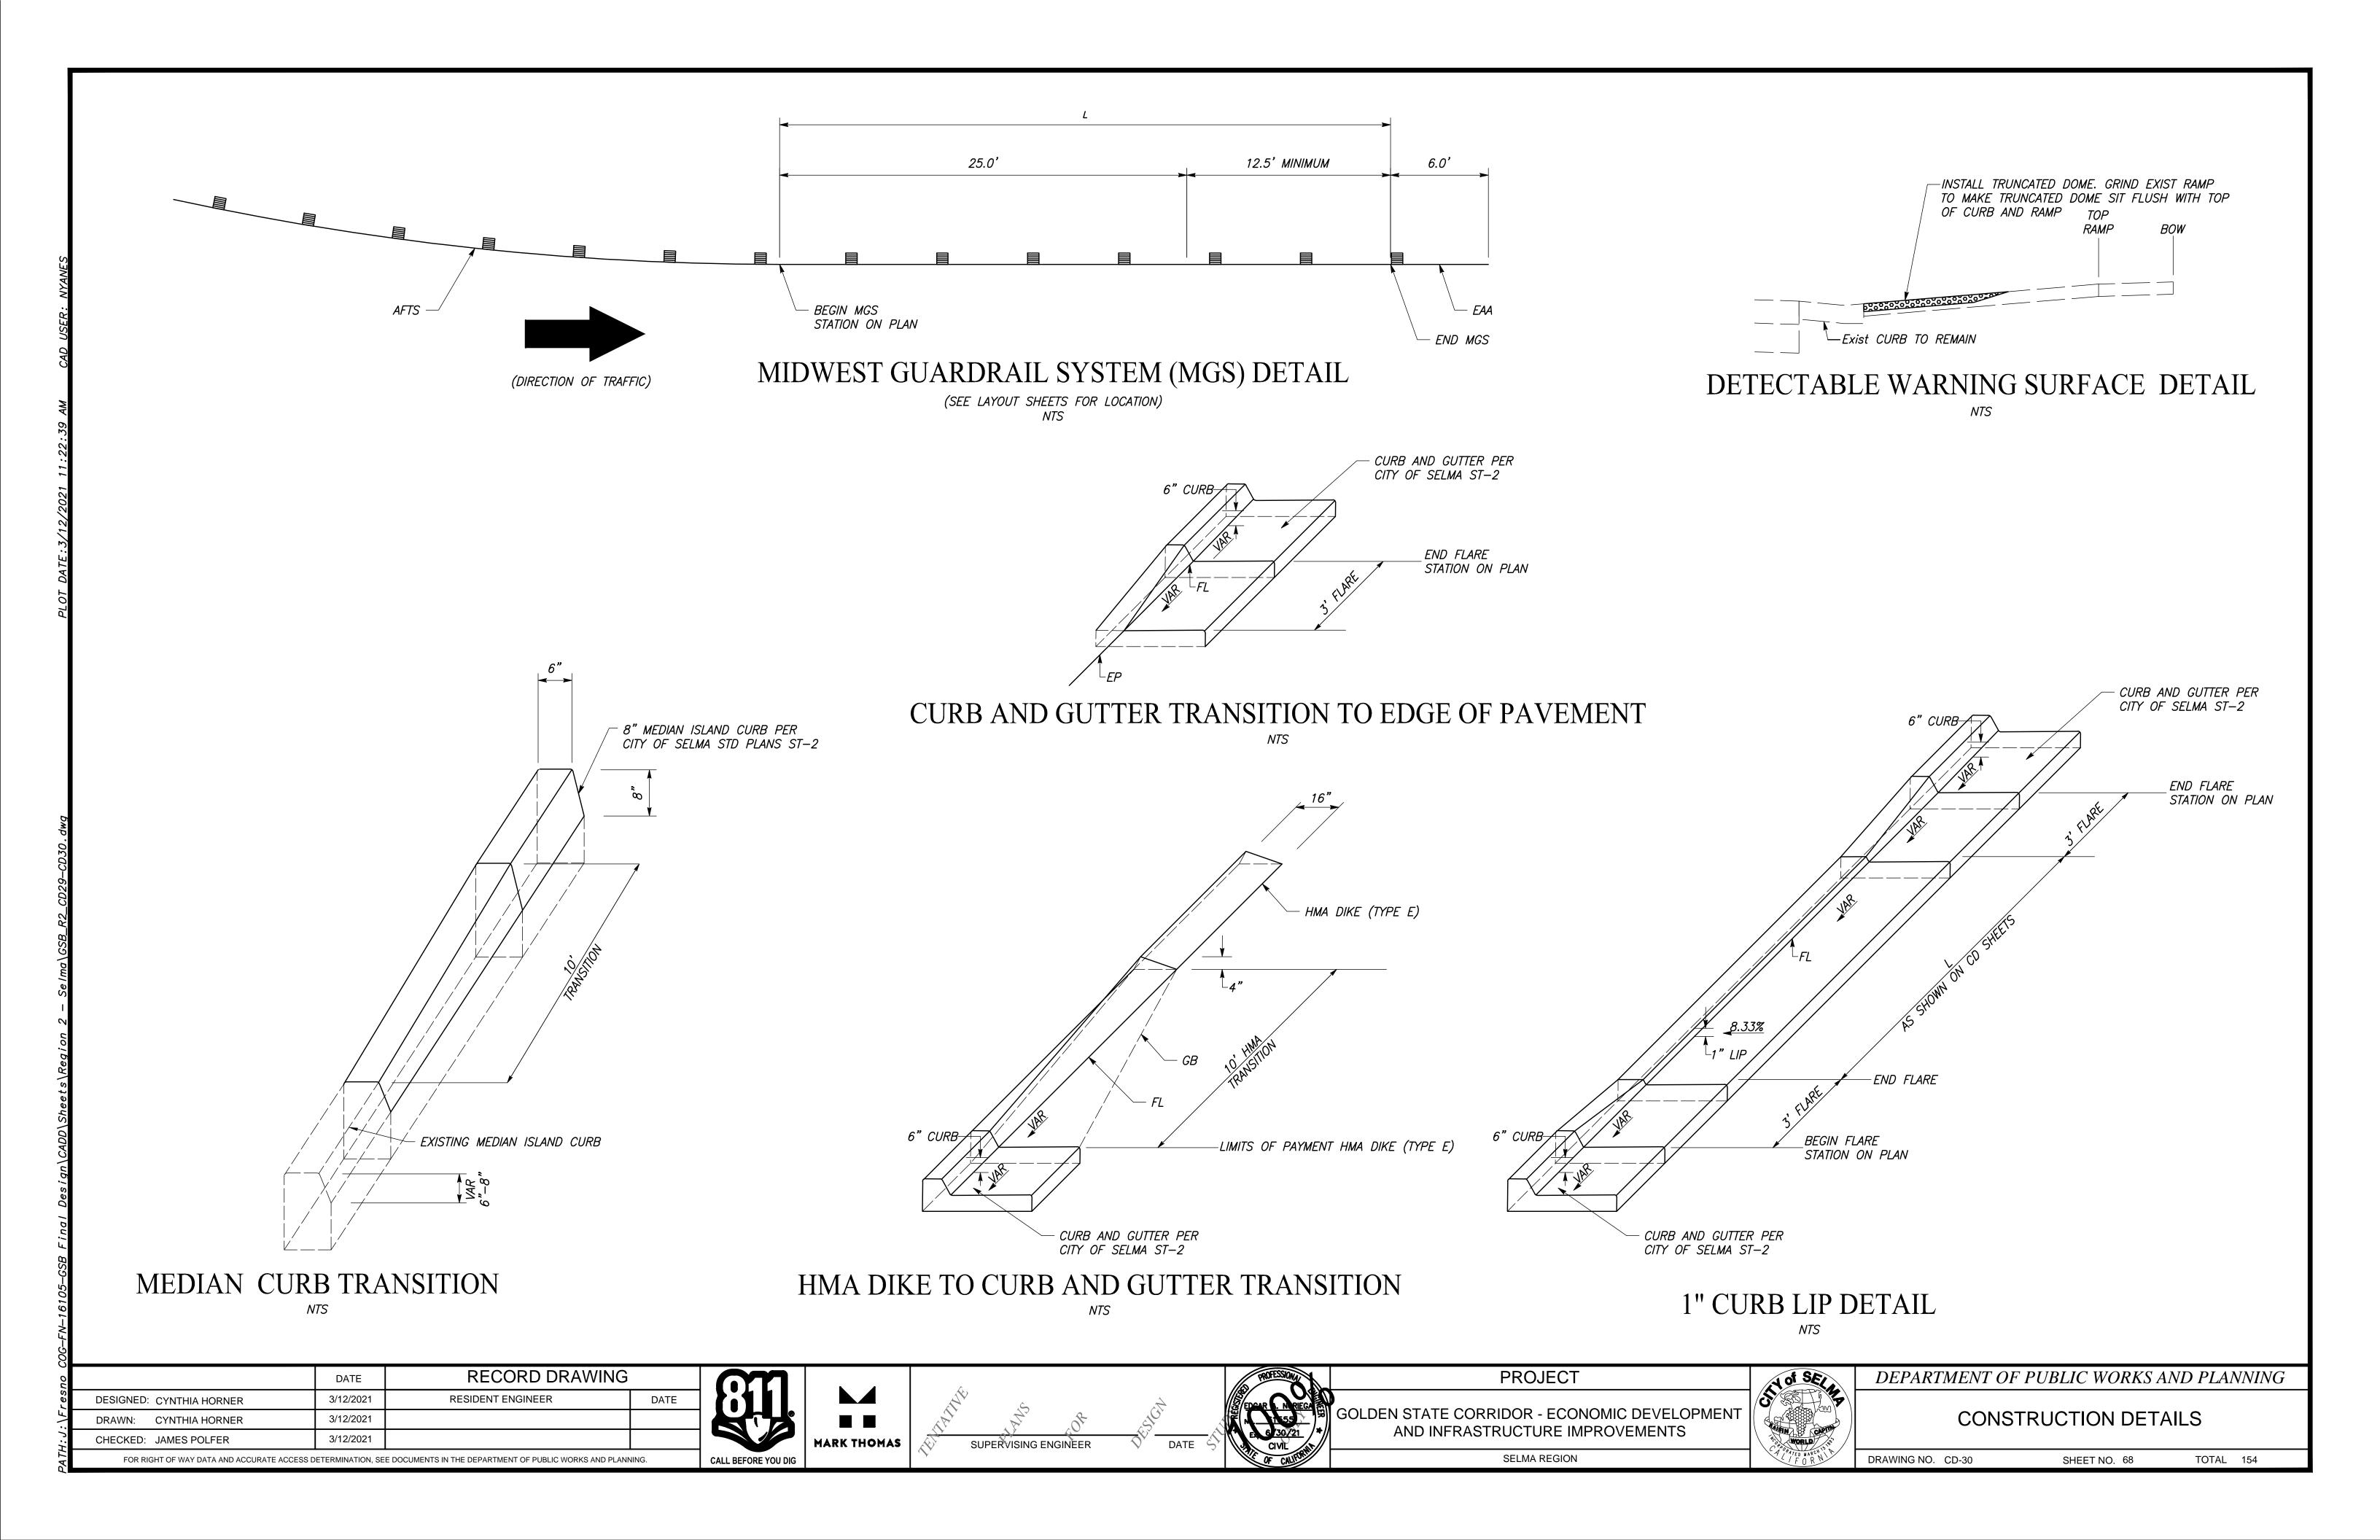


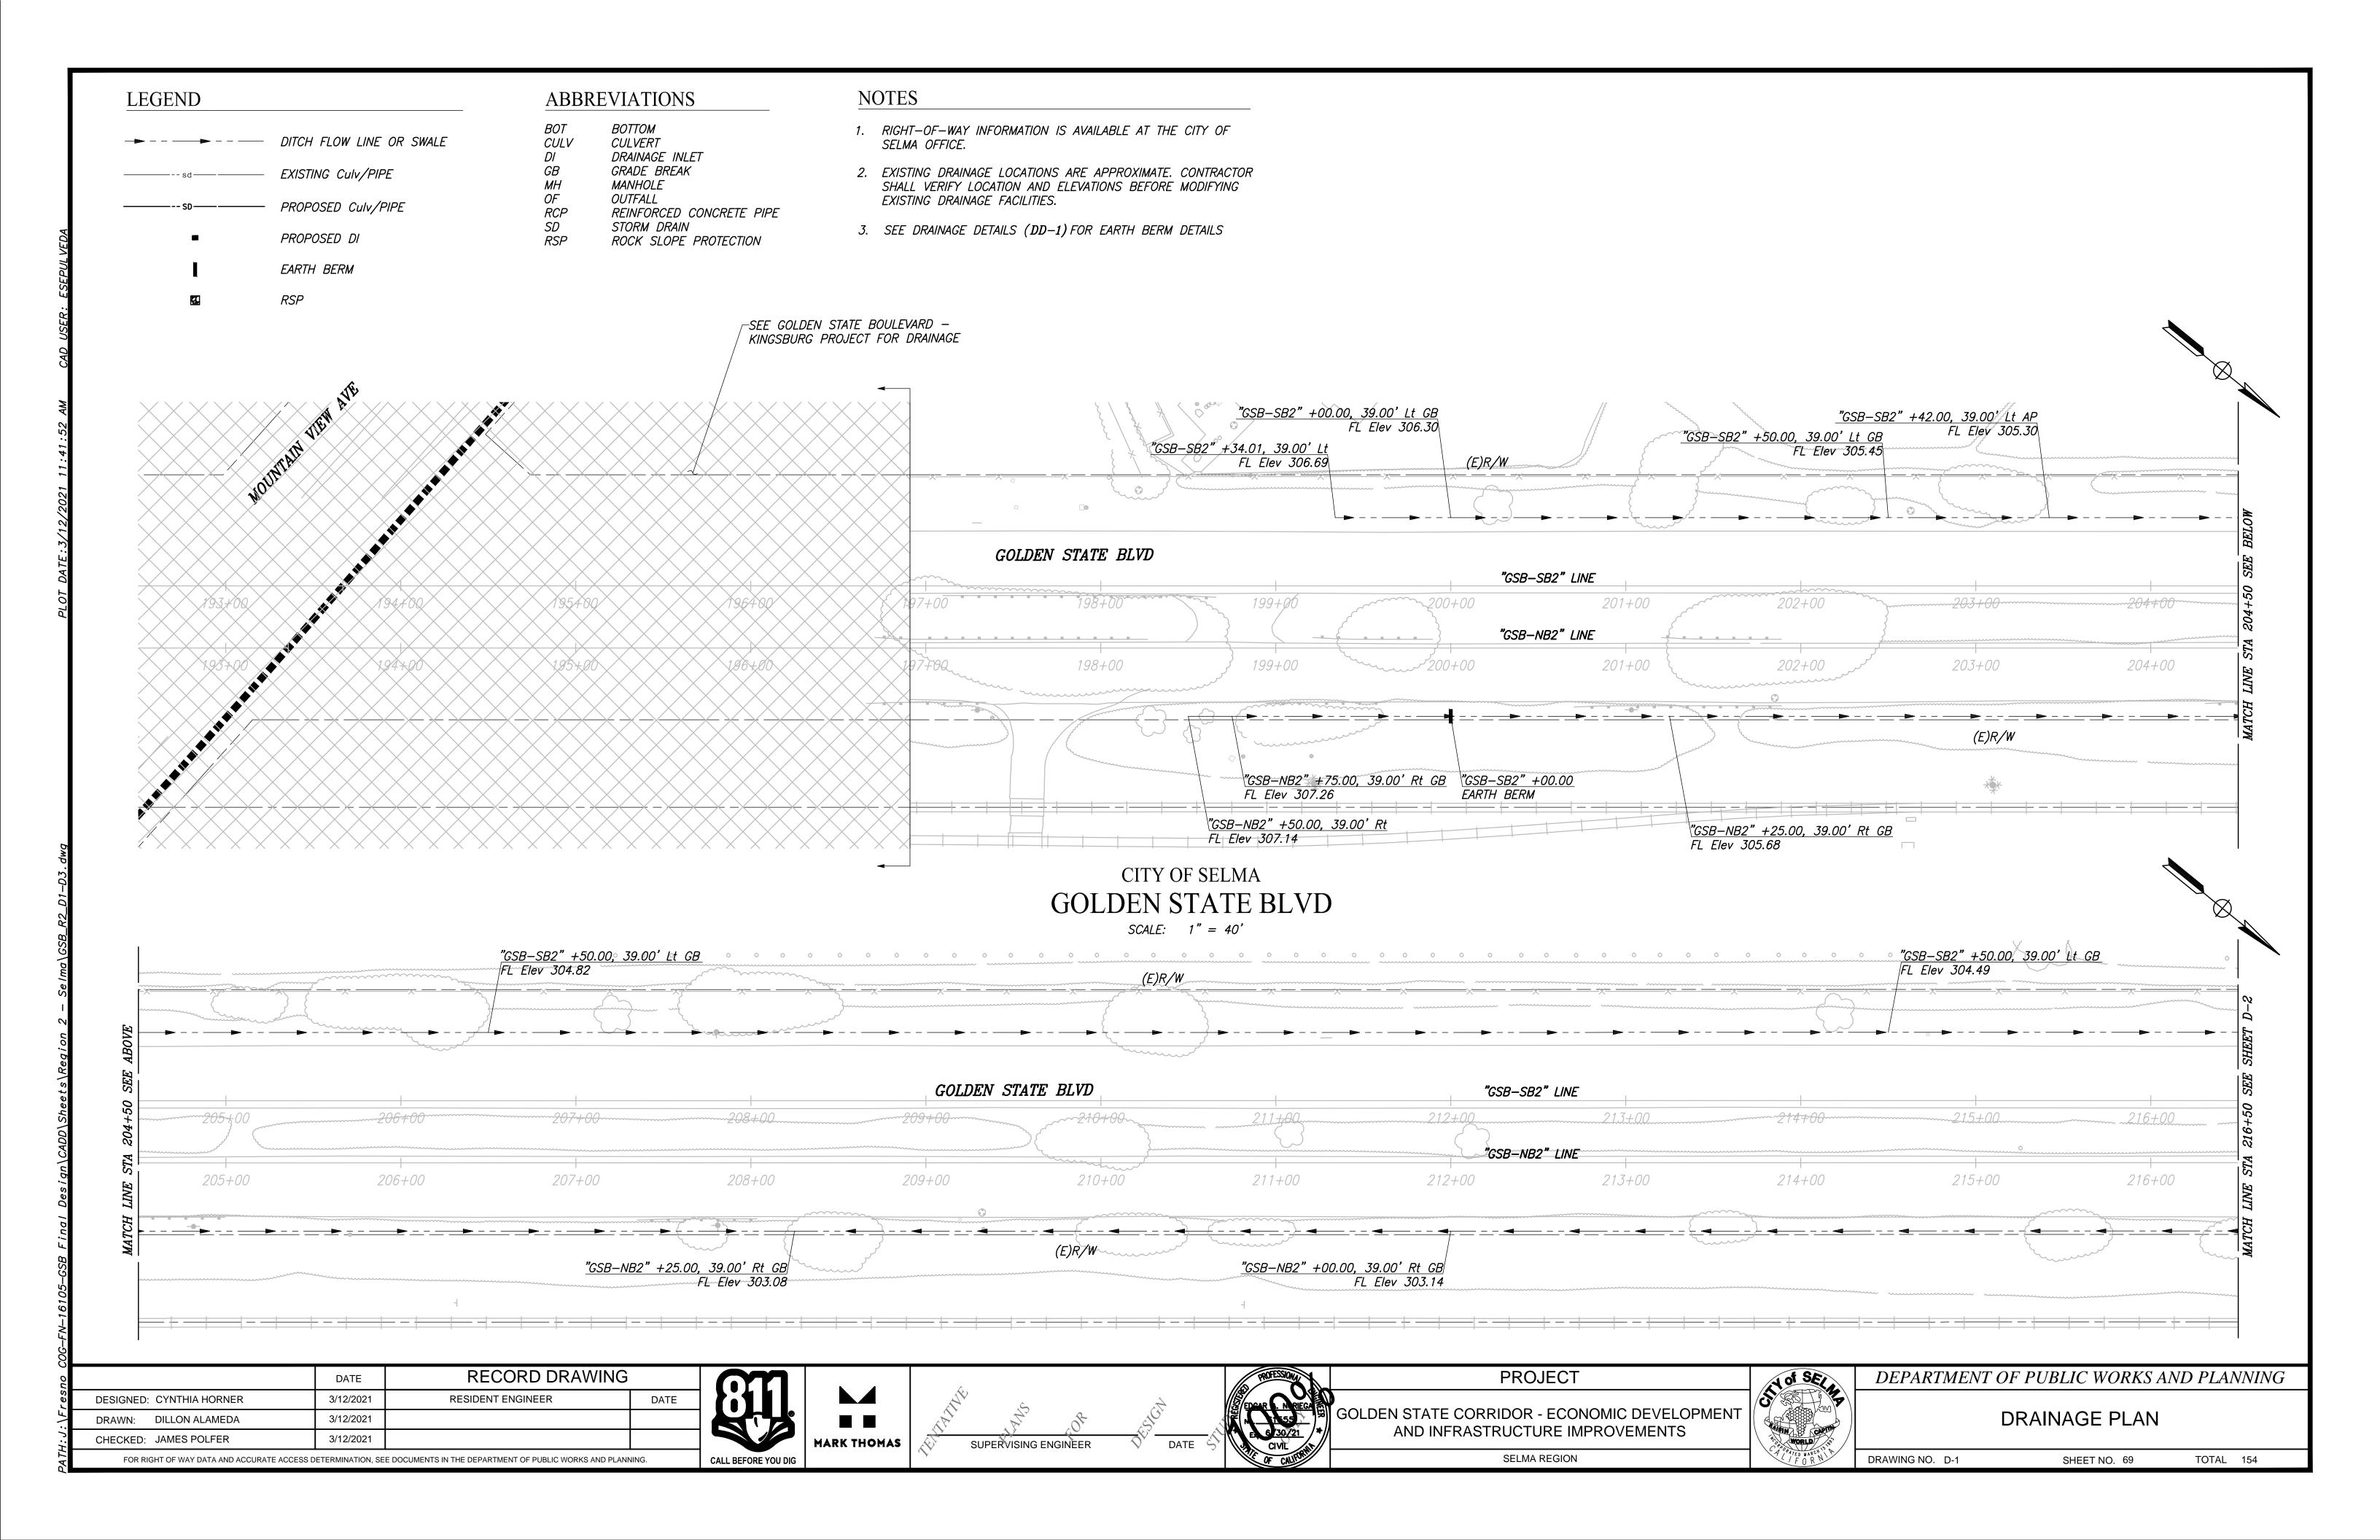


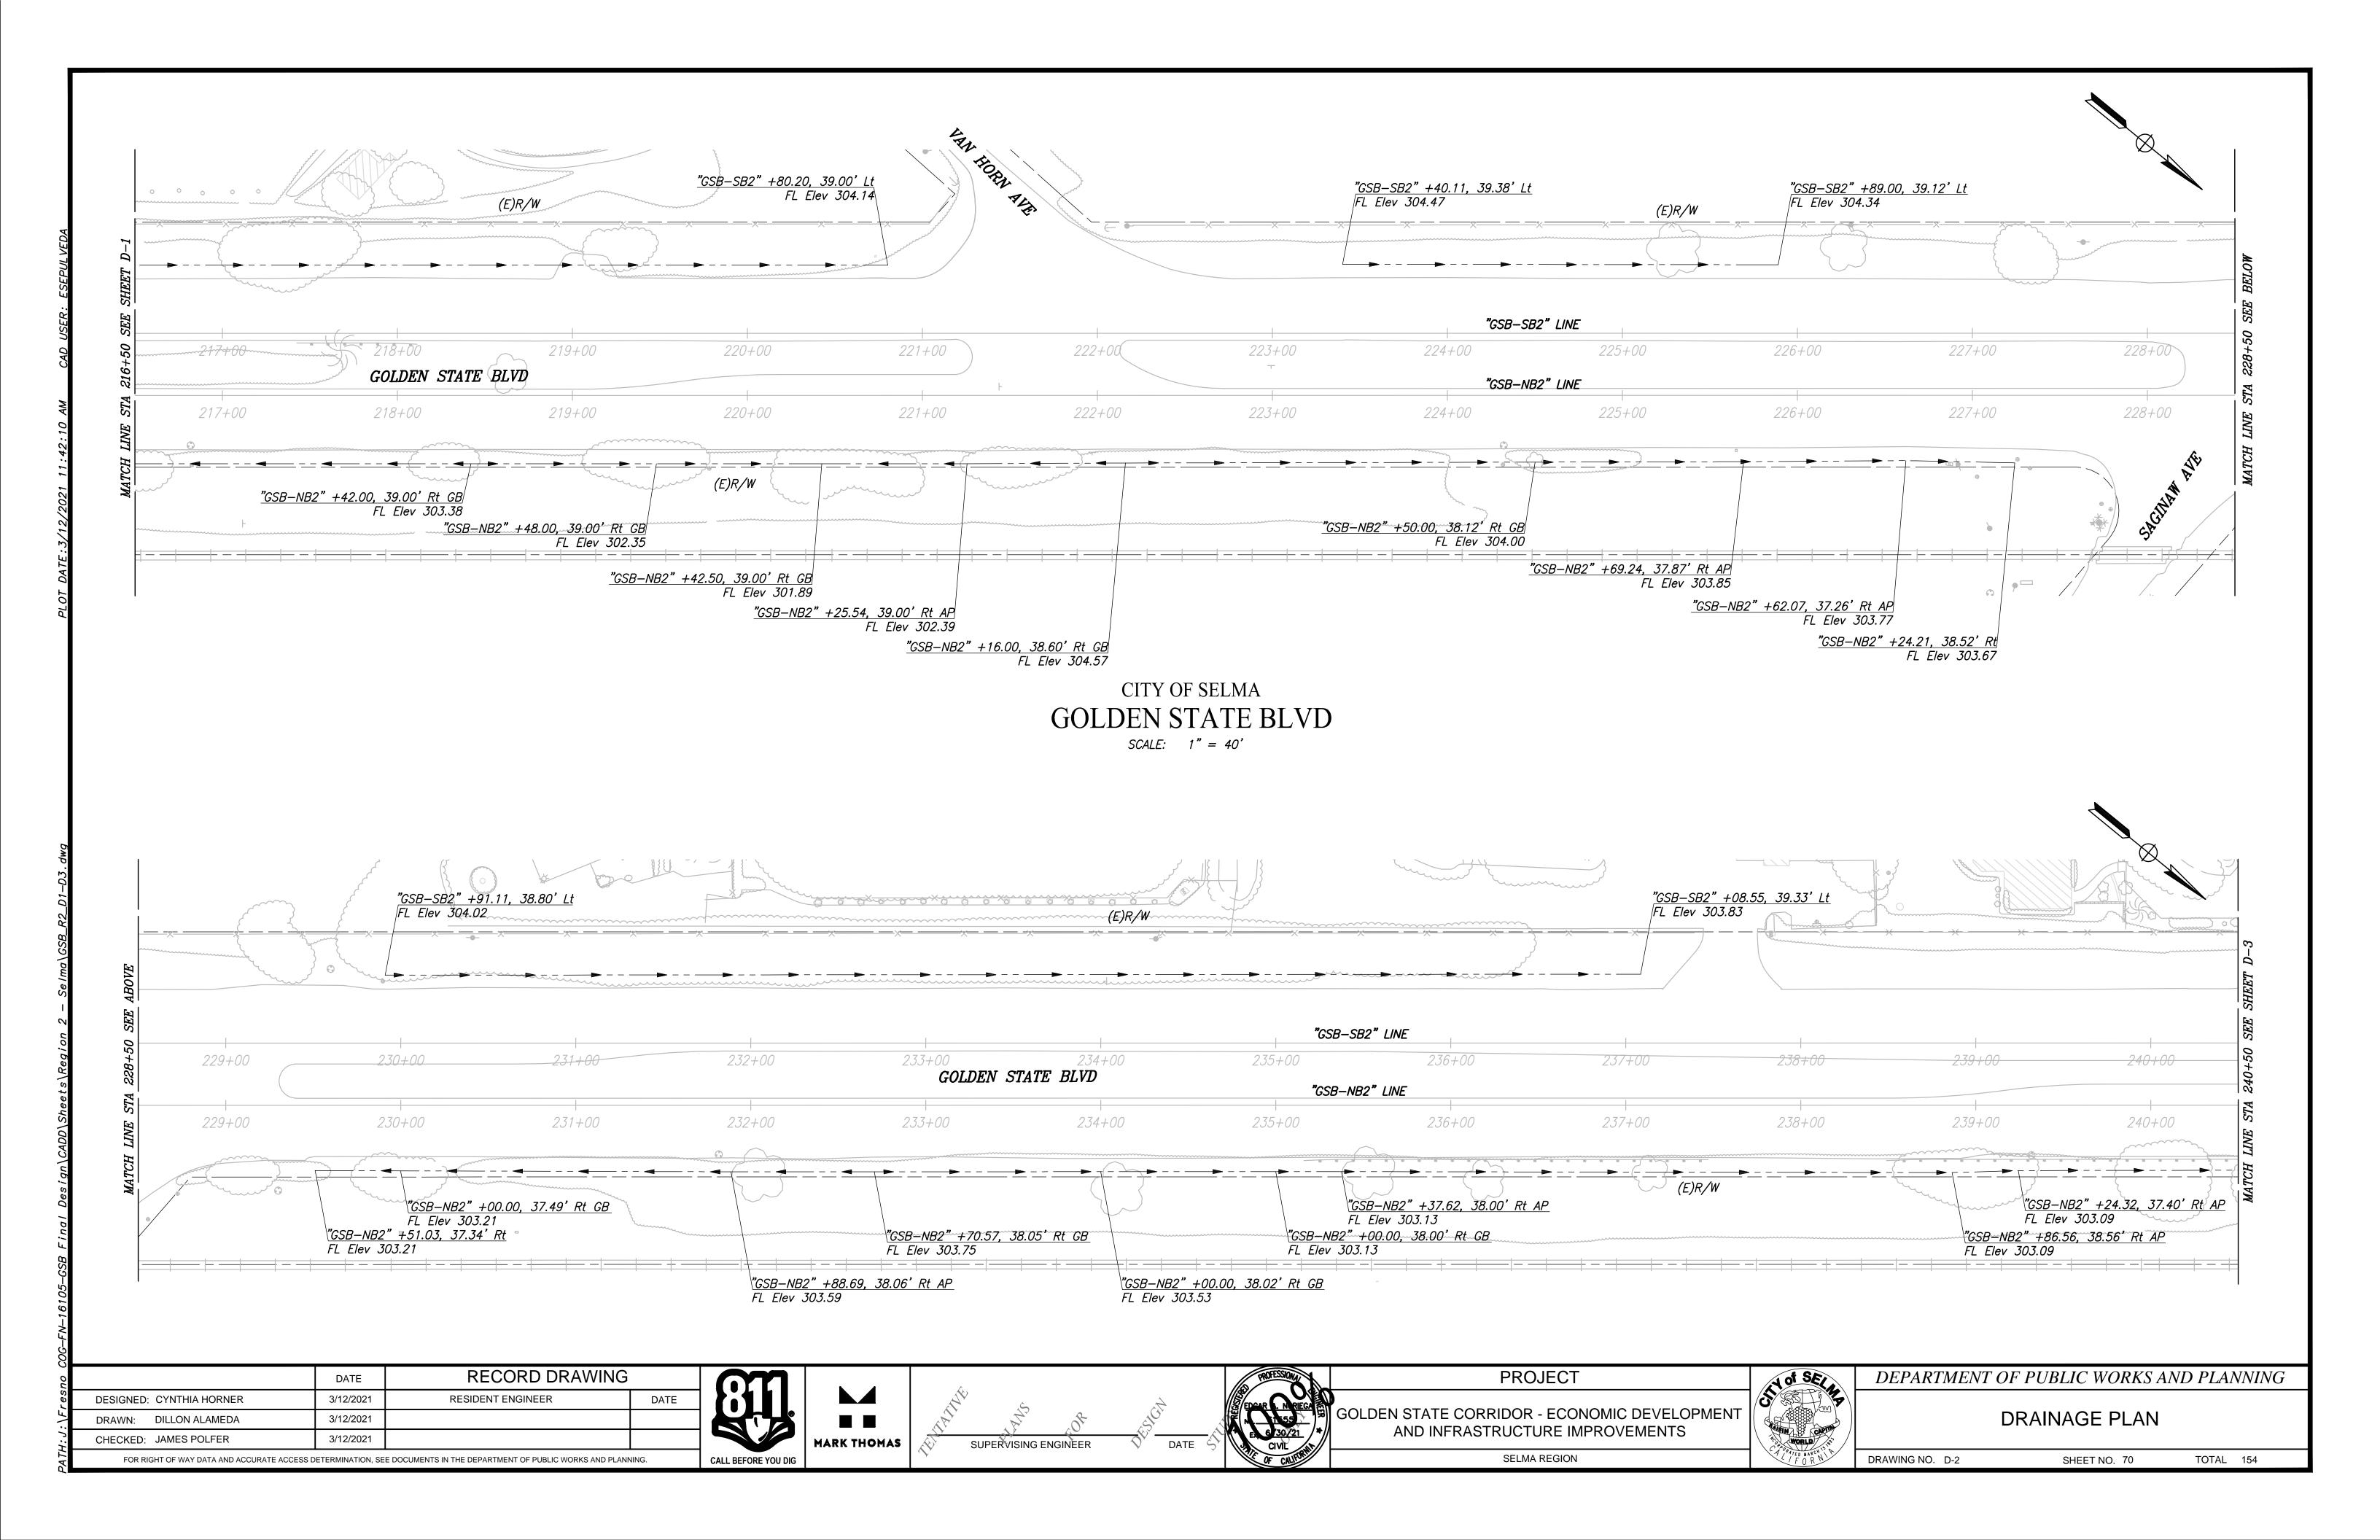


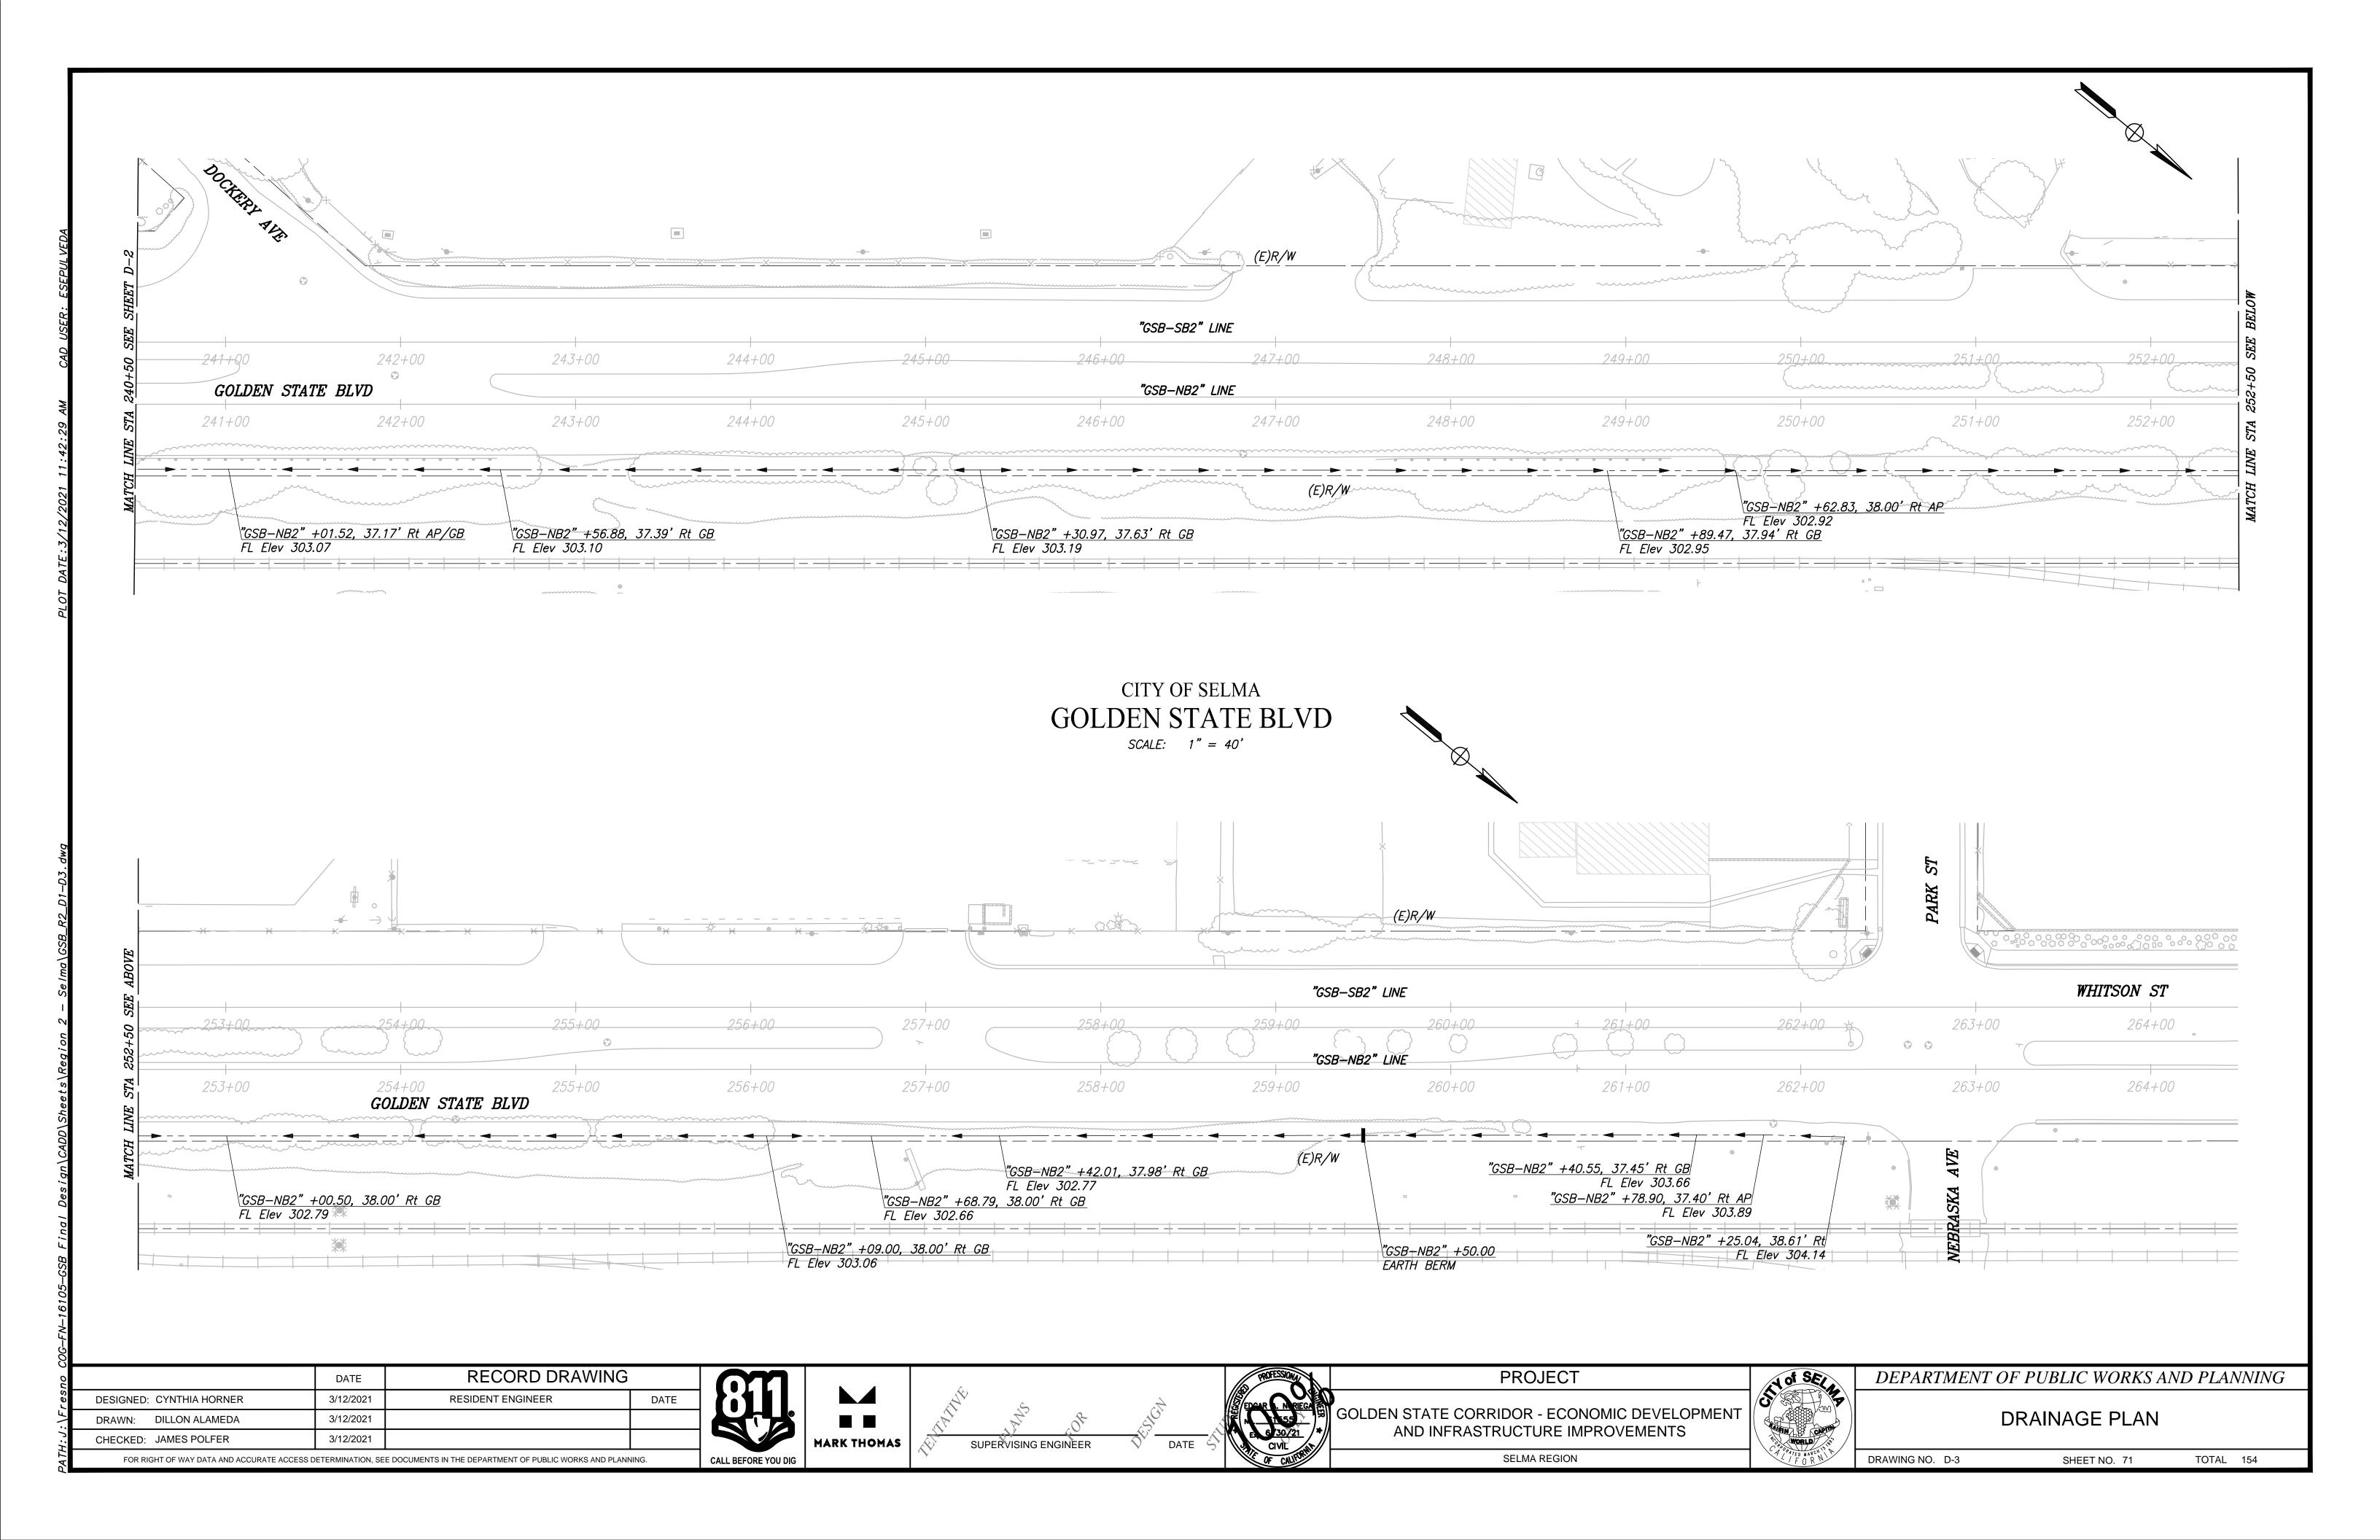


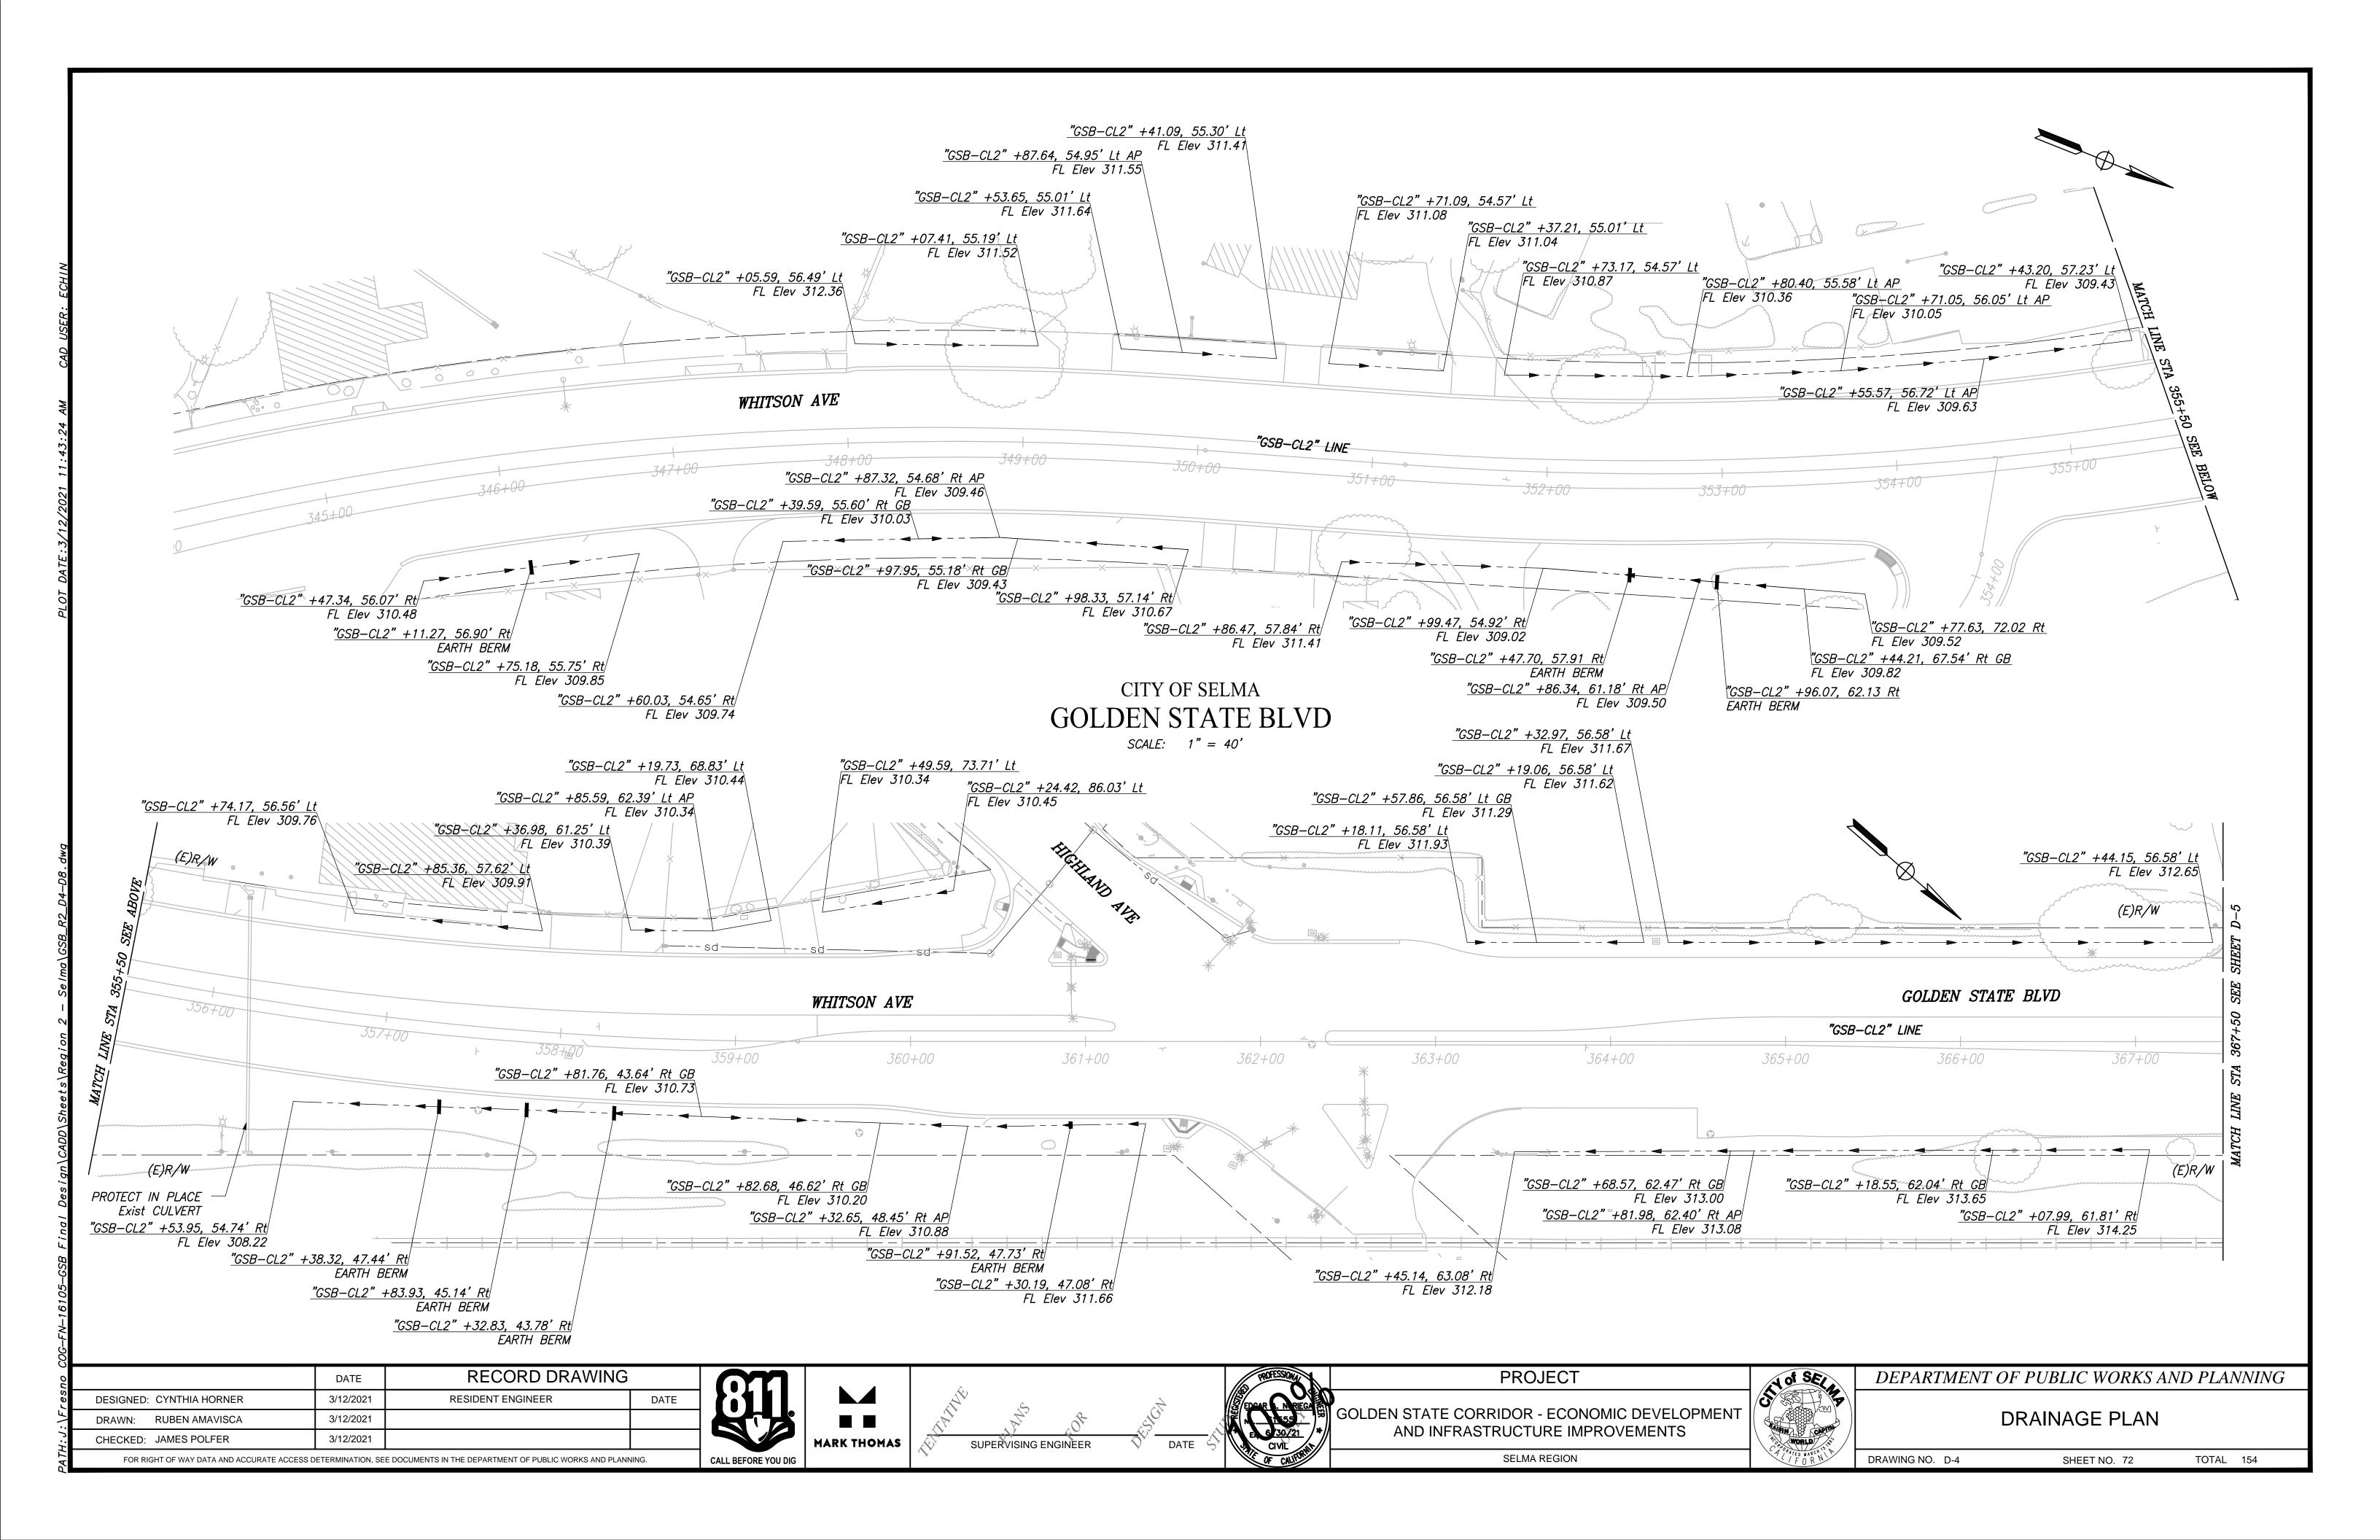

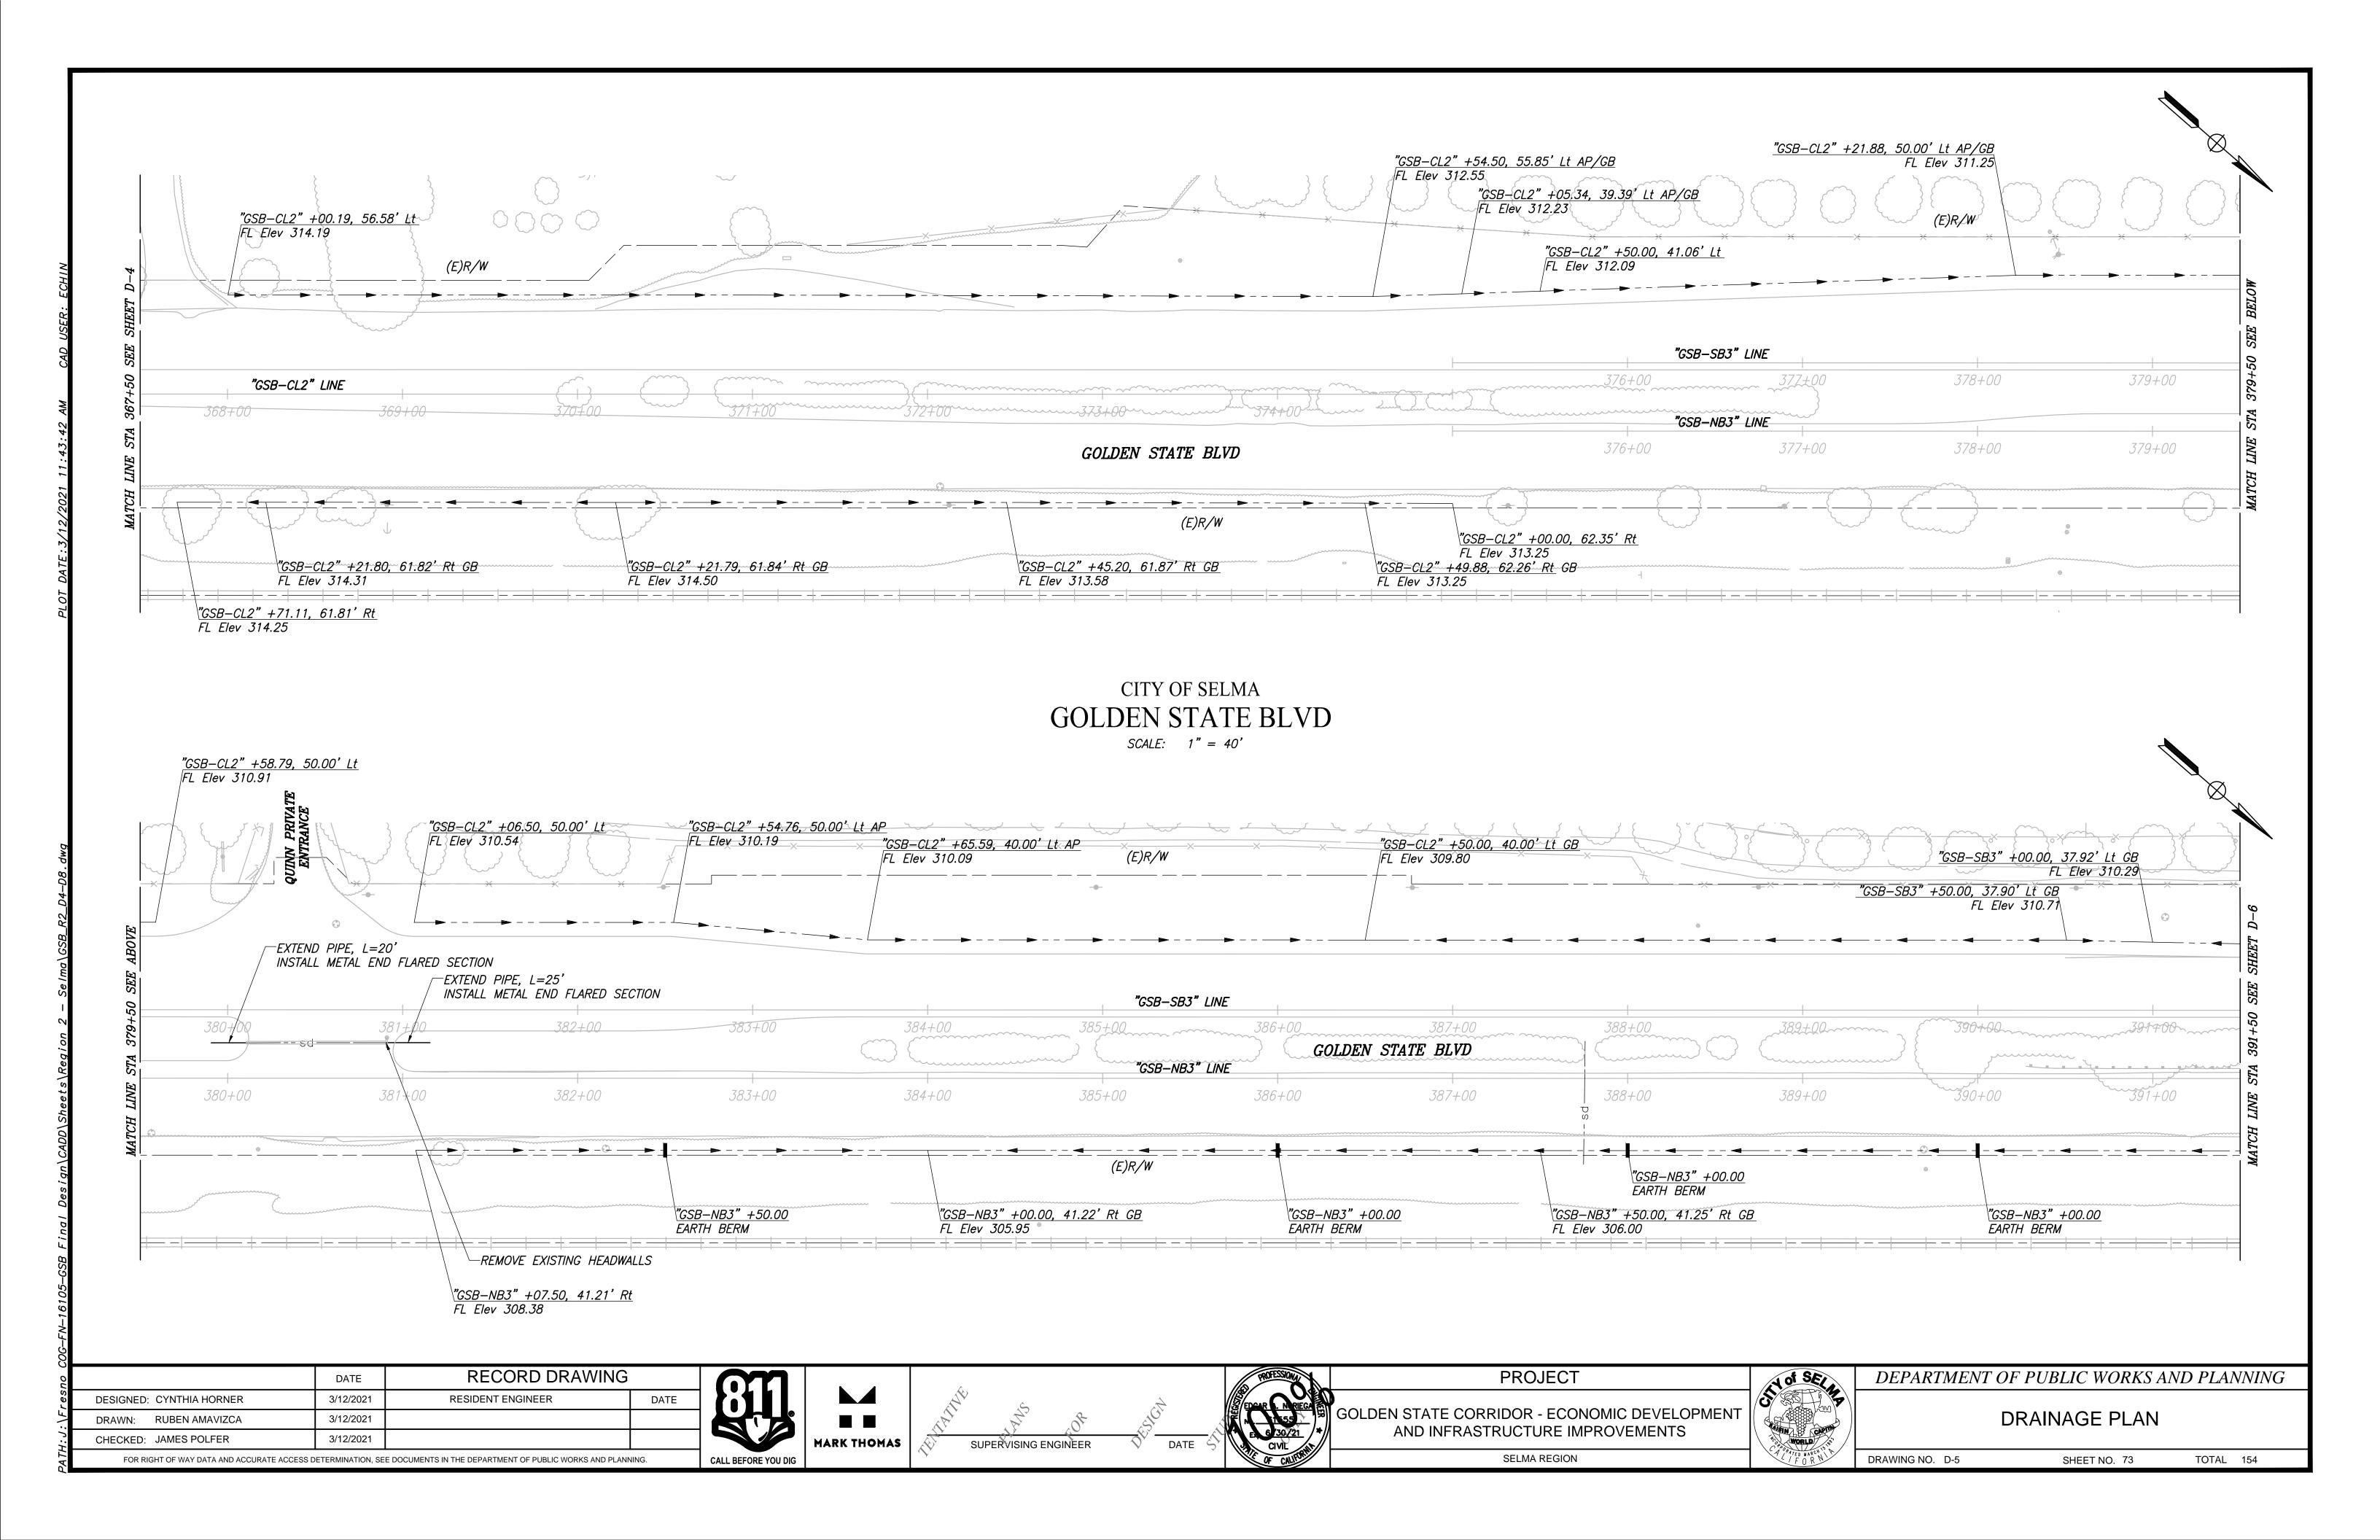

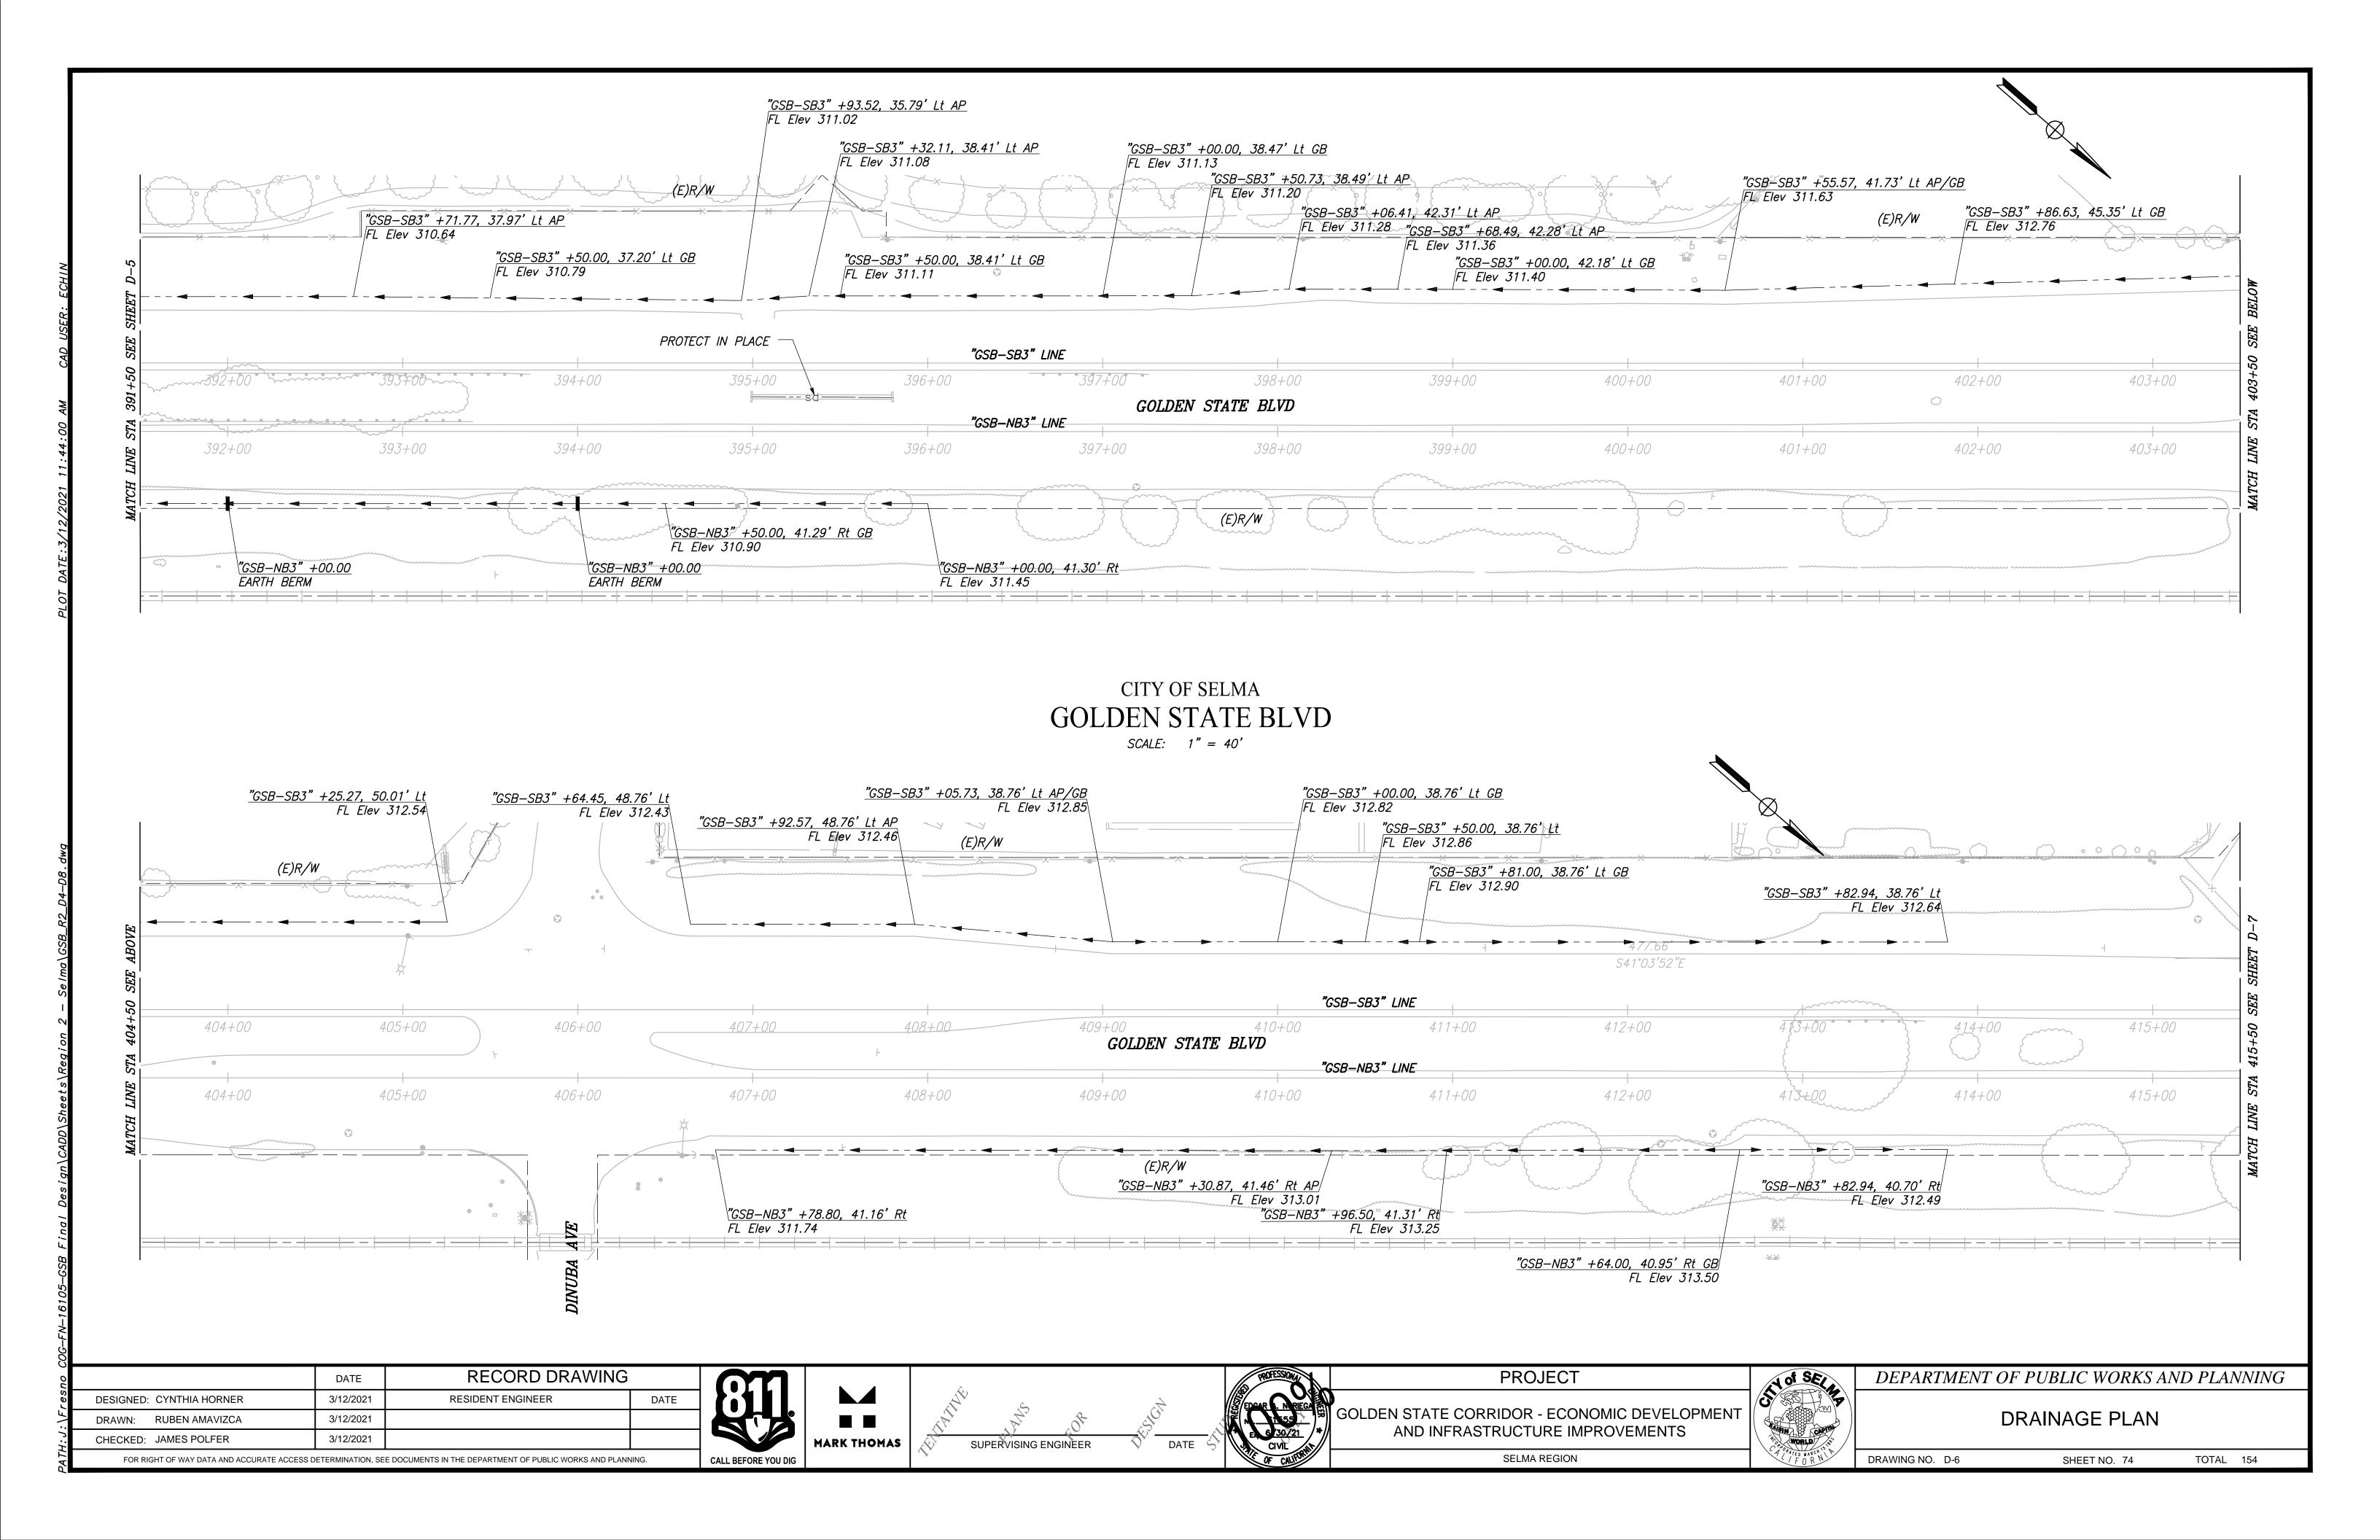

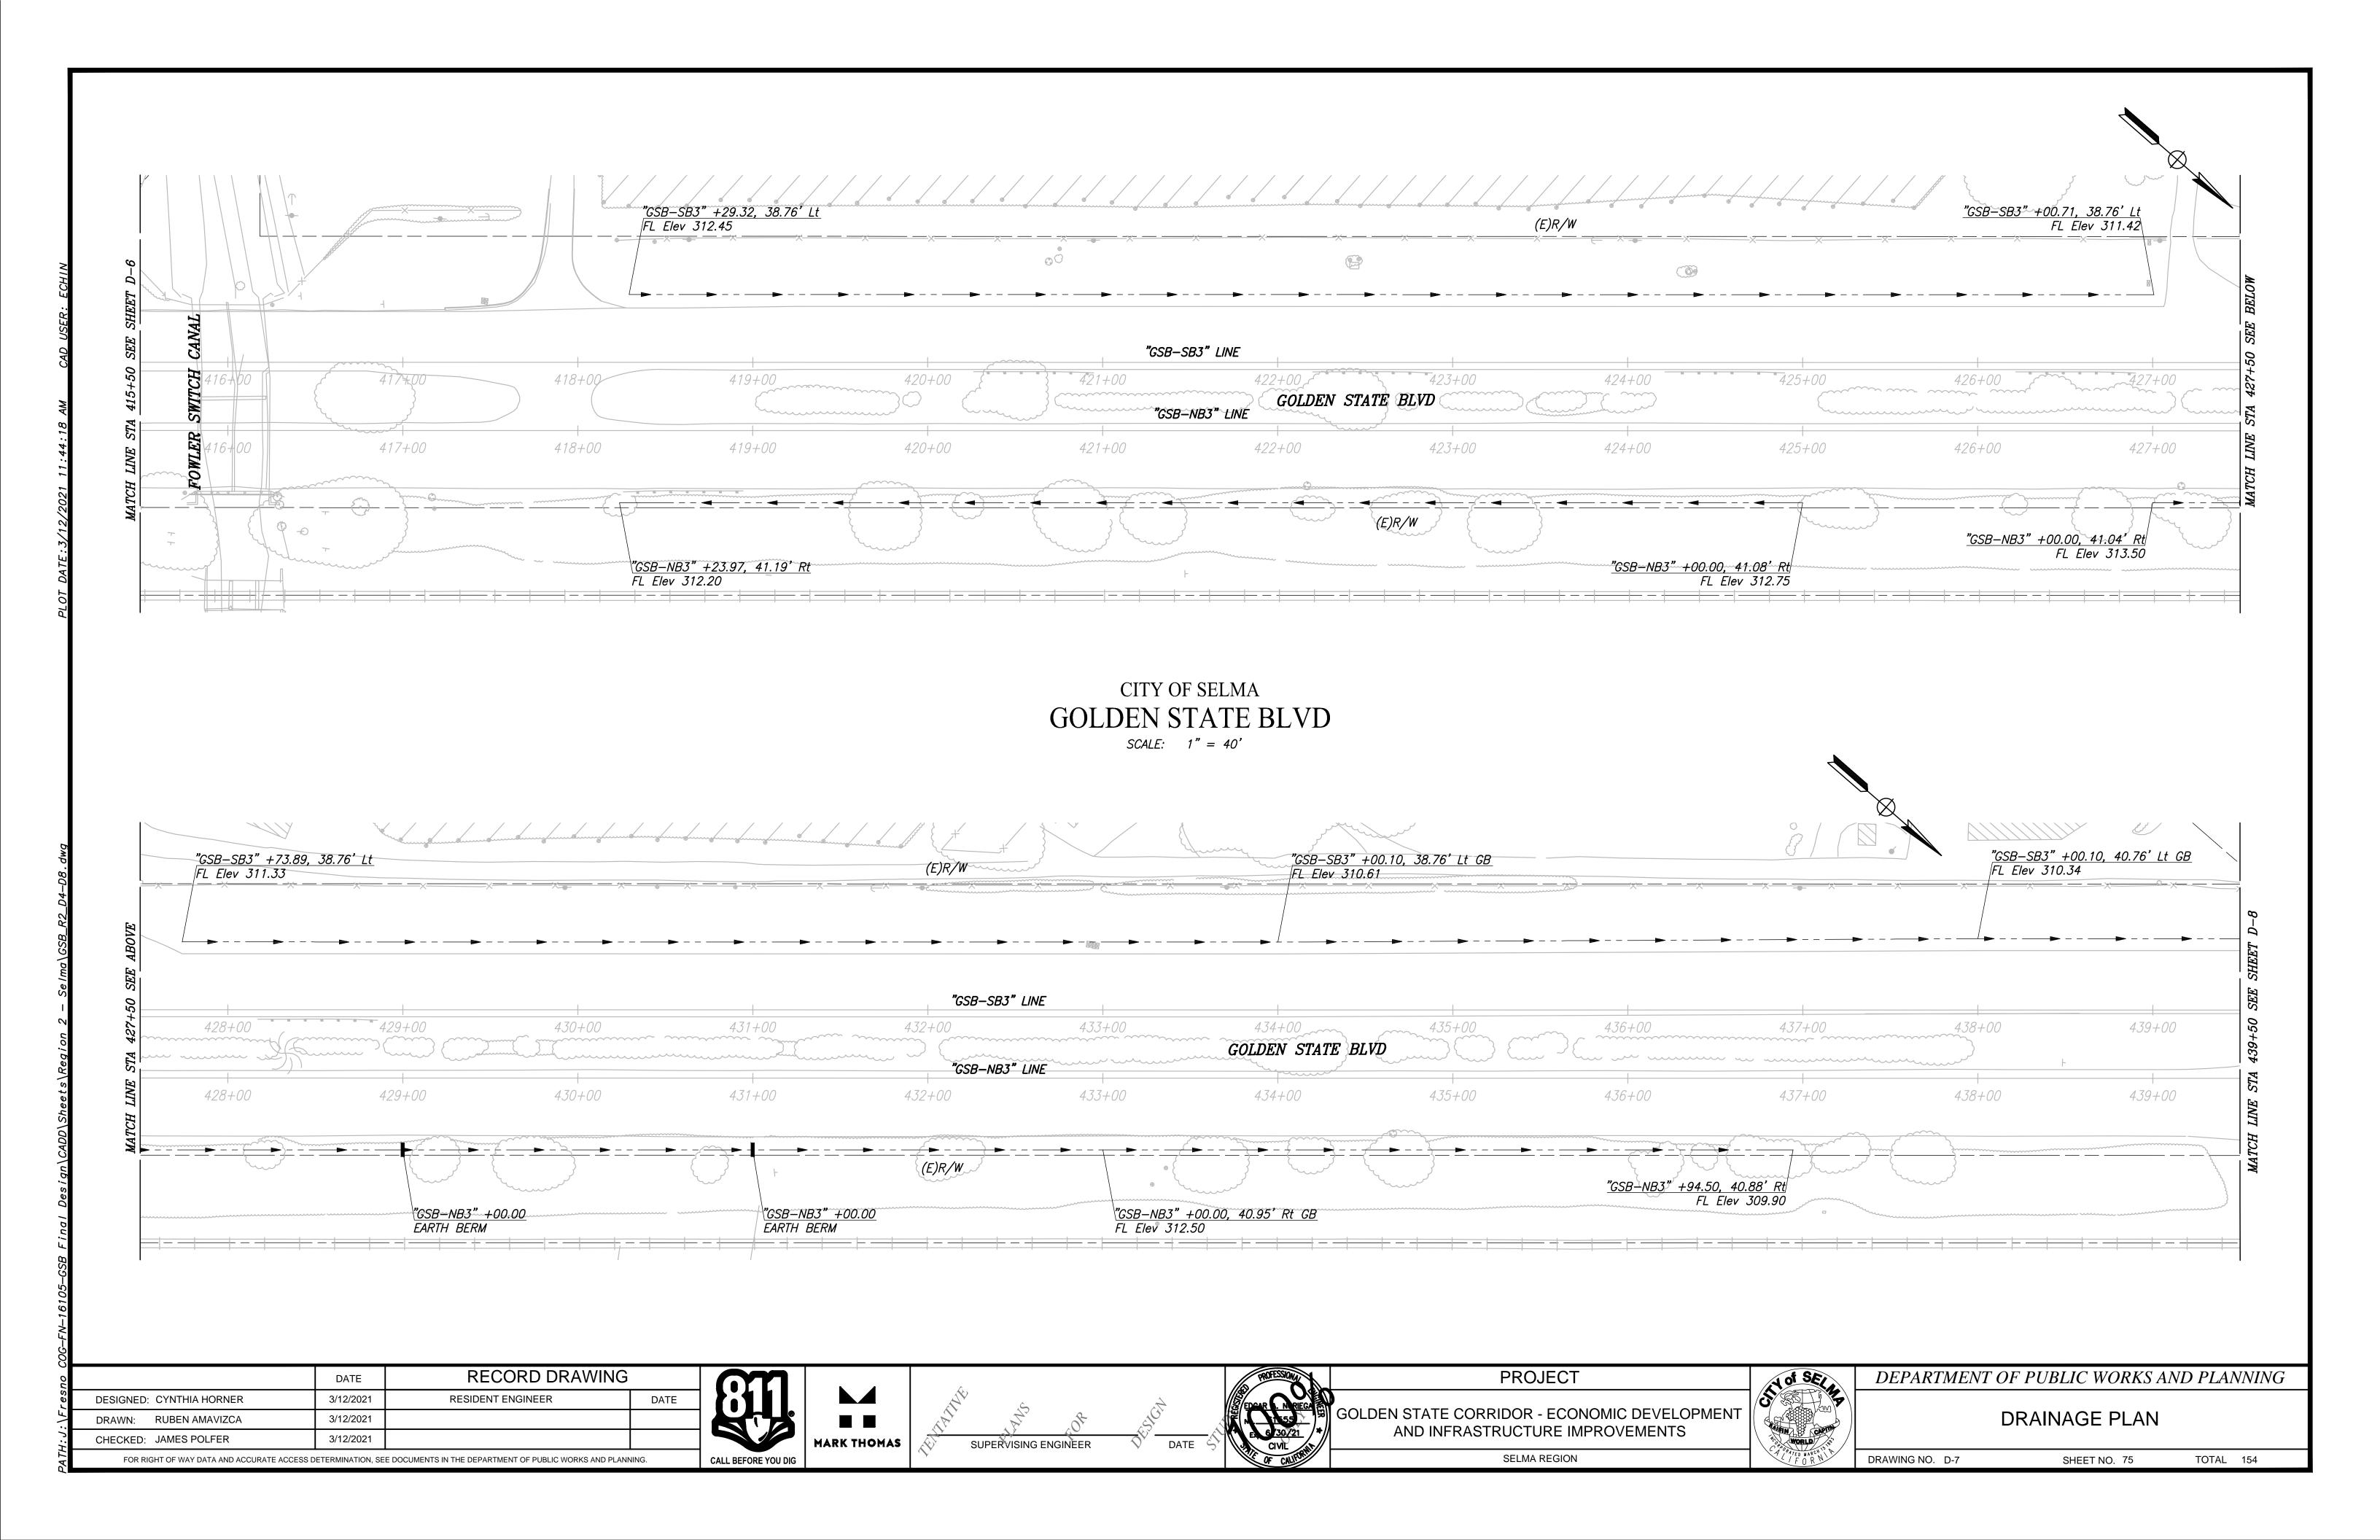

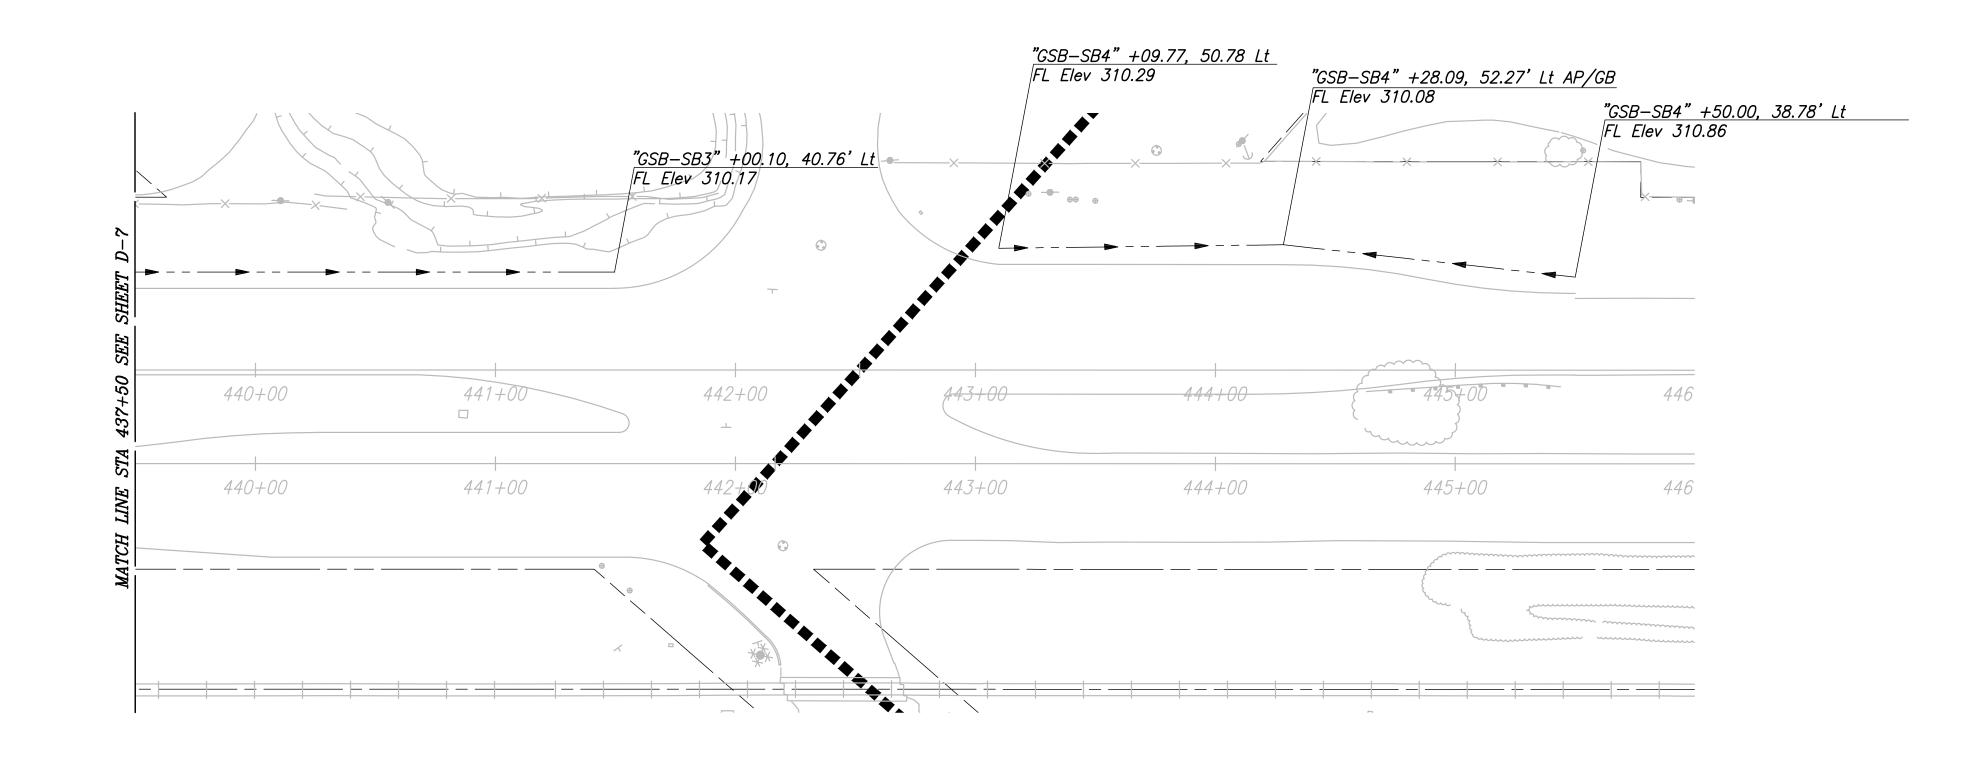


CITY OF SELMA GOLDEN STATE BLVD SCALE: 1" = 40'

RECORD DRAWING RESIDENT ENGINEER DESIGNED: CYNTHIA HORNER 3/12/2021 3/12/2021 DRAWN: RUBEN AMAVIZCA CHECKED: JAMES POLFER FOR RIGHT OF WAY DATA AND ACCURATE ACCESS DETERMINATION, SEE DOCUMENTS IN THE DEPARTMENT OF PUBLIC WORKS AND PLANNING.



MARK THOMAS



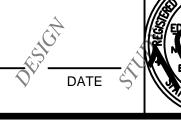





PROJECT


SELMA REGION





DEPARTMENT OF PUBLIC WORKS AND PLANNING

DRAINAGE PLAN


DRAWING NO. D-8 SHEET NO. 76 TOTAL 154

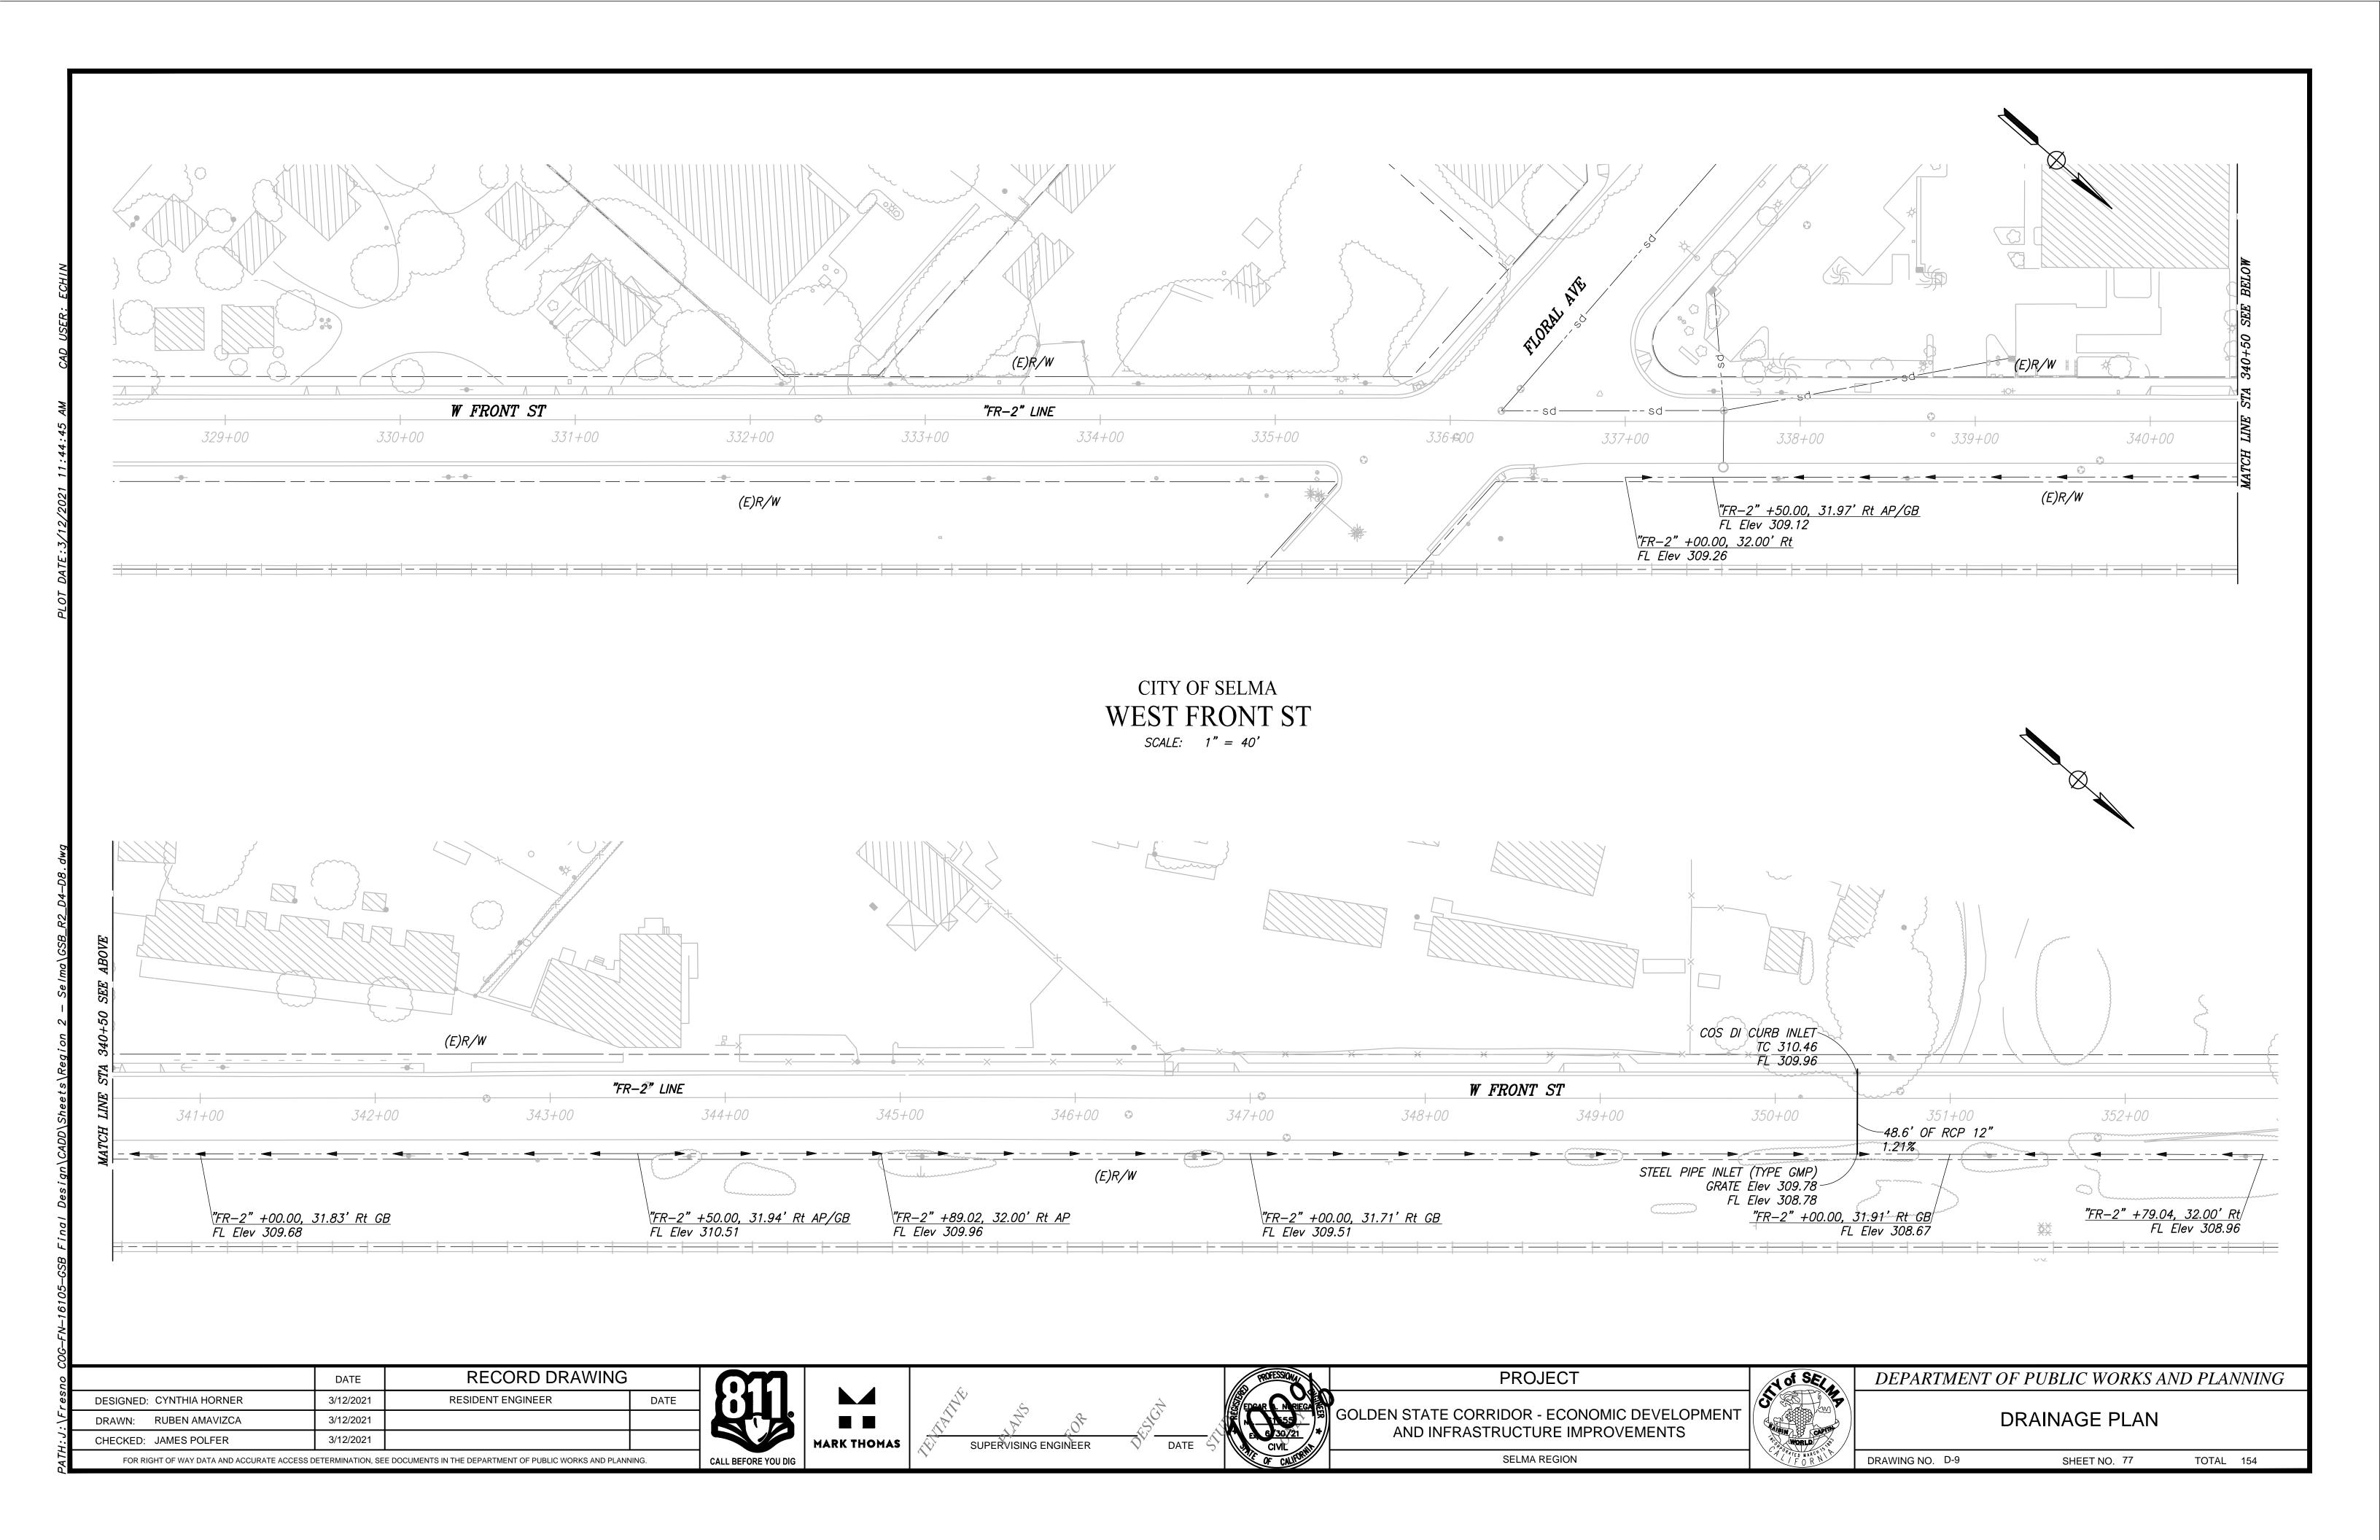

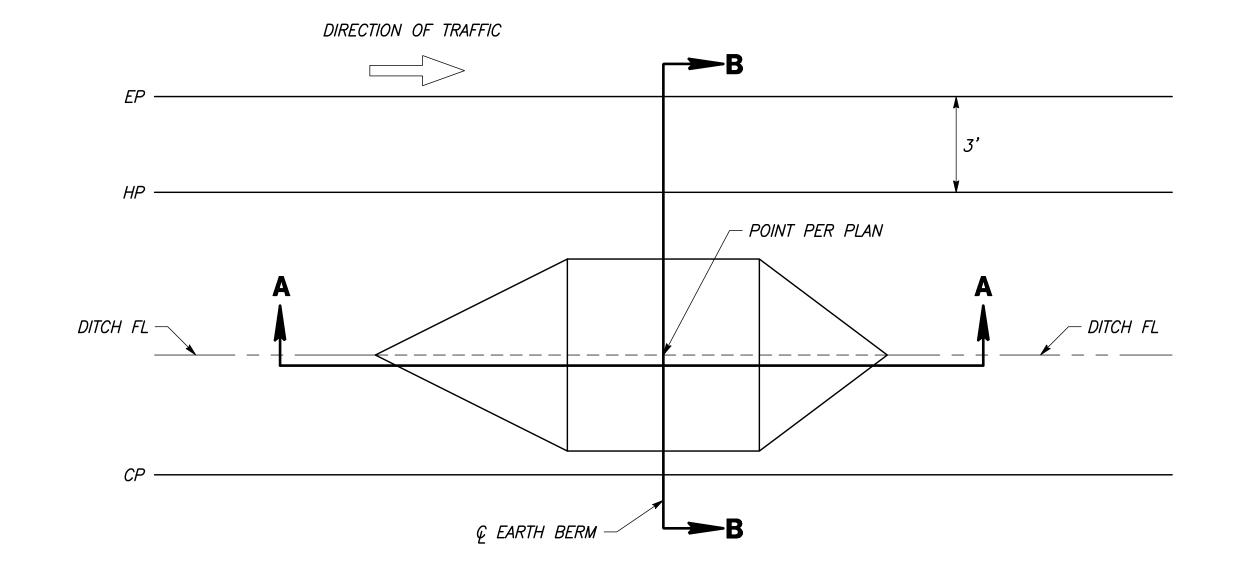

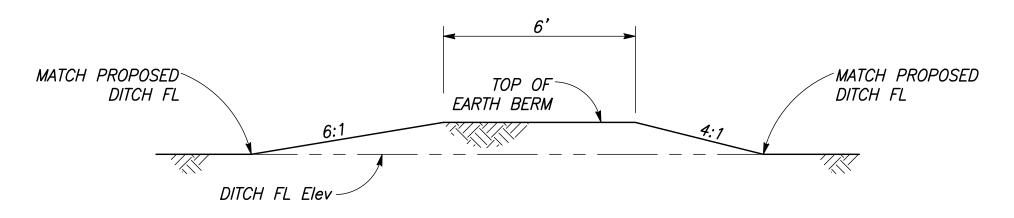

SECTION A-A

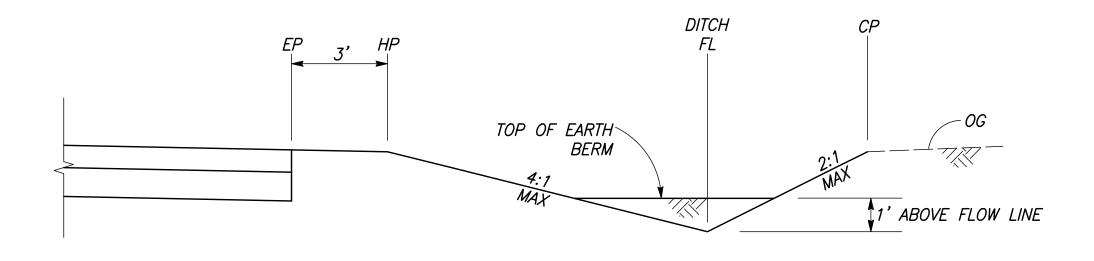



SECTION B-B

EARTH BERM

	DATE	RECORD DRAWING		
DESIGNED: ERIK CHIN	3/12/2021	RESIDENT ENGINEER	DATE	
DRAWN: DEREK MAXWELL	3/12/2021			
CHECKED: JAMES POLFER	3/12/2021			
FOR RIGHT OF WAY DATA AND ACCURATE ACCESS DETERMINATION, SEE DOCUMENTS IN THE DEPARTMENT OF PUBLIC WORKS AND PLANNING.				



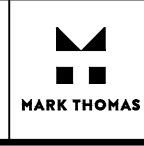

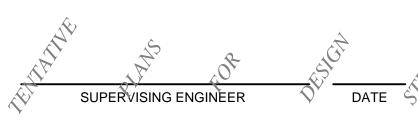



GOLDEN STATE CORRIDOR - ECONOMIC DEVELOPMENT AND INFRASTRUCTURE IMPROVEMENTS SELMA REGION

PROJECT



DEPARTMENT OF PUBLIC WORKS AND PLANNING

DRAINAGE DETAILS

TOTAL 154 SHEET NO. 78 DRAWING NO. DD-1